

### Town of Hilton Head Island Regular Design Review Board Meeting

### August 28, 2018 1:15 p.m. – Benjamin M. Racusin Council Chambers

### **AGENDA**

As a Courtesy to Others Please Turn Off All Cell Phones and Pagers during the Meeting.

- 1. Call to Order
- 2. Roll Call
- 3. Freedom of Information Act Compliance

Public notification of this meeting has been published, posted, and mailed in compliance with the Freedom of Information Act and the Town of Hilton Head Island requirements.

- 4. Approval of Agenda
- **5. Approval of Minutes** Meeting of August 14, 2018
- 6. New Business
  - A. Alteration / Addition
    - Lighthouse Drive Monopole, DRB 001908-2018
    - Sea Pines Drive Monopole, DRB 001909-2018
    - Hargray Building, DRB 001925-2018
    - 6 Lagoon Road, DRB-001931-2018
- 7. Appearance by Citizens
- 8. Board Business
  - A. Revision to the DRB Rules of Procedure regarding Board attendance
- 9. Staff Report
- 10. Adjournment

Please note that a quorum of Town Council may result if four or more Town Council members attend this meeting.

# Town of Hilton Head Island Minutes of the Design Review Board Meeting August 14, 2018 at 1:15 p.m. Benjamin M. Racusin Council Chambers

**Board Members Present**: Chairman Dale Strecker, Vice Chairman Michael Gentemann, Cathy Foss, Debbie Remke, Brian Witmer, Kyle Theodore

**Board Members Excused:** Ron Hoffman

Town Council Present: None

Town Staff Present: Chris Darnell, Urban Designer; Teri Lewis, LMO Official; Teresa Haley,

Senior Administrative Assistant

### 1. Call to Order

Chairman Strecker called to order the regular meeting of the Design Review Board at 1:15 p.m.

### 2. Roll Call – See as noted above.

### 3. Freedom of Information Act Compliance

The Town has met all Freedom of Information Act requirements for this meeting.

### 4. Approval of the Agenda

The Board approved the agenda by general consent.

### 5. Approval of Minutes – July 24, 2018

The Board approved the minutes of the July 24, 2018 meeting by general consent.

### 6. New Business

### A. Alteration/Addition

• Village House, DRB-001820-2018

Mr. Darnell introduced the project and described its location. Mr. Darnell presented an in depth narrative of the project as provided in the Board's packet. Staff recommends approval with the following conditions:

- 1. "China White" is too white. Select a different color for the main part of the building.
- 2. Tie the new entrance to the existing building by using the same color on the new columns and trim or other areas on the existing building.

Chairman Strecker asked if the applicant would like to add to Staff's narrative. The applicant presented statements regarding the project and answered questions presented by the Board. The applicant provided a sample of the Shake Gray metal roof. In addition to the China White paint color, the applicant provided additional selections for the Board's review.

Chairman Strecker requested comments from the Board. The Board discussed and made inquiries regarding painting the exterior of the building. The applicant is proposing to paint the

building and columns one color. The Board indicated the China White color as well as the additional color selections proposed today appear too white. The Board suggested going at least one or two shades darker than proposed. Some members were ok with staff approving the color. The Board requested paint samples for the approval.

The Board inquired about the proposed update to the existing columns of the entry. The applicant indicated the existing concrete columns will remain and furred out with pressure treated wood and stucco. The column base is wood with stucco applied and the pattern detail is to match the existing building with a hard coated foam. The rafter tails will be a painted wood and exposed all the way through with beaded board above. The Board expressed concern for squaring the columns and the base being exposed to possible damage and how it will hold up over time. The Board indicated the proposed rendering looks good, however, they need to review a section detail for all of these items.

The Board discussed the proposed new metal roof and the porte-cochere. One board member expressed concern for the peak of the roof interfering with the windows behind it. The applicant was amenable to lowering the top of the roof 6 inches to accommodate this concern. One board member expressed the roof extends away from the building enough so that the pitch won't physically intrude on the windows behind it. The new roof color proposed, Shake Gray, is meant to complement the existing building roof shingles which contain gray. The existing shingles are to remain as this application does not propose an entire building reroof. The Board suggested to put the new metal roof on the second level above the porte-cochere. The underside of the porte-cochere is currently a netted canvas that will be removed. The existing lighting will remain.

The canvas extends all the way back to the building. The same sub-structure will be used so the canopy material along the walkway will be kept. The color of the canvas will match the Shake Gray. The Board voiced concerns regarding the point at which the canvas material intersects with the metal material, how that would look and be weatherproofed. The Board asked to review an elevation and at least one section detailing this. Some board members recommended eliminating the canvas and extending the metal roof all the way back.

The Board complimented the overall improvement and emphasized the need to review more details of the proposal prior to approval. There was some discussion on possible staff level approvals. Upon the conclusion of the discussion, the Board expressed the desire to review all of the detailing instead of placing the burden on Staff to cover the intent of the Board. The Board recommended the applicant address their concerns and provide the details discussed today, and then resubmit the application.

The applicant withdrew the application.

### 7. Appearance by Citizens – None

#### 8. Board Business

A. Review of draft revision to the DRB Rules of Procedure regarding Board attendance

The Board discussed the proposed revision and concluded to change the attendance/absences notification deadline to 10:00 a.m. the business day before the meeting. This will allow Staff

adequate time to cancel the meeting within the 24-hour FOIA requirement in the event that the projected absences will produce a lack of a quorum.

### 9. Staff Report

### A. Current Open Air Sales Requirements update by Teri Lewis

Ms. Lewis presented statements regarding current requirements pertaining to Open Air Sales including food trucks, kiosks, and stands for selling fruits and vegetables. The Board made inquiries and shared concerns related to Open Air Sales. Ms. Lewis indicated she is proposing to take forward LMO amendments as part of the 2018 set and have specific regulations as part of Open Air Sales and what constitutes temporary. Staff will gather the Board's input around the first meeting in September to incorporate into the proposed LMO amendments.

### B. Minor Corridor Approvals

Mr. Darnell reported the Minor Corridor approvals since the last Board meeting.

The Board inquired about a steel structure being constructed on an outparcel building in Sea Turtle Marketplace (STMP). Staff indicated that was part of the original design and not constructed as part of the original building. Some of the porches/covered areas were removed as value engineering and then re-added by the tenant. The original approval included a hard roof, so it was handled as a minor corridor approval. Since that approval, Staff has and will continue to bring these types of changes to the DRB as they may impact DRB consideration. The Board also inquired about a storage container in the STMP parking lot. Staff will follow up as to what is permitted there.

### **10.** Adjournment – The meeting was adjourned at 2:15 p.m.

Submitted by: Teresa Haley, Secretary
Approved:
Dale Strecker, Chairman



### Town of Hilton Head Island

Community Development Department One Town Center Court

Hilton Head Island, SC 29928 Phone: 843-341-4757 Fax: 843-842-8908

www.hiltonheadislandsc.gov

FOR OFFICE	AL USE ONLY
Date Received:	
Accepted by:	
DRB #:	
Meeting Date:	

Applicant/Agent Name: Raymond Novello Company: RG Novello INC

Mailing Address: 19 Coopers Hawk Rd City: Hilton Head Island State: SC Zip: 29926 Telephone: (850) 519-3637 Fax: 855-718-5615 E-mail: Ramey@Novelloelectric.com

Project Name: Hilton Head Lighthouse Water Tank Project Project Address: 91 Lighthouse Road Hilton Head SC

29926

Parcel Number [PIN]: Zoning District: Overlay District(s):

# CORRIDOR REVIEW, MAJOR DESIGN REVIEW BOARD (DRB) SUBMITTAL REQUIREMENTS

Digital Submissions may be accepted via e-mail by calling 843-341-4757	<u>7.</u>
Project Category:  Concept Approval – Proposed Development  Final Approval – Proposed Development	_X_ Alteration/Addition Sign
Submittal Requirements for <i>All</i> projects:  Private Architectural Review Board (ARB) Notice of Action (if ap jurisdiction of an ARB, the applicant shall submit such ARB's wri 2-103.I.4.b.iii.01. Submitting an application to the ARB to meet the applicant.	tten notice of action per LMO Section 16- nis requirement is the <u>responsibility of the</u>
Filing Fee: Concept Approval-Proposed Development \$175, Final Alterations/Additions \$100, Signs \$25; cash or check made paya	Approval – Proposed Development \$173, able to the Town of Hilton Head Island.
Additional Submittal Requirements:  Concept Approval – Proposed Development  A survey (1"=30' minimum scale) of property lines, existing topog tree protection regulations of Sec. 16-6-104.C.2, and if applicable, beaches.  A site analysis study to include specimen trees, access, significant views, orientation and other site features that may influence design A draft written narrative describing the design intent of the project reflects the site analysis results.  Context photographs of neighboring uses and architectural styles.  Conceptual site plan (to scale) showing proposed location of new scale) Conceptual sketches of primary exterior elevations showing architectural sketches of primary exterior elevations showing elevations and landscaping.	topography, wetlands, buffers, setbacks,  i.  i, its goals and objectives and how it  structures, parking areas and landscaping.

ast Revised 01 21 15

Additional Submittal Requirements:  Final Approval – Proposed Development  A final written narrative describing how the project conforms with the conceptual approval and dereview guidelines of Sec. 16-3-106.F.3.  Final site development plan meeting the requirements of Appendix D: D-6.F.  Final site lighting and landscaping plans meeting the requirements of Appendix D: D-6.H and D-6.  Final floor plans and elevation drawings (1/8"=1'-0" minimum scale) showing exterior building macolors with architectural sections and details to adequately describe the project.  A color board (11"x17" maximum) containing actual color samples of all exterior finishes, keyed elevations, and indicating the manufacturer's name and color designation.  Any additional information requested by the Design Review Board at the time of concept approval scale model or color renderings, that the Board finds necessary in order to act on a final application.	aterials and to the
Additional Submittal Requirements:  Alterations/Additions  All of the materials required for final approval of proposed development as listed above, plus the additional materials.  A survey (1"=30' minimum scale) of property lines, existing topography and the location of trees to tree protection regulations of Sec. 16-6-104.C.2, and if applicable, location of bordering streets, metabaches.  Photographs of existing structure.	meeting the
Additional Submittal Requirements:  Signs  Accurate color rendering of sign showing dimensions, type of lettering, materials and actual color For freestanding signs:  Site plan (1"=30" minimum scale) showing location of sign in relation to buildings, parking, exist and property lines.  Proposed landscaping plan.  For wall signs:  Photograph or drawing of the building depicting the proposed location of the sign.  Location, fixture type, and wattage of any proposed lighting.	
Note: All application items must be received by the deadline date in order to be reviewed by the DRB per LMO Apper A representative for each agenda item is strongly encouraged to attend the meeting.  Are there recorded private covenants and/or restrictions that are contrary to, conflict with, of the proposed request? If yes, a copy of the private covenants and/or restrictions must be submitted.	r prohibit
To the best of my knowledge, the information on this application and all additional document factual, and complete. I hereby agree to abide by all conditions of any approvals granted by the Te Head Island. I understand that such conditions shall apply to the subject property only and a obligation transferable by sale.	own of Hilton
I further understand that in the event of a State of Emergency due to a Disaster, the review and a set forth in the Land Management Ordinance may be suspended.  SIGNATURE  DATE	pproval time

Last Revised 01/21/15

Electrical Design Consultants, LLC 31699 Chagrin Boulevard Pepper Pike, OH 44124

Town of Hilton Head Island Community Development Department One Town Center Court Hilton Head Islands, SC 29928 Attn: Chris Darnell, RLA

August 13, 2018

Dear Mr. Darnell,

South Island Public Service District (SIPSD) is preparing to paint maintenance on the South Beach and Lighthouse water tanks. SIPSD has hired a painting contractor to paint the interior and exterior of both elevated tanks. The existing exterior paint will be overcoat and thus not require any exterior containment structure or exterior sandblasting. Both tanks will be painted the same color as the existing paint color.

Both tanks have cellular carrier equipment located on the tanks which will need to be removed prior to the start of the painting projects. Temporary cellular towers will be installed near each tank to accommodate the cellular carrier equipment during the painting projects. Below please find the projected schedules for each tank.

### South Beach Tank

Target Painting Start: October 1, 2018. Painting will last 75 days. End December 15, 2018

Removal of cellular carrier equipment (Four cellular carriers, AT&T, T-Mobile, Sprint, VZW). Relocation of carrier equipment from existing water tank to temporary pole will take four (4) weeks, with one (1) week scheduled per carrier.

- Temporary pole installation within 2 weeks from Town approval.
- Cellular carrier equipment relocation timeline from South Beach tank to temporary pole.
  - First week after setting the Temp pole
  - Second week after 1st carrier's equipment is relocated;
  - Third week after 2nd carrier's equipment is relocated;
  - Fourth week after 3rd carrier's equipment is relocated;

- Carrier equipment will go back on the tank one by one in the same fashion and timelines that the carriers came off the water Tank. Four (4) weeks total to move back on to the Water tank after painting is complete.
- Removal of temporary pole and restoration of land to original condition. Two (2) weeks.

### **Lighthouse Tank**

Target Painting Start: December 16, 2018. Painting will last 75 days. End March 1, 2019. Removal of cellular equipment (3 cellular carriers AT&T, T-Mobile, VZW)

- Temporary pole installation within 2 weeks
- Cellular carrier equipment relocation timeline from South Beach tank to temporary pole.
  - First week after setting the Temp pole
  - Second week after 1st carrier's equipment is relocated;
  - Third week after 2nd carrier's equipment is relocated;
- Carrier equipment will go back on the tank one by one in the same fashion and timelines
  that the carriers came off the water Tank. Four (4) weeks total to move back on to the
  Water tank after painting is complete.
- Removal of temporary pole and restoration of land to original condition. Two (2) weeks.

### **Project Point of Contact**

Electrical Design Consultants Jason W. Smith 470-218-4537 Cell 855-718-5615 Fax jws@graneto.com

Please let me know if you have any questions or concerns regarding the proposed schedule.

Respectfully

lachn W. Smith





#### **CODES STATEMENT**

THE CONTRACTOR'S WORK SHALL COMPLY WITH ALL APPLICABLE NATIONAL, STATE AND LOCAL CODES AS ADOPTED BY THE AUTHORITY HAVING JURISDICTION IN THE REGION WHERE THE WORK IS TO BE PERFORMED. THE CURRENT EDITION OF THE CODES AND STANDARDS IN EFFECT ON THE DATE OF AWARD OF CONTRACT SHALL GOVERN THE DESIGN PARAMETERS.

BUILDING CODE: 2015 INTERNATIONAL BUILDING CODE WITH SC MODIFICATIONS,

ELECTRICAL CODE: NATIONAL ELECTRICAL CODE, 2014 EDITION.

MECHANICAL CODE: 2015 INTERNATIONAL MECHANICAL CODE.

FIRE CODE: 2015 INTERNATIONAL FIRE CODE WITH SC MODIFICATIONS.

LIGHTNING PROTECTION CODE: NFPA 780 2017 EDITION.

THE CONTRACTOR'S WORK SHALL COMPLY WITH THE LATEST EDITION OF THE FOLLOWING STANDARDS:

AMERICAN CONCRETE INSTITUTE (ACI) 318-14, BUILDING COCE REQUIREMENTS FOR STRUCTURAL CONCRETE, AMERICAN INSTITUTE OF STELL CONSTRUCTION, LIPED 14TH EDITION, TELECOMMUNICATIONS INDUSTRY ASSOCIATION (TIA) 222-2, STRUCTURAL STANCARDS FOR STEEL ANTENNA TOWER AND ANTENNA SUPPORTING STRUCTURES: TIA 607, COMMERCIAL BUILDING GROUNDING AND BONDING REQUIREMENTS FOR ELECTRONIC EQUIPMENT.

IEEE C62.41, RECOMMENDED PRACTICES ON SURGE VOLTAGES IN LOW VOLTAGE AC POWER CIRCUITS (FOR LOCATION CATEGORY C3 AND HIGH EVENCY REVENUE REPORTED FOR THE PROPERTY OF THE PROPE

TELCORDIA GR-1275, GENERAL INSTALLATION REQUIREMENTS, TELCORDIA GR-1603, COAXIAL CONNECTIONS, ANSI T1-311, FOR TELECOM DC POWER SYSTEMS AND TELECOM ENVIRONMENTAL PROTECTION.

### PROJECT DESCRIPTION

 INSTALL TEMPORARY MONOPOLE AND REPOUTE CABLING TO RELOCATED ANTENNAS WHILE CONSTRUCTION ON EXISTING WATERTANK TAKES PLACE.

#### **DESIGN CRITERIA**

DESIGN WIND SPEED: 141 MPH ULTIMATE (3-SECOND GUST) 109 MPH NOMINAL (3-SECOND GUST)

IMPORTANCE FACTOR: 1.0 EXPOSURE CATEGORY: C RISK FACTOR: II






### electrical design consultants

# LIGHTHOUSE TEMP POLE SEA PINES #4

SITE ADDRESS: 91 LIGHTHOUSE ROAD HILTON HEAD ISLAND, SC 29926 COUNTY: BEAUFORT

PROPOSED TEMPORARY MONOPOLE

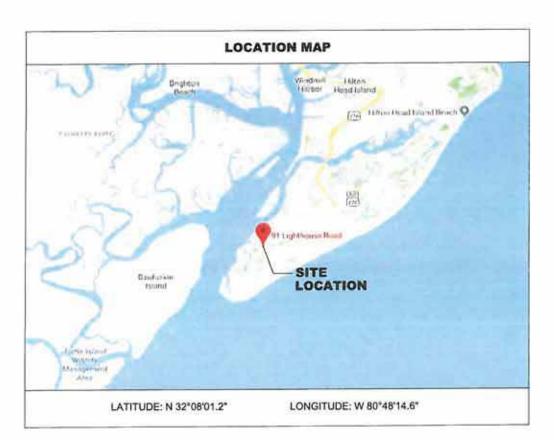

#### PROJECT DATA

JURISDICTION:

BEAUFORT COUNTY

TOWER OWNER:

SOUTH ISLAND PUBLIC SERVICE

DISTRICT

CONTACT:

EDDIE NETTLES 2 GENESTA STREET

HILTON HEAD ISLAND, SC 39938

(843) 816-3533

A&E FIRM:

KCI TECHNOLOGIES JAMES FENNELL, P.E.

JAMES FENNELL@KCI.COM

	SHEET INDEX	
050	TITLE SHEET	0
N-1	GENERAL NOTES	(0,
C-1	EXISTING SITE PLAN	0
C-2	PROPOSED SITE PLAN	0
C-3	TOWER ELEVATION	0
C-3A	SECTOR PLANS	0
C-38	EQUIPMENT INVENTORY	0
C-4	DETAILS	0
C-5	EQUIPMENT INVENTORY	0
G-1	GROUNDING PLAN	0
G-2	GROUNDING DETAILS	0



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#### LIGHTHOUSE TEMP POLE

91 LIGHTHOUSE ROAD HILTON HEAD, SC 29926

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KCI TECHNOLOGIES, INC. 4041 CRESCENT PARK DRIVE RIVERVIEW, FLORIDA 33578 (813) 740-2300

DRAWN BY: J. HAWS
CHECKED BY: L. VASQUEZ
APPROVED BY: J. FENNELL.

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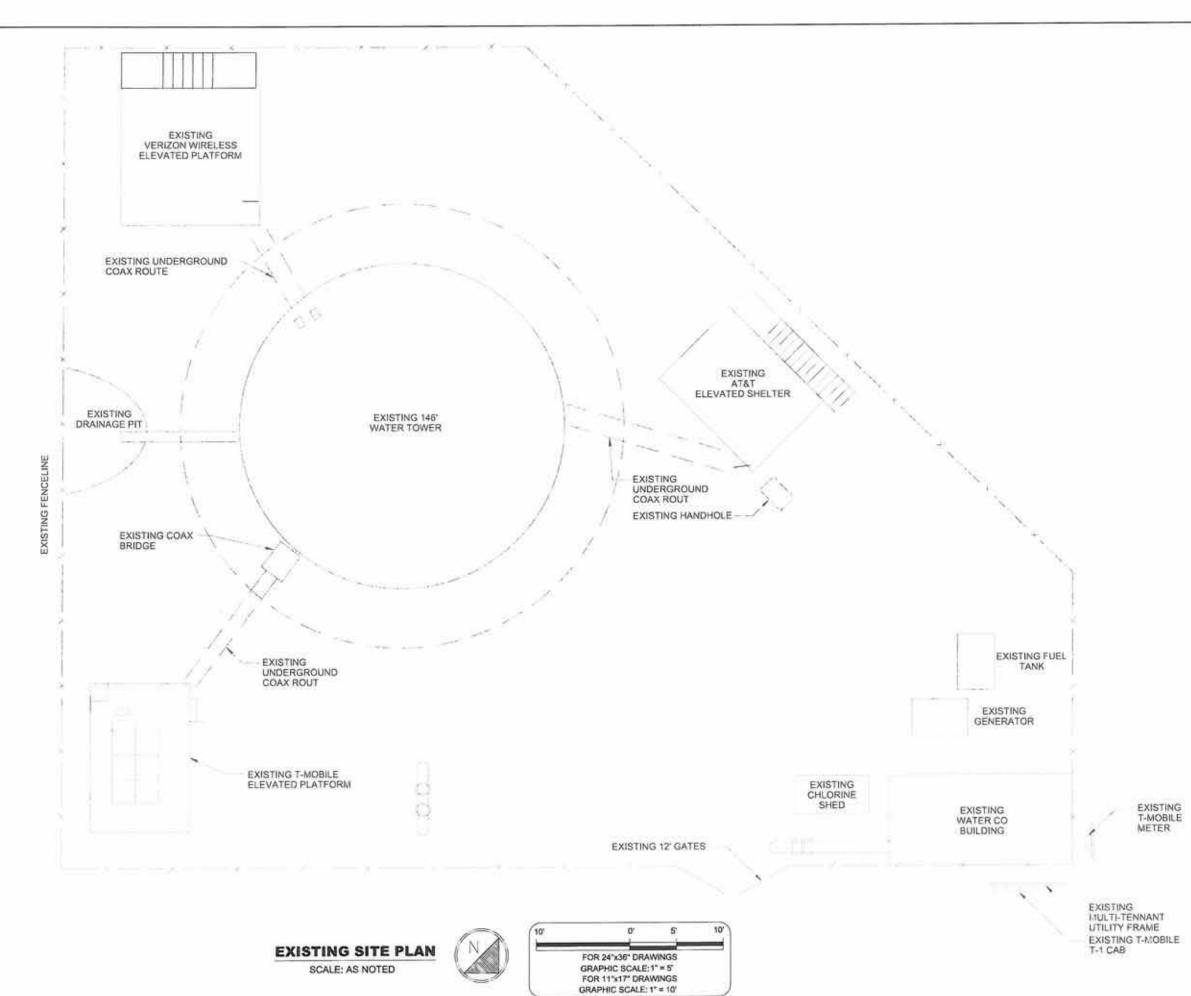
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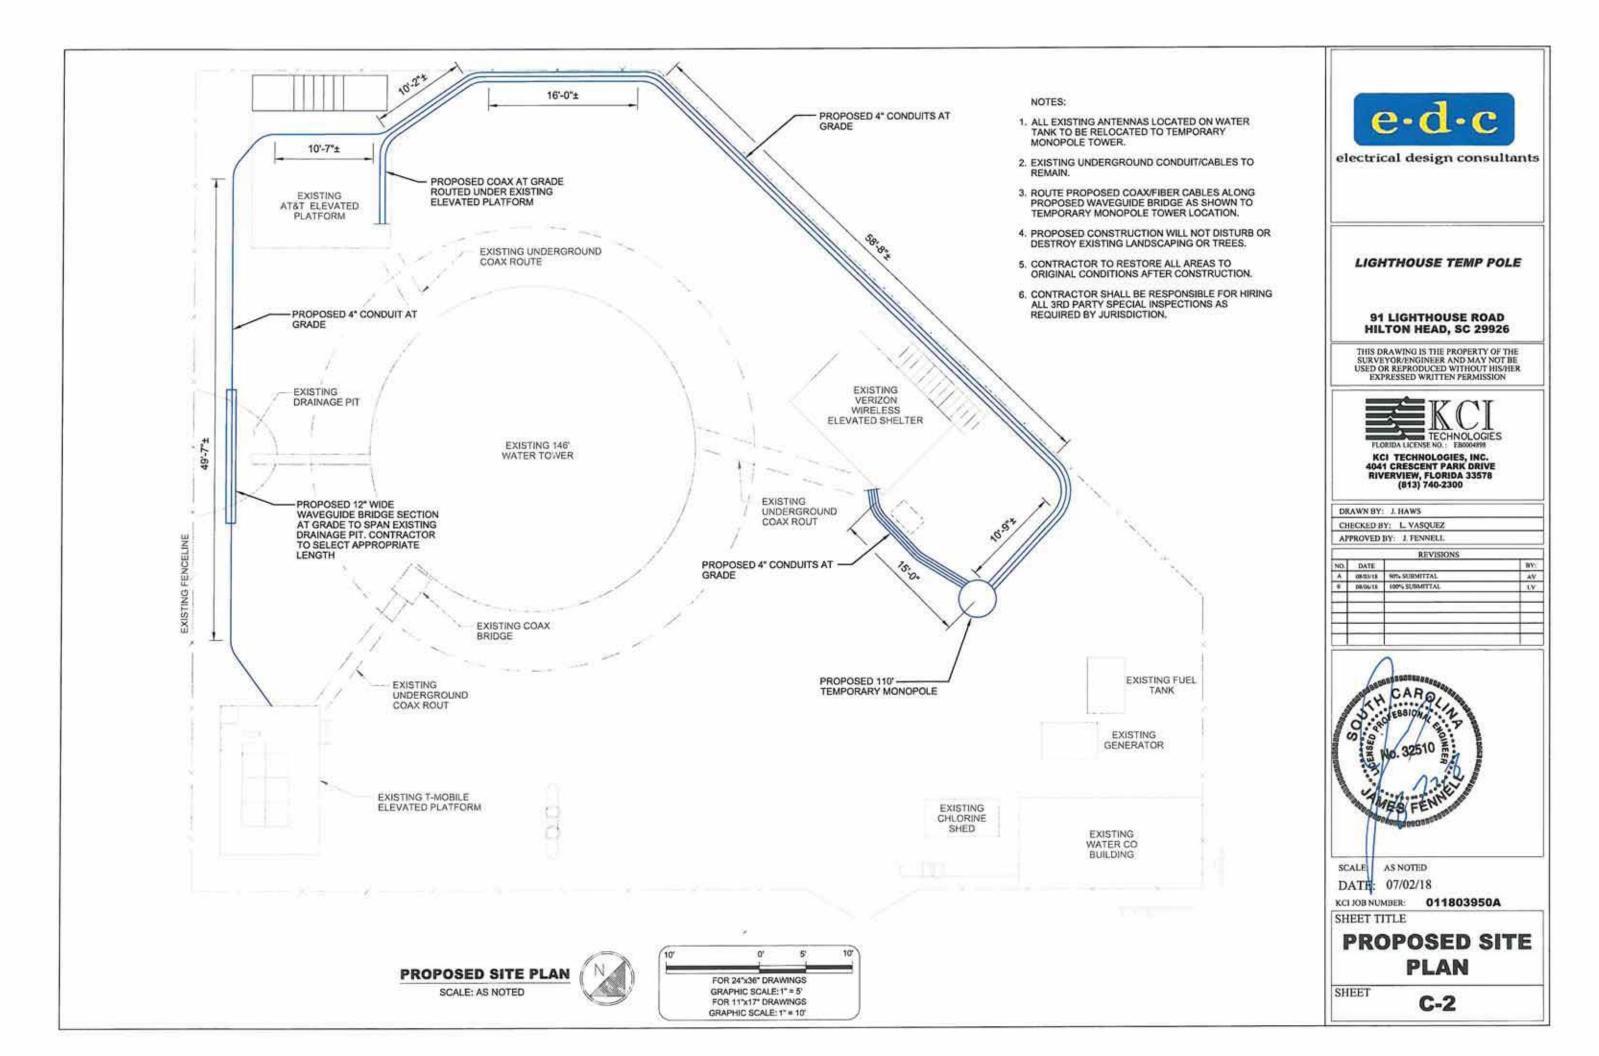
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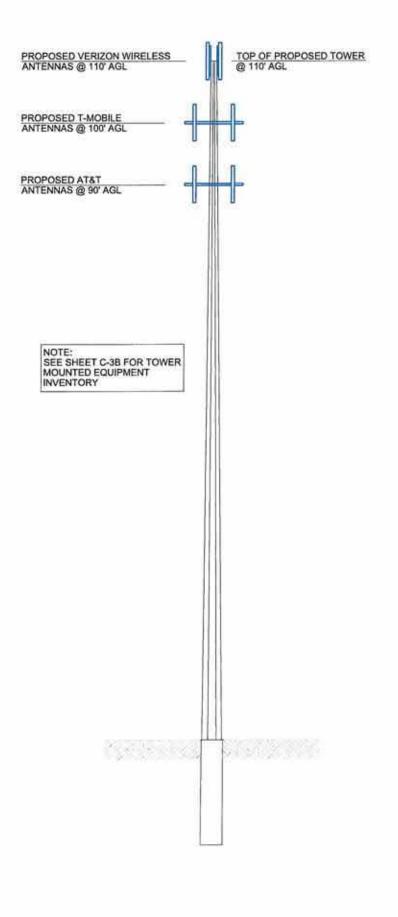
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EXISTING SITE PLAN

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C-1







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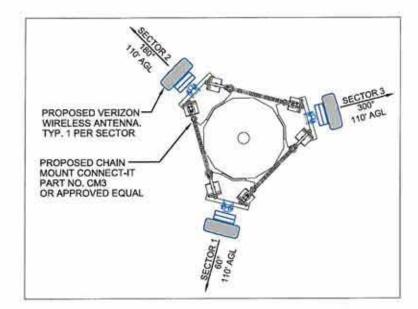
TOWER **ELEVATION** 

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**TOWER ELEVATION** 


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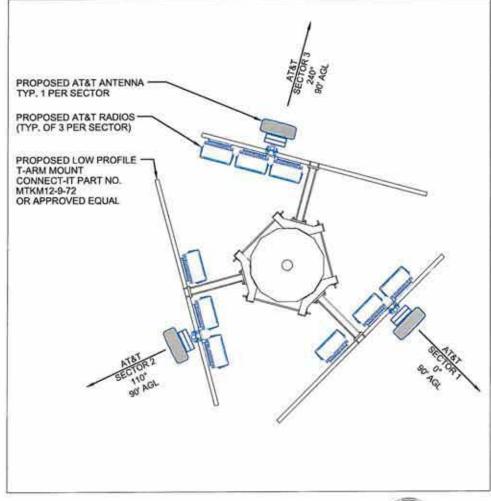
### ANTENNA SECTOR PLAN -VERIZON WIRELESS

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ANTENNA SECTOR PLAN -

NOT TO SCALE



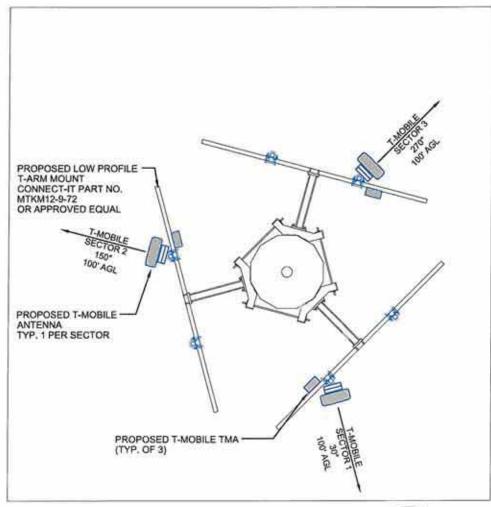

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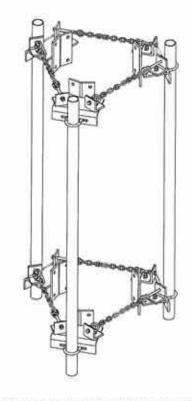
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SHEET TITLE

SECTOR PLANS


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### TRI-SECTOR CHAIN MOUNT

NOT TO SCALE CONNECT-IT PART NO. CM3



### T-ARRM KIT ANTENNA MOUNT

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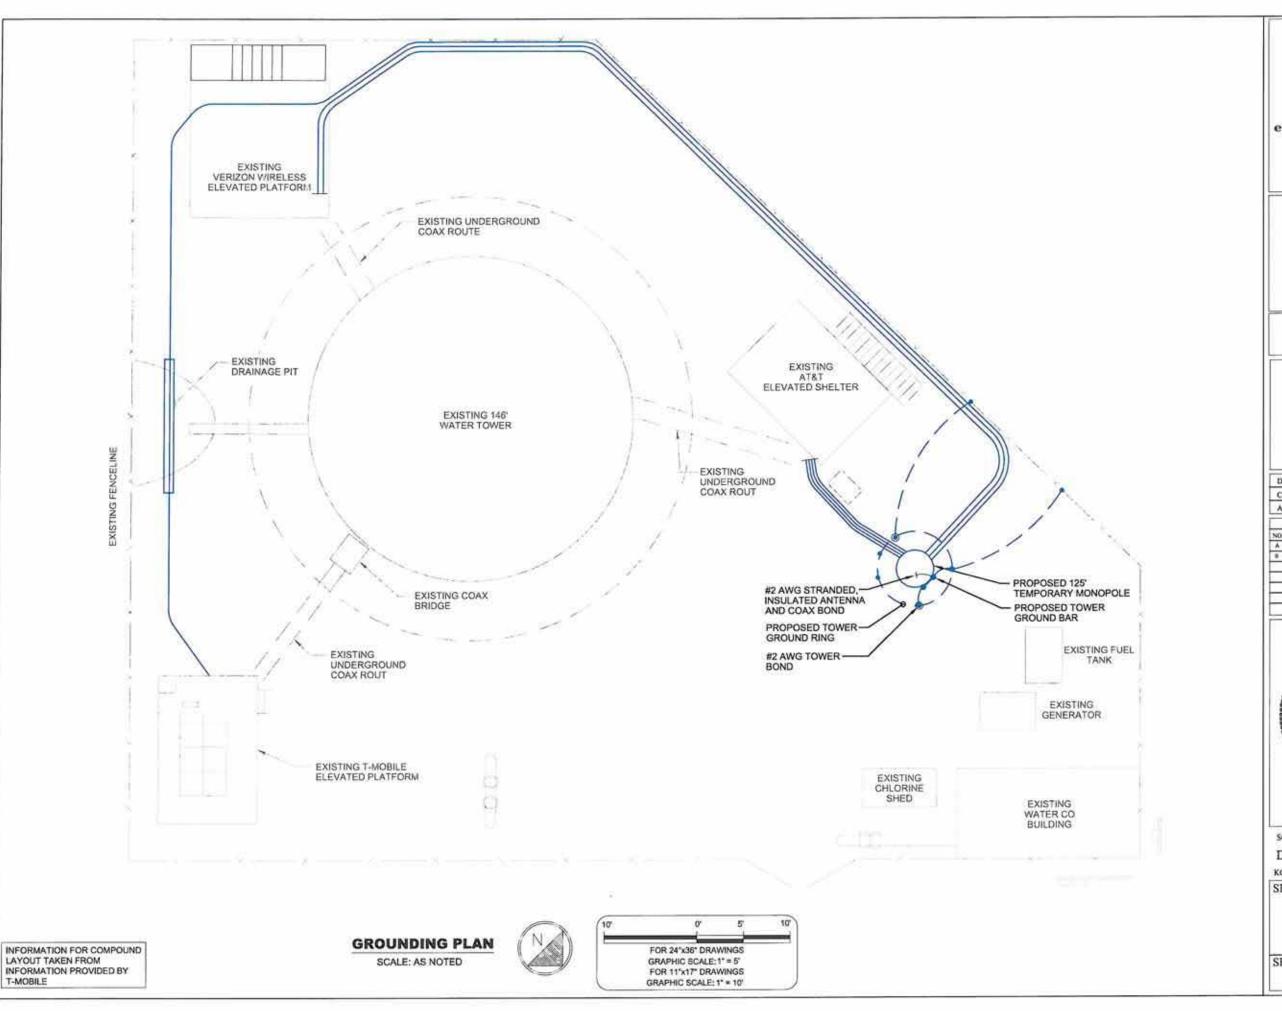
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**DETAILS** 

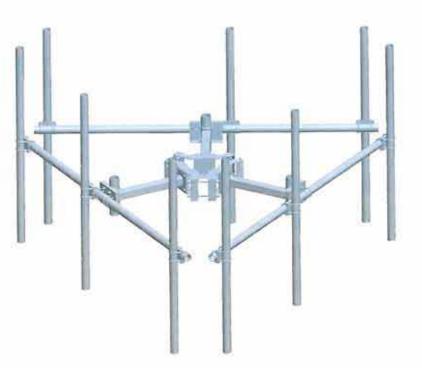SHEET

C-4





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APPROVED BY: J. FENNELL

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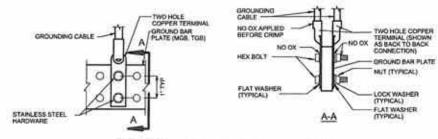
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GROUNDING PLAN


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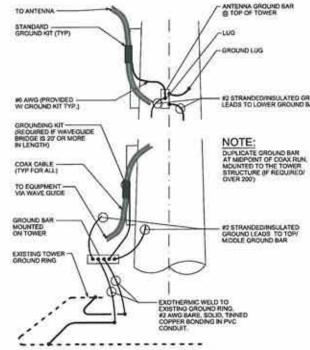
GROUND BAR CONNECTION

NOTE: INCLUDED THE STACKING OF CONNECTIONS IS NOT PERMITTED. DISIDE - INHIBITING JOINT COMPOUND TO BE USED ON ALL CONNECTIONS. BACK TO BACK TO BACK CONNECTIONS SHALL BE USED ONLY WHEN NUMBER OF CONNECTIONS TO FRONT OF BAR EXCEEDS NUMBER OF AVAILABLE SPACES.



#### **GROUNDING NOTES:**


- ALL GROUNDING CONNECTIONS SHALL BE MADE USING EXDTHERAIC WELD PROCESS (CAD WELD OR EQUAL) EXCEPT FOR EQUIPMENT CONNECTIONS WHICH ARE MECHANICALLY FASTENED, ALL LOGS SHALL BE TWO HOLE, LONG BARREL TYPE, FOR COPPER, UNLESS OTHERWISE NOTED.
- ALL GROUND ROOS SHALL BE A MINIMUM OF 8 FEET LONG, COPPER CLAD STEEL (302 OR 304), 58° DAMETER, ORIVEN VIRTICALLY DOWN WITH TOPS 30° MIN. BELOW GRADE. USE SHIELDS TO PREVENT "MUSHROOMING" ROOTOPS.
- ALL GROUND CONDUCTORS SHALL BE BARE, TINNED, SOLID COPPER WIRE, SIZED #2
   AWG., RUN 30" MINIMUM BELOW GRADE.
- 4. GROUND RODS FOR GROUND RING SHALL BE LOCATED IF APART.
- Any METAL OSJECT WITHIN 6 FEET OF THE TOWER OR EQUIPMENT GROUND RING SHALL BE BONDED DREIGTLY TO THE RING.
- THE MINIBUM BENDING RADIUS FOR ALL GROUND CONDUCTORS NO. 6 AWG OR SMALLER SHALL BE 8". CONDUCTOR LARGER THAN NO. 6 SHALL HAVE A 12" BENDING RADIUS.
- ALL ABOVE GRADE GROUND CONDUCTORS SHALL BE ROUTED DOWNWARD TOWARD EARTH AND HORIZONTAL DNLY WHERE NECESSARY WITH NO LOOP BACKS.
- ALL CONDUCTORS SHALL BE ROUTED SUCH THAT THERE ARE NO ANGLES OF LESS THAN 90 DEGREES.
- COMPLETED GROUND SYSTEMS SHALL BE TESTED AND SHALL HAVE A RESISTANCE OF 5 OHMS OR LESS. IF RESISTANCE VALUE BEXCLEDED, NOTIFY OWNER FOR FURTHER INSTRUCTIONS, SUBMIT A COMY OF THE TEST REPORT TO THE OWNER.
- 10. ALL GROUNDING SHALL COMPLY WITH NFPA 70 (NEC) AND NFFA 700, "LIGHTNING PROTECTION CODE".
- 11. ALL GROUNDING COMPONENTS SHALL BE FURNISHED AND INSTALLED BY CONTRACTOR.
- 12. ANY METAL CONDUIT MOUNTED ON THE TOWER SHALL BE BONDED TO THE TOWER AT EACH END.
- ALL GROUNDING SHALL COMPLY WITH NORTEL STANDARD CS412Z, "GROUNDING OF COMMUNICATIONS SYSTEMS" & T-MOBILE BTS GROUNDING GUIDELINES.
- 14. THERE SHALL BE AN GROUND BAR LOCATED AT TOP AND MIDDLE OF THE TOWER BOND BAR TO TOWER WITH A 82 BOLID COPPER CONDUCTOR, CONNECT BAR END WITH A 24IGLE LUIG AND DRAGON TOOTH WASHERBOND CODAX SHELD GROUND JUMPERS TO GROUND BAR.
- 15.BOND ANTENNA MOUNT TO TOWER STEEL WITH A 82 BARE, TINNED, SOUD COPPER CONDUCTOR, (2-HOLE LUG AT EACH END)
- 16. ALL GROUND BARS SHALL BE COPPER 4" X 24" X 1/1" WITH PRE-CRILLED HOLES TO MATCH TWO HOLE LUGS, GROUND BARS SHALL NOT BE FIELD FABRICATED OR DRILLED, HARDWARE SHALL BE 3/1", STAINLESS STEEL, NO ZINC COATED MATERIAL ALLOWED, MOUNT ALL GROUND BARS PARRILLE. TO THE SARTH.

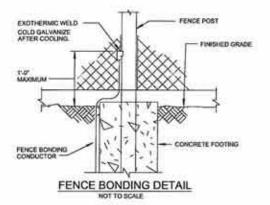

### TYPICAL TOWER EXIT BAR DETAIL


NOTES: 1, NUMBER OF GROUND BARS MAY VARY DEPENDING ON THE TYPE OF TOWER, ANTENNA LOCATION AND CONNECTION ORIENTATION, PROVIDE AS REQUIRED. (MONOPOLE SHOWN).

 COAX CABLE INSTALLATION SHOWN. IF HYBRID CABLES ARE INSTALLED, GROUNDING REQUIREMENTS WILL CHANGE.

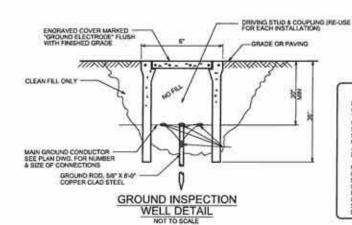


NOTE:
DUE TO THE INDEPENDENT NATURE
OF BOTH THE SERVICE GROUND AND
THE EQUIPMENT BOND BYSTEM, THE
CONTRACTOR SHALL TEST BOTH
BYSTEMS AFTER INSTALLATION AND
SHALL SHOW THAT BOTH SYSTEMS.
MEET THE SOME OR LESS CHITERIA
AND THAT THERE IS NO POTENTIAL.

NOTE THAT SOME JURISDICTIONS MAY REQUIRE A PHYSICAL CONNECTION BETWEEN THE 2 SYSTEMS. WI THESE CASES THE CONTRACTOR SHALL COMPLY BY CONNECTION THE 2 WITH A SINGLE CONDUCTOR. "92 ANG. BARE, TINNED, SOLID COPPER CONNECTED BY EXCITED SHE CONTRACT."

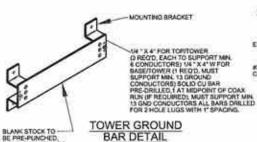

EXCITIES ON GROUND BAR TO GROUND BAR TO GROUND RING CONNECTION DIAGRAM

TO GROUND BAR

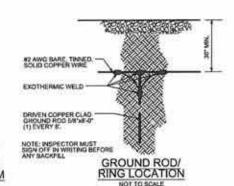



electrical design consultants

#### LIGHTHOUSE TEMP POLE

91 LIGHTHOUSE ROAD HILTON HEAD, SC 29926

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KCI TECHNOLOGIES, INC. 4041 CRESCENT PARK DRIVE RIVERVIEW, FLORIDA 33578 (813) 740-2300

DRAWN BY: J. HAWS
CHECKED BY: L. VASQUEZ
APPROVED BY: J. FENNELL

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SCALE: AS NOTED DATE: 07/02/18

KCI JOB NUMBER: 011803950A

SHEET TITLE

GROUNDING DETAILS


SHEET

G-2

NOTE TO SUBCONTRACTOR:
ALL MODIFICATIONS ARE ASSUMED TO BE MADE
ON AN EMPTY TOWER. THIS MEANS THAT THE
CONTRACTOR IS RESPONSIBLE TO MAKE
PROVISIONS TO SUPPORT OR WORK AROUND
EXISTING ANTENNAS AND TRANSMISSION LINES.
MODIFICATIONS MUST BE CONTINUOUS THROUGH
ALL AREAS SHOWN.

TEMPORARY POLE AND ALL ABOVE GRADE MODIFICATIONS SHALL BE REMOVED UPON COMPLETION OF WATER TANK MAINTENANCE.

PROPOSED 125'-0" MONOPOLE WITH 16'-0"± EMBEDED (PER PLANS BY UTILITY POLE SOLUTIONS)

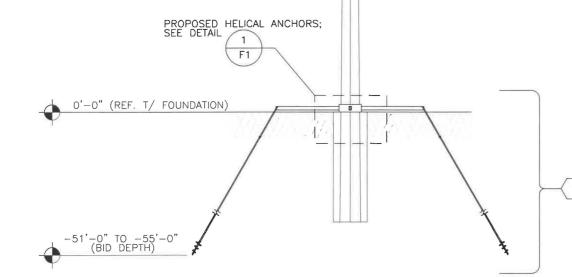

	TOWER MODIFICATION SCHEDULE				
NO.	MODIFICATION DESCRIPTION	BOTTOM ELEVATION (FT.)	TOP ELEVATON (FT.)		
1	PROPOSED HELICAL ANCHORS	-51 TO -55	0		

DESIGN LOADING				
LOADING CASE	CODE	WIND SPEED AND ICE LOADING		
1	ANSI/TIA-222-G & 2015 INTERNATIONAL BUILDING CODE FOR BEAUFORT COUNTY, SOUTH CAROLINA	141 MPH (ULTIMATE 3 SECOND GUST), NO ICE *109 MPH (NOMINAL 3 SECOND GUST), NO ICE		
2	ANSI/TIA-222-G FOR BEAUFORT COUNTY, SOUTH CAROLINA	30 MPH (3 SECOND GUST), 1/2" RADIAL ICE		

\*- CONVERSION BASED ON 2015 INTERNATIONAL BUILDING CODE, SECTION 1609.1.1 DETERMINATION OF WIND LOADS, EXCEPTION 5.

	PROPOSED APPURTENANCES						
NUMBER	ELEVATION	CARRIER	MOUNT	ANTENNA INFORMATION	TRANSMISSION LINES		
1	110'	VERIZON	FLUSH	(3)- COMMSCOPE-NHH-45C-R2B-04DT-0880 PANEL ANTENNAS (3)- RRUS-32 B4 4449	*(12)- 7/8"		
2	90'	AT&T	T-ARMS	(3)— COMMSCOPE—SBJAH4—1D65C—DL PANEL ANTENNA (3)— RRUS—11 (3)— RRUS—12 (3)— 4426—B66	*(3)- FIBER		
3	100'	T-MOBILE	T-ARMS	(3)- CELLMAX CMA-B/6521/E0-6/TB05 PANEL ANTENNAS (3)- FXFC (3)- FRIA (3)- CBC1923T-DS-43 (3)- TMAT1921B68-21-43	*(6)- 1 5/8"		

\*- DENOTES TRANSMISSION LINES RUN OUTSIDE THE MONOPOLE IN A FLUSH CONFIGUATION.

SPRINT'S, T-MOBILE'S, AND AT&T'S PROPOSED TRANSMISSION LINES SHALL BE MOUNTED OUTSIDE THE MONOPOLE IN A FLUSH CONFIGURATION.

NOTE: ELEVATIONS MAY VARY BASED ON ACTUAL EMBEDMENT DEPTH





6580 Sprint Parkway Overland Park, Kansas 66251

### e-d-c

### electrical design consultants

39 The Crescent Newnan, Georgia 30263

DATE OF ORIGINATION: 08/06/2018

DRAWN BY : DFK

CHECKED BY : ESK

REVISIONS

REVISIO

NO. DESCRIPTION

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2

3

KCI TECHNOLOGIES, INC 4505 FALLS OF NEUSE ROAD, SUITE 400 RALEIGH, NC 27609 (919)783-9214

PROJECT NAME :

LIGHTHOUSE RD BEAUFORT COUNTY, SC

SHEET TITLE :

**TOWER ELEVATION** 

SHEET NO.


S-1


KCI JOB NO. : 011803950 A



**TOWER ELEVATION** 

SCALE: 1" = 15'-0"

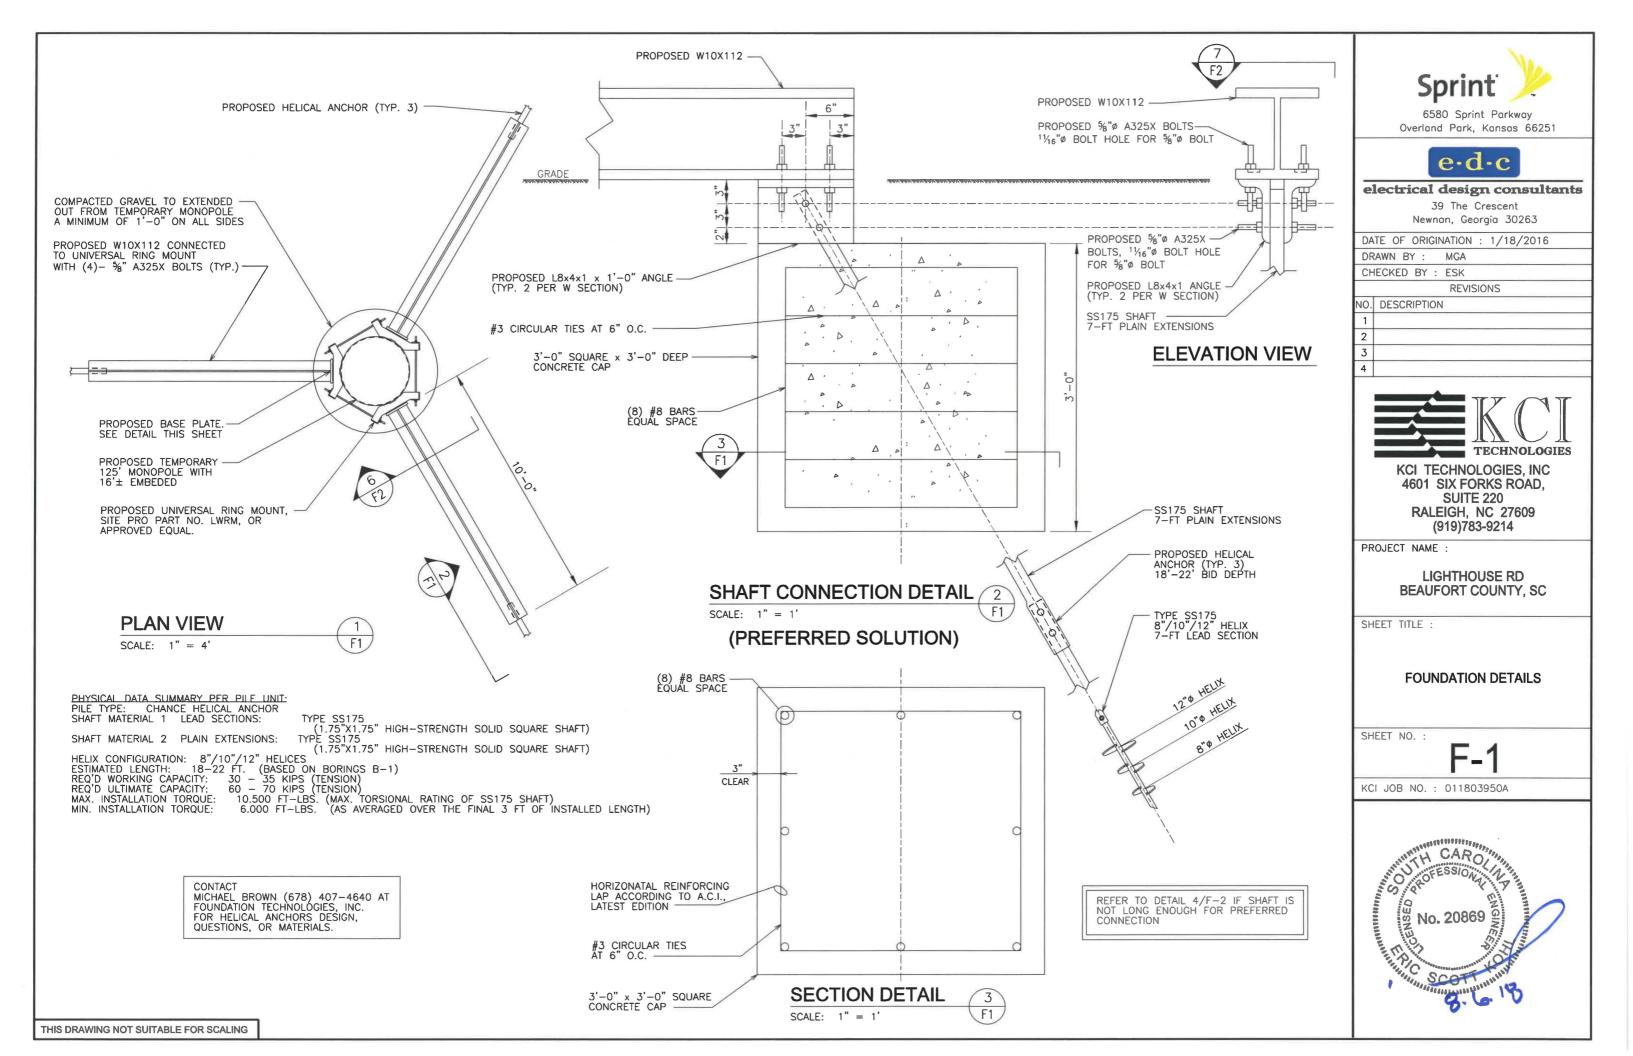

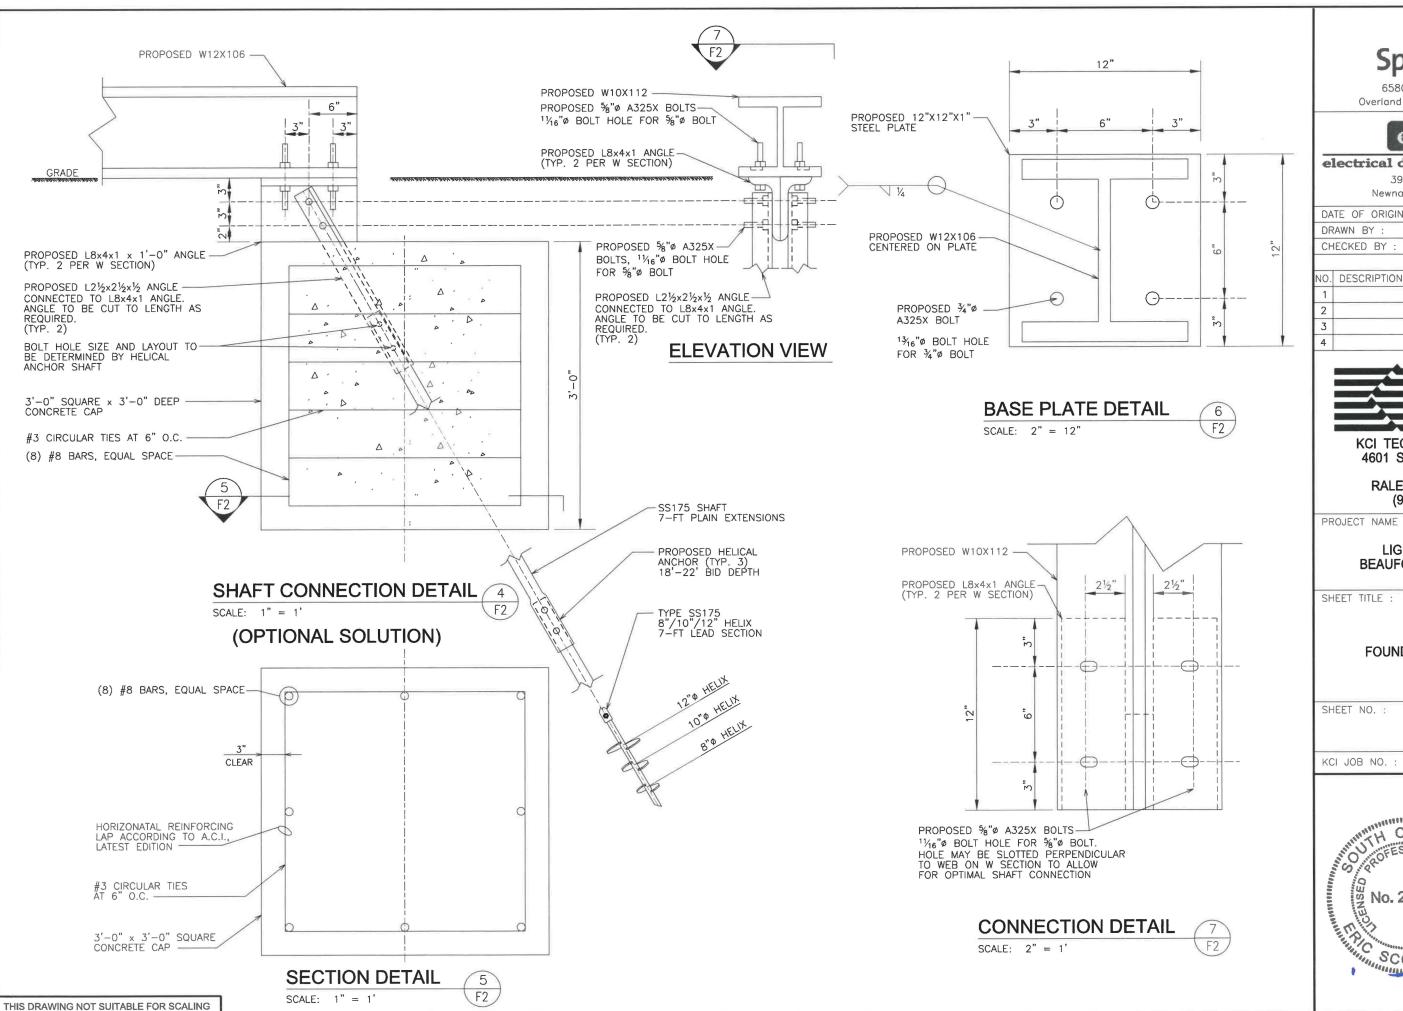



6580 Sprint Parkway Overland Park, Kansas 66251



### electrical design consultants

39 The Crescent Newnan, Georgia 30263

DATE OF ORIGINATION: 1/18/2016 MGA CHECKED BY : ESK REVISIONS O. DESCRIPTION



KCI TECHNOLOGIES, INC 4601 SIX FORKS ROAD, **SUITE 220** RALEIGH, NC 27609 (919)783-9214

LIGHTHOUSE RD BEAUFORT COUNTY, SC

**FOUNDATION DETAILS** 

KCI JOB NO.: 011803950A



### **DESIGN TEAM/DRB COMMENT SHEET**

The comments below are staff recommendations to the Design Review Board (DRB) and do NOT constitute DRB approval or denial.

PROJECT NAME: Lighthouse Monopole		D	RB#: DRB-00190	9-2018				
DATE: 08/16/2018								
RECOMMENDATION: Approval RECOMMENDED CONDITIONS:  1. The monopole structure shall be painted li								
ARCHITECTURAL DESIGN								
DESIGN GUIDE/LMO CRITERIA	Complies Yes	No	Not Applicable	Comments or Conditions				
Design is unobtrusive and set into the natural environment		$\boxtimes$		The galvanized finish it not 'nature blending'.				



### Town of Hilton Head Island

Community Development Department One Town Center Court Hilton Head Island, SC 29928 Phone: 843-341-4757 Fax: 843-842-8908

www.hiltonheadislandsc.gov

FOR OFFICIAL	USE ONLY
Date Received:	
Accepted by:	
DRB#:	
Meeting Date:	

Applicant/Agent Name: Raymond Novello Company: RG Novello INC

Mailing Address: 19 Coopers Hawk Rd City: Hilton Head Island State: SC Zip: 29926 Telephone: (850) 519-3637 Fax: 855-718-5615 E-mail: Ramey@Novelloelectric.com

Project Name: Hilton Head South Beach Water Tank Project Project Address: 99 south sea pines drive Hilton Head SC

29928

Parcel Number [PIN]: R550-019-0171 Zoning District: Overlay District(s):

# CORRIDOR REVIEW, MAJOR DESIGN REVIEW BOARD (DRB) SUBMITTAL REQUIREMENTS

Digital Submissions may be accepted via e-mail by calling 84.	<i>3-341-4757.</i>
Project Category:	
Concept Approval – Proposed Development Final Approval – Proposed Development	X_ Alteration/Addition Sign
Submittal Requirements for All projects:	
Private Architectural Review Board (ARB) Notice of Adjurisdiction of an ARB, the applicant shall submit such 2-103.I.4.b.iii.01. Submitting an application to the ARE applicant.	ARB's written notice of action per LMO Section 16-
Filing Fee: Concept Approval-Proposed Development \$ Alterations/Additions \$100, Signs \$25; cash or check in	
Additional Submittal Requirements:	
Concept Approval - Proposed Development	
A survey (1"=30' minimum scale) of property lines, existree protection regulations of Sec. 16-6-104.C.2, and if a beaches.	
A site analysis study to include specimen trees, access, so views, orientation and other site features that may influe	
A draft written narrative describing the design intent of reflects the site analysis results.	the project, its goals and objectives and how it
Context photographs of neighboring uses and architectu	ral styles.
Conceptual site plan (to scale) showing proposed location Conceptual sketches of primary exterior elevations show development, materials, colors, shadow lines and landsom	on of new structures, parking areas and landscaping. ving architectural character of the proposed

Additional Submittal Requirements:  Final Approval – Proposed Development  A final written narrative describing how the project conforms with the conceptual approview guidelines of Sec. 16-3-106.F.3.  Final site development plan meeting the requirements of Appendix D: D-6.F.  Final site lighting and landscaping plans meeting the requirements of Appendix D: D-6.F.  Final floor plans and elevation drawings (1/8"=1'-0" minimum scale) showing exterior colors with architectural sections and details to adequately describe the project.  A color board (11"x17" maximum) containing actual color samples of all exterior finis elevations, and indicating the manufacturer's name and color designation.  Any additional information requested by the Design Review Board at the time of conceptual appropriate to the project of the project of the project.	5.H and D-6.I. building materials and hes, keyed to the
scale model or color renderings, that the Board finds necessary in order to act on a final	
Additional Submittal Requirements:  Alterations/Additions  All of the materials required for final approval of proposed development as listed above additional materials.  A survey (1"=30' minimum scale) of property lines, existing topography and the location tree protection regulations of Sec. 16-6-104.C.2, and if applicable, location of bordering beaches.  Photographs of existing structure.	on of trees meeting the
Additional Submittal Requirements:  Signs  Accurate color rendering of sign showing dimensions, type of lettering, materials and a sign of freestanding signs:  Site plan (1"=30" minimum scale) showing location of sign in relation to buildings, parand property lines.  Proposed landscaping plan.	
For wall signs:  Photograph or drawing of the building depicting the proposed location of the sign.  Location, fixture type, and wattage of any proposed lighting.	
Note: All application items must be received by the deadline date in order to be reviewed by the DRB per	LMO Appendix D: D-23.
A representative for each agenda item is strongly encouraged to attend the meeting.	
Are there recorded private covenants and/or restrictions that are contrary to, conflicted the proposed request? If yes, a copy of the private covenants and/or restrictions muthis application.   YES NO	
To the best of my knowledge, the information on this application and all additional factual, and complete. I hereby agree to abide by all conditions of any approvals grante Head Island. I understand that such conditions shall apply to the subject property obligation transferable by sale.	d by the Town of Hilton
I further understand that in the event of a State of Emergency due to a Disaster, the reviset forth in the Land Management Ordinance may be suspended.	view and approval times
SIGNATURE DATE 1	

Last Revised 01/21/15

Electrical Design Consultants, LLC 31699 Chagrin Boulevard Pepper Pike, OH 44124

Town of Hilton Head Island Community Development Department One Town Center Court Hilton Head Islands, SC 29928 Attn: Chris Darnell, RLA

August 13, 2018

Dear Mr. Darnell,

South Island Public Service District (SIPSD) is preparing to paint maintenance on the South Beach and Lighthouse water tanks. SIPSD has hired a painting contractor to paint the interior and exterior of both elevated tanks. The existing exterior paint will be overcoat and thus not require any exterior containment structure or exterior sandblasting. Both tanks will be painted the same color as the existing paint color.

Both tanks have cellular carrier equipment located on the tanks which will need to be removed prior to the start of the painting projects. Temporary cellular towers will be installed near each tank to accommodate the cellular carrier equipment during the painting projects. Below please find the projected schedules for each tank.

### **South Beach Tank**

Target Painting Start: October 1, 2018. Painting will last 75 days. End December 15, 2018

Removal of cellular carrier equipment (Four cellular carriers, AT&T, T-Mobile, Sprint, VZW). Relocation of carrier equipment from existing water tank to temporary pole will take four (4) weeks, with one (1) week scheduled per carrier.

- Temporary pole installation within 2 weeks from Town approval.
- Cellular carrier equipment relocation timeline from South Beach tank to temporary pole.
  - First week after setting the Temp pole
  - Second week after 1st carrier's equipment is relocated;
  - Third week after 2nd carrier's equipment is relocated;
  - Fourth week after 3rd carrier's equipment is relocated;

- Carrier equipment will go back on the tank one by one in the same fashion and timelines that the carriers came off the water Tank. Four (4) weeks total to move back on to the Water tank after painting is complete.
- Removal of temporary pole and restoration of land to original condition. Two (2) weeks.

### **Lighthouse Tank**

Target Painting Start: December 16, 2018. Painting will last 75 days. End March 1, 2019. Removal of cellular equipment (3 cellular carriers AT&T, T-Mobile, VZW)

- Temporary pole installation within 2 weeks
- Cellular carrier equipment relocation timeline from South Beach tank to temporary pole.
  - First week after setting the Temp pole
  - Second week after 1st carrier's equipment is relocated;
  - Third week after 2nd carrier's equipment is relocated;
- Carrier equipment will go back on the tank one by one in the same fashion and timelines that the carriers came off the water Tank. Four (4) weeks total to move back on to the Water tank after painting is complete.
- Removal of temporary pole and restoration of land to original condition. Two (2) weeks.

### **Project Point of Contact**

Electrical Design Consultants Jason W. Smith 470-218-4537 Cell 855-718-5615 Fax jws@graneto.com

Please let me know if you have any questions or concerns regarding the proposed schedule.

Respectfully

Jagon W. Smith









EDC TOWER—SEA PINES DRIVE BORING LOCATION PLAN HILTON HEAD, SOUTH CAROLINA

DATE: 7-18-18	SCALE: NOT TO SCALE	JOB NO. XXXX
DRAWN BY:	FIGURE 2	
CK'D BV		

#### CODES STATEMENT

THE CONTRACTOR'S WORK SHALL COMPLY WITH ALL APPLICABLE NATIONAL, STATE AND LOCAL COCES AS ADOPTED BY THE AUTHORITY HAVING JURISDICTION IN THE REGION WHERE THE WORK, IS TO BE PERFORMED. THE CURRENT EDITION OF THE CODES AND STANDARDS IN EFFECT ON THE DATE OF AWARD OF CONTRACT SHALL COVERN THE DESIGN PARAMETERS.

BUILDING CODE: 2015 INTERNATIONAL BUILDING CODE WITH SC MODIFICATIONS.

ELECTRICAL CODE: NATIONAL ELECTRICAL CODE, 2014 EDITION.

MECHANICAL CODE: 2015 INTERNATIONAL MECHANICAL CODE.

FIRE CODE: 2015 INTERNATIONAL FIRE CODE WITH SC MODIFICATIONS:

LIGHTNING PROTECTION CODE: NFPA 780 2017 EDITION.

THE CONTRACTOR'S WORK SHALL COMPLY WITH THE LATEST EDITION OF THE FOLLOWING STANDARDS:

AMERICAN CONCRETE INSTITUTE (ACI) 318-14. BUILDING CODE REQUIREMENTS FOR STRUCTURAL CONCRETE, AMERICAN INSTITUTE OF STEEL CONSTRUCTION, LIAFD 14TH EDITION, TELECOMMUNICATIONS INDUSTRY ASSOCIATION (TIA) 222-G, STRUCTURAL STANDARDS FOR STEEL ANTENNA TOWER AND ANTENNA SUPPORTING STRUCTURES: TIA 607, COMMERCIAL BUILDING GROUNDING AND BONDING REQUIREMENTS FOR ELECTRONIC EQUIPMENT,

IEEE C82.41, RECOMMENDED PRACTICES ON SURGE VOLTAGES IN LOW VOLTAGE AC POWER CIRCUITS (FOR LOCATION CATEGORY C3 AND HIGH SYSTEM EXPOSURE.)

TELCORDIA GR-1275, GENERAL INSTALLATION REQUIREMENTS, TELCORDIA GR-1503, COAXIA. CONNECTIONS, ANSI TI-311, FOR TELECOM DC POWER SYSTEMS AND TELECOM ENVIRONMENTAL PROTECTION.

### PROJECT DESCRIPTION

 INSTALL TEMPORARY MONOPOLE AND REPOUTE CABLING TO RELOCATED ANTENNAS WHILE CONSTRUCTION ON EXISTING WATERTANK TAKES PLACE.

#### **DESIGN CRITERIA**

DESIGN WIND SPEED: 141 MPH ULTIMATE (3-SECOND GUST) 109 MPH NOMINAL (3-SECOND GUST)

IMPORTANCE FACTOR: 1.0 EXPOSURE CATEGORY: C RISK FACTOR: II





### electrical design consultants

## SOUTH SEA PINES TEMP POLE

**SEA PINES #1** 

99 S. SEA PINES DR. HILTON HEAD, SC 29928 COUNTY: BEAUFORT

PROPOSED TEMPORARY MONOPOLE



### PROJECT DATA

JURISDICTION:

BEAUFORT COUNTY

TOWER OWNER:

SOUTH ISLAND PUBLIC SERVICE

DISTRICT

CONTACT:

EDDIE NETTLES

2 GENESTA STREET HILTON HEAD ISLAND, SC 39938

(843) 816-3533

A&E FIRM:

KCI TECHNOLOGIES JAMES FENNELL, P.E.

JAMES.FENNELL@KCI.COM

-	SHEET INDEX	
T-1	TITLE SHEET	0
N-1	GENERAL NOTES	0
C-1	EXISTING SITE PLAN	0
C-2	PROPOSED SITE PLAN	0
C-3	TOWER ELEVATION	0
C-3A	SECTOR PLANS	0
C-38	EQUIPMENT INVENTORY	. 0
C-4	DETAILS	0
G-1	GROUNDING PLAN	0
G-2	GROUNDING DETAILS	0



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### EDC SOUTH BEACH TEMP POLE ALAMOSA

99 S. SEA PINES DR. HILTON HEAD, SC 29928

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KCI TECHNOLOGIES, INC. 4041 CRESCENT PARK DRIVE RIVERVIEW, FLORIDA 33578 (813) 740-2300

DRAWN BY: 1. HAWS

CHECKED BY: L. VASQUEZ

APPROVED BY: J. FENNELL

REVISIONS



SCALE: AS NOTED

DATE: 06/29/18


KCI JOB NUMBER: 011803950B

SHEET TITLE

TITLE SHEET

SHEET

T-1

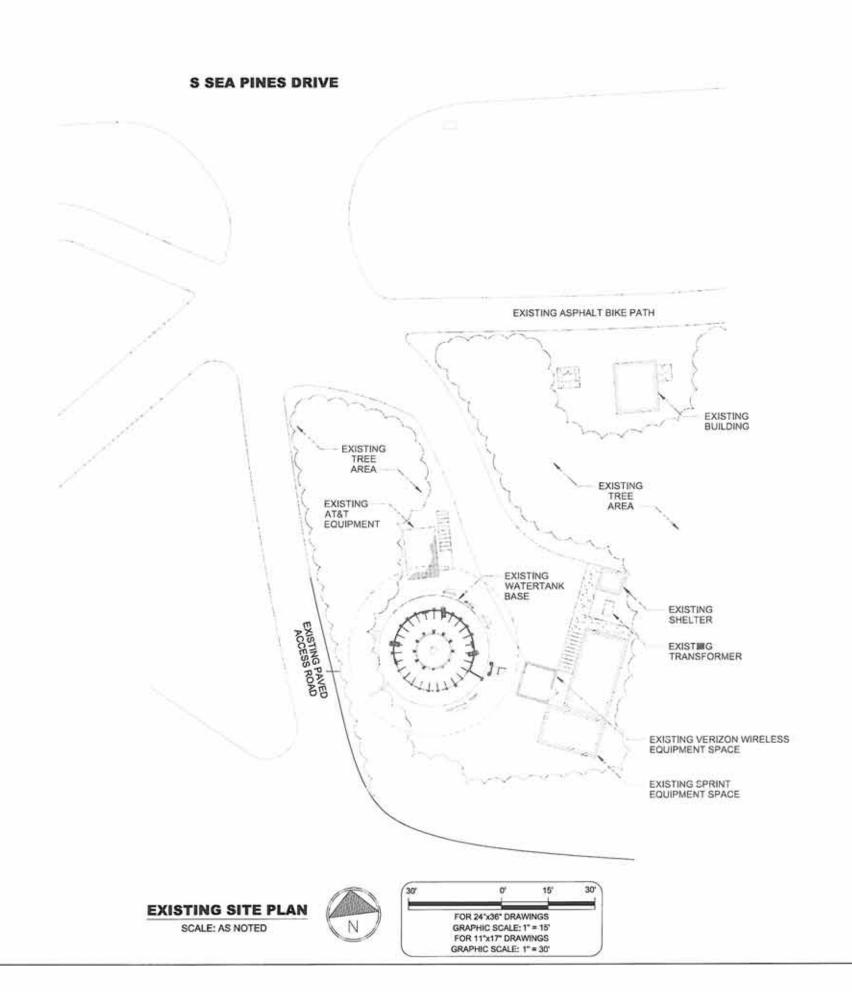



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### EDC SOUTH BEACH TEMP POLE ALAMOSA

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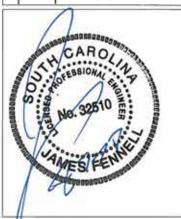


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DRAWN BY: J. HAWS
CHECKED BY: L. VASQUEZ

APPROVED BY: J. FENNELL
REVISION:

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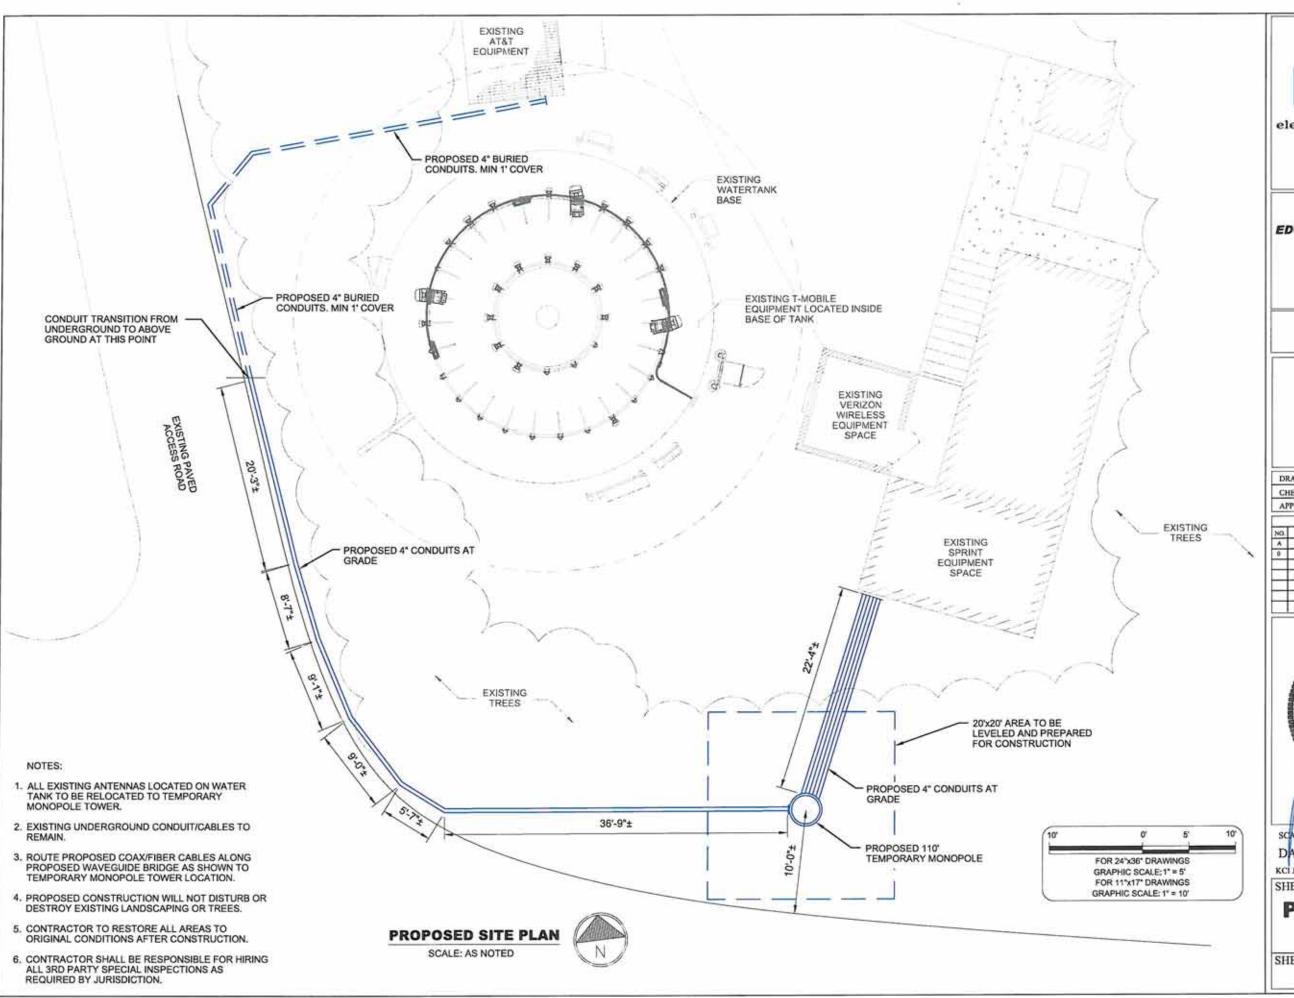
KCI JOB NUMBER: 011803950B

SHEET TITLE

# EXISTING SITE PLAN

SHEET

C-1





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CHECKED BY: L. VASQUEZ

APPROVED BY: J. FENNELL

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DATE: 06/29/18

KCI JOB NUMBER: 011803950B

SHEET TITLE

## PROPOSED SITE PLAN

SHEET

C-2

PROPOSED T-MOBILE & AT&T ANTENNAS @ 110' AGL TOP OF PROPOSED TOWER @ 110' AGL PROPOSED SPRINT ANTENNAS @ 100' AGL PROPOSED VERIZON ANTENNAS @ 90' AGL

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### EDC SOUTH BEACH TEMP POLE ALAMOSA

99 S. SEA PINES DR. HILTON HEAD, SC 29928

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APPROVED BY: J. FENNELL

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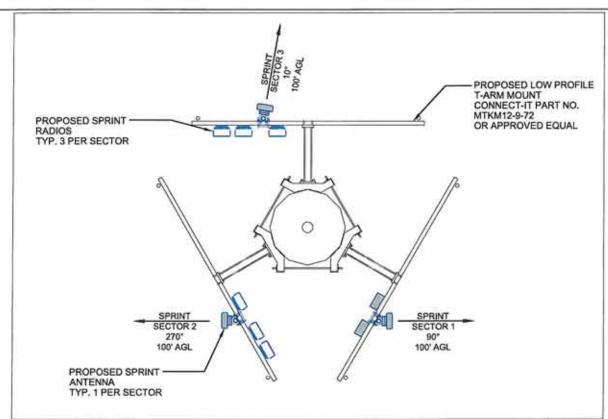
TOWER ELEVATION

SHEET


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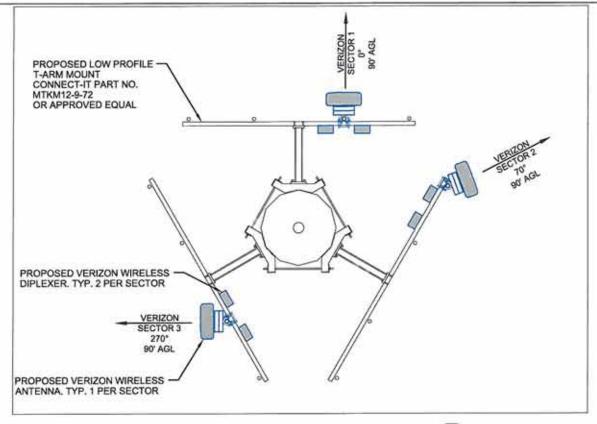
NOTE: EXISTING EQUIPMENT NOT SHOWN FOR CLARITY









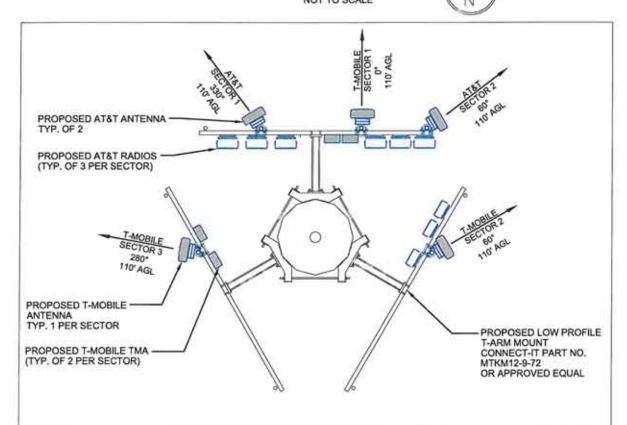

### **ANTENNA SECTOR PLAN -VERIZON WIRELESS**

NOT TO SCALE





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### **EDC SOUTH BEACH TEMP POLE ALAMOSA**

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SCALE: AS NOTED DATE: 06/29/18

KCI JOB NUMBER: 011803950B

SHEET TITLE

SECTOR **PLANS** 

SHEET

C-3A



### T-ARM KIT ANTENNA MOUNT

NOT TO SCALE CONNECT-IT PART NO. MTKM12-9-72



electrical design consultants

### EDC SOUTH BEACH TEMP POLE ALAMOSA

99 S. SEA PINES DR. HILTON HEAD, SC 29928


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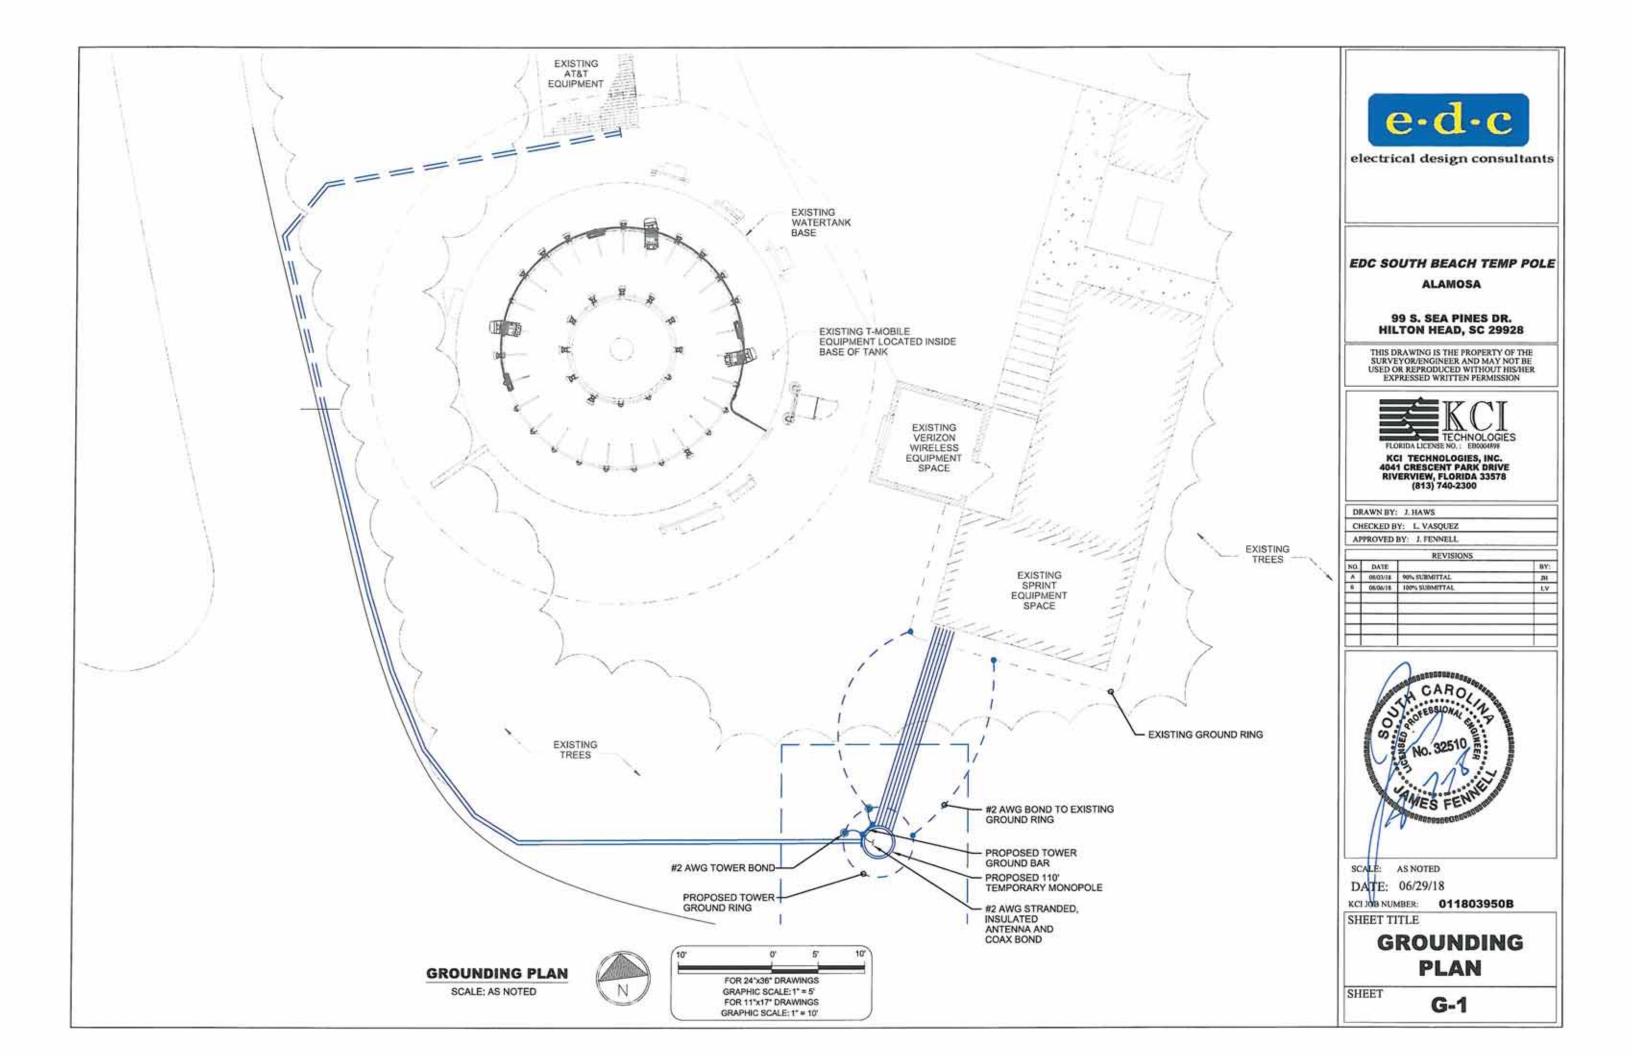
KCI JOB NUMBER: 011803950B


SHEET TITLE

**DETAILS** 

SHEET


C-4

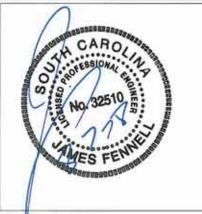

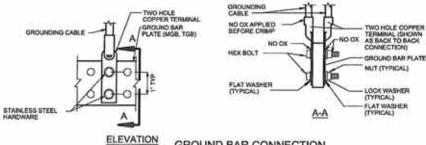


GROUND BAR CONNECTION

NOTE:
TOUBLING UP OR STACKING OF CONNECTIONS IS NOT PERMITTED,
OXBE - INHIBITING JOINT COMPOUND TO BE USED ON ALL CONNECTIONS,
BACK TO BACK CONNECTIONS SHALL BE USED ONLY WHEN NUMBER
OF CONNECTIONS TO FRONT OF BAR EXCEEDS NUMBER OF AVAILABLE SPACES.

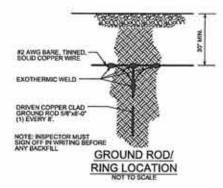




- ALL GROUNDING CONNECTIONS SHALL BE MADE USING EXOTHERMIC WELD PROCESS (CAD WELD OR EQUAL) EXCEPT FOR EQUIPMENT CONNECTIONS WHICH ARE MECHANICALLY FASTENED, ALL LUGS BHALL BE TWO HOLE, LONG BARREL TYPE, FOR COPPER, UNLESS OTHERWISE NOTED.
- ALL GROUND ROOS SHALL BE A MINIMUM OF 8 FEET LONG, COPPER CLAD STEEL (302 OR 304) SIF DIAMETER, DRIVEN VERTICALLY DOWN WITH TOPS 30" MIN. BELOW ORADE. USE SHELDS TO PREVENT "AUBSHROOMING" SHOOT DOTS.
- ALL GROUND CONDUCTORS SHALL BE BARE, TINNED, SOLID COPPER WIRE, SIZED K2 AWG., RUN 30" MINIMUM BELOW GRADE.
- 4. GROUND RODS FOR GROUND RING SHALL BE LOCATED & APART.
- ANY METAL OBJECT WITHIN 6 FEET OF THE TOWER OR EQUIPMENT GROUND RING SHALL BE BONDED DIRECTLY TO THE RING.
- THE MINIMUM BENDING RADIUS FOR ALL GROUND CONCUCTORS NO. 6 AWG OR SMALLER SHALL BE 8". CONDUCTOR LARGER THAN NO. 6 SHALL HAVE A 12" BENDING RADIUS.
- ALL ABOVE GRADE GROUND CONDUCTORS SHALL BE ROUTED DOWNWARD TOWARD EARTH AND HORIZONTAL ONLY WHERE NECESSARY WITH NO LOOP BACKS.
- ALL CONDUCTORS SHALL BE ROUTED SUCH THAT THERE ARE NO ANGLES OF LESS THAN 90 DEGREES.
- COMPLETED GROUND SYSTEMS SHALL BE TESTED AND SHALL HAVE A RESISTANCE OF 5 OHAS OR LESS. IF RESISTANCE VALUE IS EXCEEDED, NOTIFY COWNER FOR FURTHER INSTRUCTIONS, SILBINIT A COPY OF THE TEST REPORT TO THE OWNER.
- 10, ALL GROUNDING SHALL COMPLY WITH NFPA 70 (NEC) AND NFPA 780, "LIGHTNING PROTECTION CODE".
- 11. ALL GROUNDING COMPONENTS SHALL BE FURNISHED AND INSTALLED BY CONTRACTOR.
- 12. ANY METAL CONDUIT MOUNTED ON THE TOWER SHALL BE BONDED TO THE TOWER AT EACH END.
- 14. THERE SHALL BE AN GROUND BAR LOCATED AT TOP AND MIDDLE OF THE TOWER. BOND BAR TO TOWER WITH A 22 SOLID COPPER CONDUCTOR. CONNECT BAR END WITH A HOLE, LUG AND DRAGON TOOTH WASHER. BOND CDAX SHIELD GROUND JUMPERS TO GROUND BAR.
- 15. SOND ANTENNA MOUNT TO TOWER STEEL WITH A 82 BARE, TINNED, SOLID COPPER CONDUCTOR, (2-HOLE LUG AT EACH END)
- 16. ALL GROUND BARS SHALL BE COPPER 4" X 24" X 14" WITH PRE-DRILLED HOLES TO MATCH TWO HOLE LUGS. GROUND BARS SHALL NOT BE FIELD FABRICATED OR DRELED, HARDWARE SHALL BE 34"S, "STAINLESS STEEL, NO ZON COATED MATERIAL ALLOWED, MOUNT ALL GROUND BARS PARALLEL TO THE EARTH.

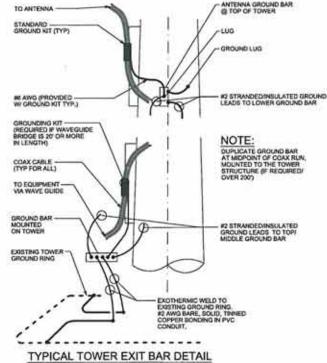


NOTES: 1. NUMBER OF GROUND BARS MAY VARY DEPENDING ON THE TYPE OF TOWER, ANTENNA LOCATION AND CONNECTION ORIENTATION. PROVIDE AS REQUIRED.


COAX CABLE INSTALLATION SHOWN, IF HYBRID CABLES ARE INSTALLED, GROUNDING REQUIREMENTS WILL CHANGE.

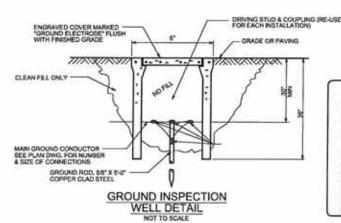

NOTE: DUE TO THE INDEPENDENT NATURE OF BOTH THE SERVICE GROUND AND THE EQUIPMENT BOND SYSTEM, THE CONTRACTOR SHALL TEST BOTH SYSTEMS AFTER INSTALLATION AND SHALL SHOW THAT BOTH SYSTEMS MEET THE 5 OHM OR LESS CRITERIA AND THAT THERE IS NO POTENTIAL DIFFERENCE SETWEEN THE TWO.

NOTE THAT SOME JURISDICTIONS MAY REQUIRE A PHYSICAL CONNECTION BETWEEN HE 2 SYSTEMS. IN THISSE CASES THE CONTRACTOR SHALL COMPLY BY CONNECTION THE 2 WITH A SINGLE CONDUCTOR. "32 ANG. SARE, TINNED. SOLID COPPER CONNECTED BY EXCITED BY EXCITERING WELD AT BOTH ENDS".

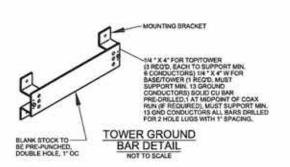

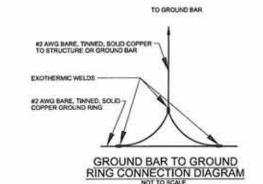



electrical design consultants

# **EDC SOUTH BEACH TEMP POLE ALAMOSA**

99 S. SEA PINES DR. **HILTON HEAD, SC 29928** 


THIS DRAWING IS THE PROPERTY OF THE SURVEYOR/ENGINEER AND MAY NOT BE USED OR REPRODUCED WITHOUT HIS/HER EXPRESSED WRITTEN PERMISSION



KCI TECHNOLOGIES, INC. 4041 CRESCENT PARK DRIVE **RIVERVIEW, FLORIDA 33578** (813) 740-2300

DRAWN BY: J. HAWS CHECKED BY: L. VASQUEZ APPROVED BY: J. FENNELL

NO.	DATE		BY:
A .	08/03/18	90% SUBMITTAL	DI DI
0	08/06/18	100% SUBMITTAL	LY
$\neg$			
$\neg$			
$\rightarrow$			

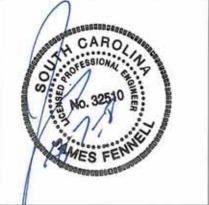

SCALE: AS NOTED DATE: 06/29/18

KCI JOB NUMBER: 011803950B

SHEET TITLE

GROUNDING **DETAILS** 


SHEET

G-2

NOTE TO SUBCONTRACTOR:
ALL MODIFICATIONS ARE ASSUMED TO BE MADE
ON AN EMPTY TOWER. THIS MEANS THAT THE
CONTRACTOR IS RESPONSIBLE TO MAKE
PROVISIONS TO SUPPORT OR WORK AROUND
EXISTING ANTENNAS AND TRANSMISSION LINES.
MODIFICATIONS MUST BE CONTINUOUS THROUGH
ALL AREAS SHOWN.

TEMPORARY POLE AND ALL ABOVE GRADE MODIFICATIONS SHALL BE REMOVED UPON COMPLETION OF WATER TANK MAINTENANCE.

PROPOSED 125'-0" MONOPOLE WITH 16'-0"± EMBEDED (PER PLANS BY UTILITY POLE SOLUTIONS)

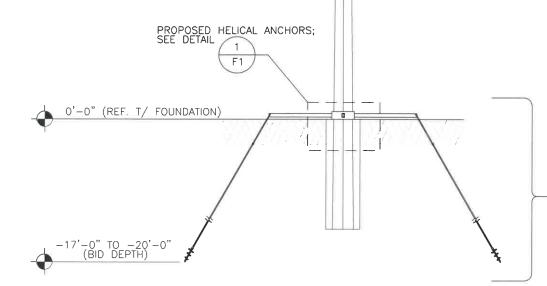

	TOWER MODIFICATION SCHEDULE						
NO.	MODIFICATION DESCRIPTION	BOTTOM ELEVATION (FT.)	TOP ELEVATON (FT.)				
1	PROPOSED HELICAL ANCHORS	-17 TO -20	0				

DESIGN LOADING						
LOADING CASE	CODE	WIND SPEED AND ICE LOADING				
1	ANSI/TIA-222-G & 2015 INTERNATIONAL BUILDING CODE FOR BEAUFORT COUNTY, SOUTH CAROLINA	141 MPH (ULTIMATE 3 SECOND GUST), NO ICE *109 MPH (NOMINAL 3 SECOND GUST), NO ICE				
2	ANSI/TIA-222-G FOR BEAUFORT COUNTY, SOUTH CAROLINA	30 MPH (3 SECOND GUST), 1/2" RADIAL ICE				

\*- CONVERSION BASED ON 2015 INTERNATIONAL BUILDING CODE, SECTION 1609.1.1 DETERMINATION OF WIND LOADS, EXCEPTION 5.

PROPOSED APPURTENANCES							
NUMBER	ELEVATION	CARRIER	MOUNT	ANTENNA INFORMATION	TRANSMISSION LINES		
1	100'	SPRINT	T-ARMS	(3)- ET-X-TW-73-15-63 (3)- 1900 RRH (3)- 800 RRH (3)- 2500 MM	*(18)- FIBER		
2	110'	T-MOBILE	T-ARMS	(3)- COMMSCOPE-SBNH-1D65C (3)- FXFC (3)- FRBG	*(12)- 1 5/8"		
3	110'	AT&T	T-ARMS	(3)- COMMSCOPE-SBJAH4-1D65C-DL (3)- RRUS-11 (3)- RRUS-12 (3)- 4426-B66	*(12)- FIBER		
4	90'	VERIZON	T-ARMS	(3)- COMMSCOPE-NHH-45C-R2B-04DT-0080 PANEL ANTENNAS (3)- RRUS-32 B4 (6)- CBC426T-DS-43	*(12)- 7/8"		

\*- DENOTES TRANSMISSION LINES RUN OUTSIDE THE MONOPOLE IN A FLUSH CONFIGUATION.

SPRINT'S, T-MOBILE'S, AND AT&T'S PROPOSED TRANSMISSION LINES SHALL BE MOUNTED INSIDE THE MONOPOLE.

NOTE: ELEVATIONS MAY VARY BASED ON ACTUAL EMBEDMENT DEPTH





6580 Sprint Parkway Overland Park, Kansas 66251

# e-d-c

# electrical design consultants

39 The Crescent Newnan, Georgia 30263

DATE OF ORIGINATION: 08/06/2018

DRAWN BY : DFK
CHECKED BY : ESK

NED DI : ESK

REVISIONS NO. DESCRIPTION

1

2

4



KCI TECHNOLOGIES, INC 4505 FALLS OF NEUSE ROAD, SUITE 400 RALEIGH, NC 27609 (919)783-9214

PROJECT NAME :

S. SEA PINES BEAUFORT COUNTY, SC


SHEET TITLE

**TOWER ELEVATION** 


SHEET NO.


S-1

KCI JOB NO. : 011803950 B

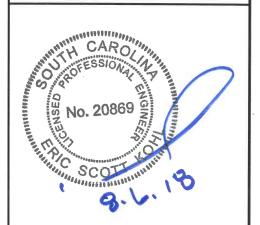

TOWER ELEVATION
SCALE: 1" = 15'-0"

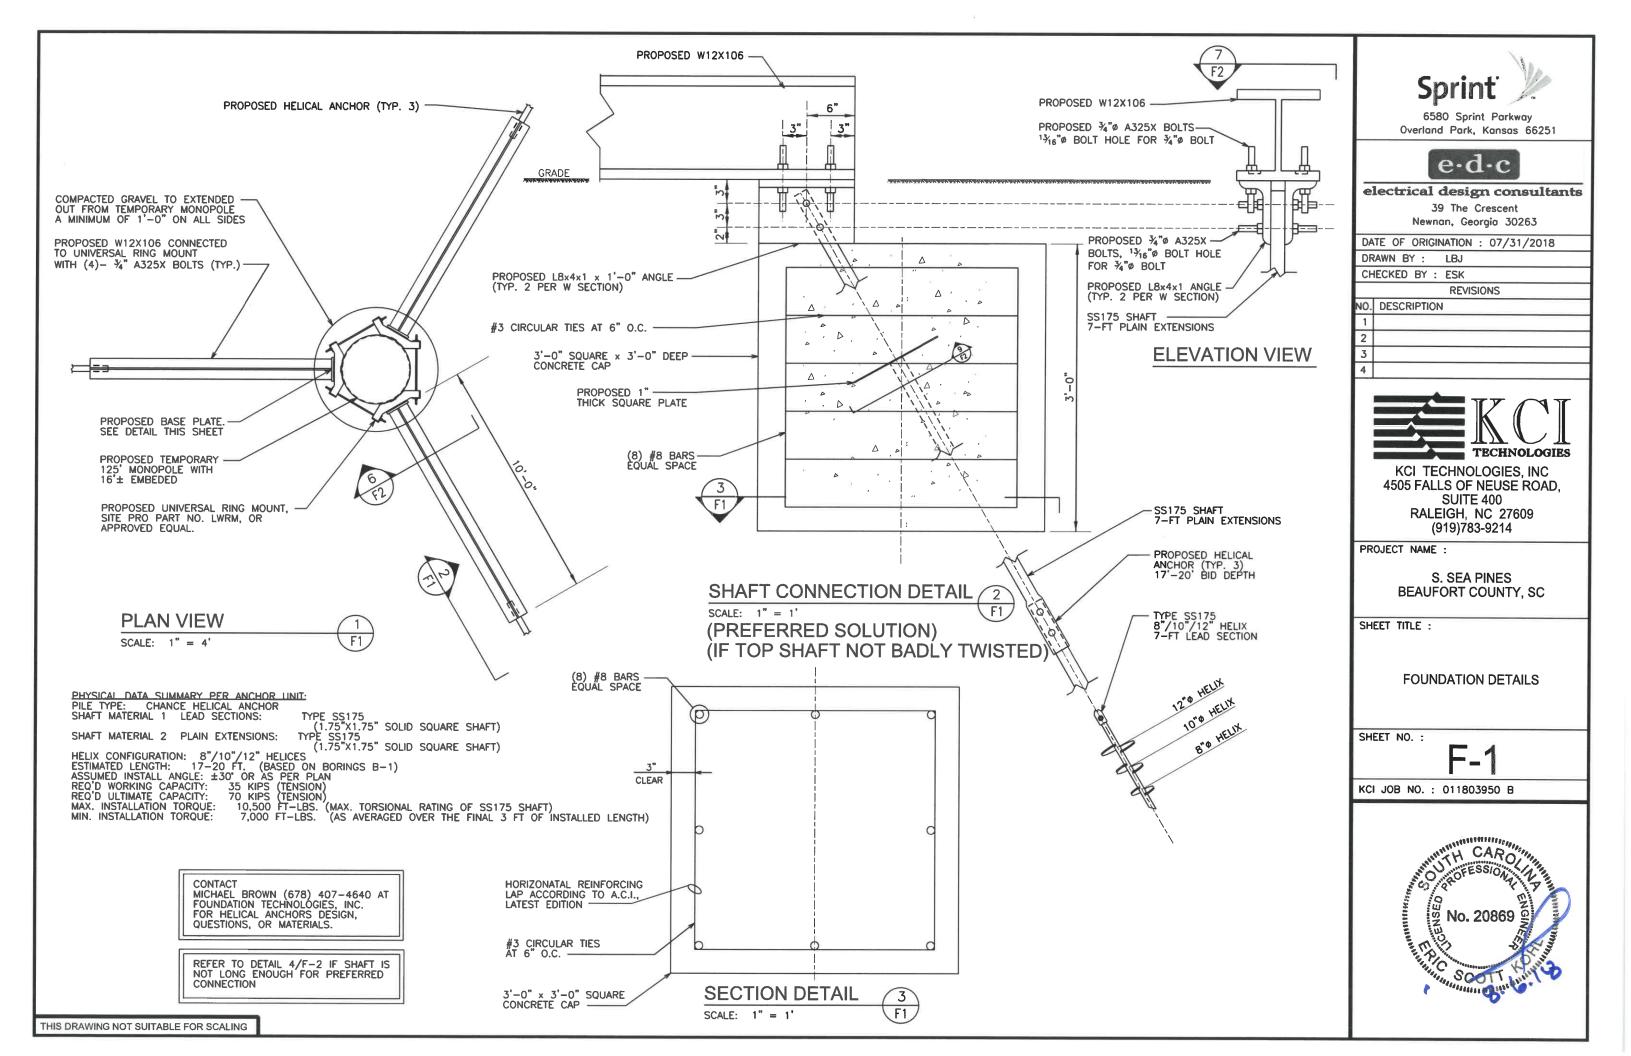

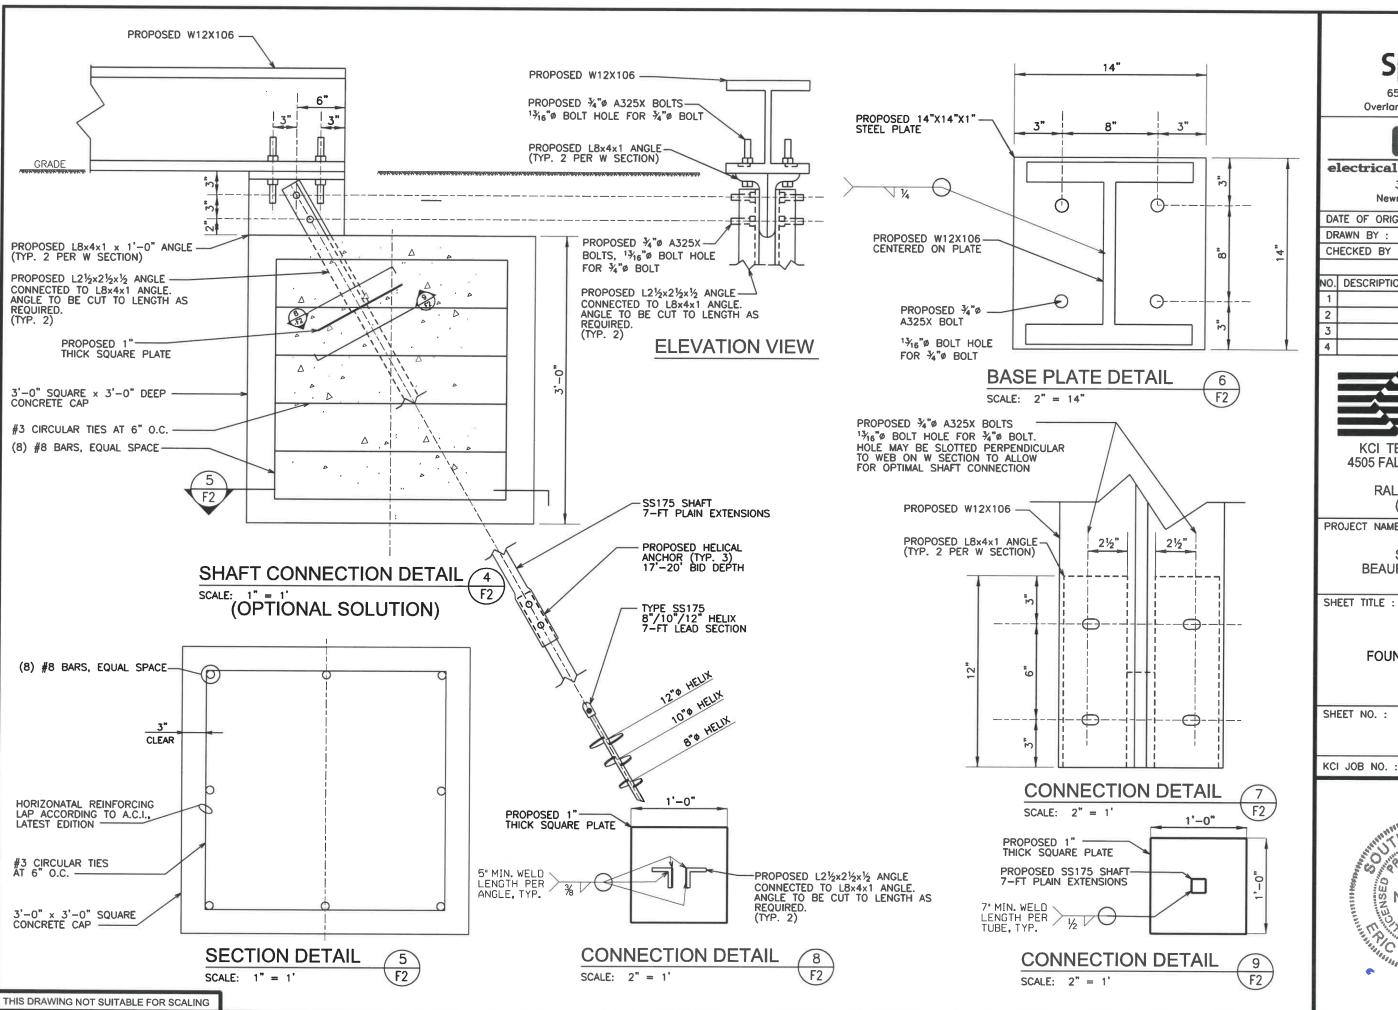



6580 Sprint Parkway Overland Park, Kansas 66251



## electrical design consultants

39 The Crescent Newnan, Georgia 30263

DATE OF ORIGINATION: 07/31/2018

LBJ

CHECKED BY : ESK

REVISIONS

NO. DESCRIPTION

KCI TECHNOLOGIES, INC 4505 FALLS OF NEUSE ROAD, SUITE 400 RALEIGH, NC 27609 (919)783-9214

PROJECT NAME :

S. SEA PINES BEAUFORT COUNTY, SC

SHEET TITLE :

FOUNDATION DETAILS

KCI JOB NO.: 011803950 B



# **DESIGN TEAM/DRB COMMENT SHEET**

The comments below are staff recommendations to the Design Review Board (DRB) and do NOT constitute DRB approval or denial.

PROJECT NAME: South Sea Pines Monopole DRB#: DRB-001909-2018						
DATE: 08/16/2018						
RECOMMENDATION: Approval Approval with Conditions Denial RECOMMENDED CONDITIONS:  1. The monopole structure shall be painted light blue to match the adjacent existing water tower.  2. Provide a Landscape Plan to replace the vegetation removed to install the footer and pole after the pole is removed to be reviewed and approved by Staff.						
ARCHITECTURAL DESIGN	ARCHITECTURAL DESIGN					
DESIGN GUIDE/LMO CRITERIA	Complies Yes	No	Not Applicable	Comments or Conditions		
Design is unobtrusive and set into the natural environment		$\boxtimes$		The galvanized finish it not 'nature blending'.		
				Consider a light blue finish.		
				Consider a light blue finish.		
NATURAL RESOURCE PROTECTIO	N			Consider a light blue finish.		
NATURAL RESOURCE PROTECTIO DESIGN GUIDE/LMO CRITERIA	N Complies Yes	No	Not Applicable	Consider a light blue finish.  Comments or Conditions		



# Town of Hilton Head Island

Community Development Department
One Town Center Court
Hilton Head Island, SC 29928

Phone: 843-341-4757 Fax: 843-842-8908

www.hiltonheadislandsc.gov

FOR OFFICIAL USE O	NLY
Date Received:	
Accepted by:	
DRB#:	
Meeting Date:	

pplicant/Agent Name: Gretchen Callejas	Company: Felder & Associates  City: Savannah State: GA Zip: 31401				
Tailing Address: 2514 Abercorn Street, Suite 110					
elephone: 912-777-3979 Fax:	E-mail: gretchen@felderassociates.net				
roject Name: Hargray Retail (Building A) Pro	oject Address: 862 William Hilton Parkway				
The second control of	5 3 0 0 0 0				
	erlay District(s): COD- ROW Arterial				
CORRIDOR RE	VIEW, MAJOR				
DESIGN REVIEW BOARD (DRB)					
22010:112121120:220 (212)	202				
Digital Submissions may be accepted via e-mail by callin	g 843-341-4757.				
Project Category:					
Concept Approval – Proposed Development	Alteration/Addition				
Final Approval – Proposed Development	Sign				
Submittal Requirements for All projects:					
Private Architectural Deview Roard (ADR) Notice	of Action (if applicable): When a project is within the				
	such ARB's written notice of action per LMO Section 16-				
	ARB to meet this requirement is the responsibility of the				
applicant.	The to most time rodgen among 15 and real-points to time				
<u> </u>					
× Filing Fee: Concept Approval-Proposed Developme	ent \$175, Final Approval – Proposed Development \$175,				
Alterations/Additions \$100, Signs \$25; cash or che	eck made payable to the Town of Hilton Head Island.				
22 GGW 28	, <del>,</del>				
Additional Submittal Requirements:					
Concept Approval – Proposed Development					
	existing topography and the location of trees meeting the				
tree protection regulations of Sec. 16-6-104.C.2, an	d if applicable, location of bordering streets, marshes and				
beaches.					
- In the Control of t	ess, significant topography, wetlands, buffers, setbacks,				
views, orientation and other site features that may i					
A draft written narrative describing the design inter	it of the project, its goals and objectives and how it				
reflects the site analysis results.	± 700				
Context photographs of neighboring uses and archit					
One can trul with all and (40 country all country and					
Conceptual site plan (to scale) showing proposed lo Conceptual sketches of primary exterior elevations	cation of new structures, parking areas and landscaping.				

Last Revised 01/21/15

Additional Submittal Requirements:	
Final Approval – Proposed Development	
	w the project conforms with the conceptual approval and design
review guidelines of Sec. 16-3-106.F.3	
exist Final site development plan meeting the	
	ns meeting the requirements of Appendix D: D-6.H and D-6.I.
_x Final floor plans and elevation drawing	gs (1/8"=1'-0" minimum scale) showing exterior building materials and
colors with architectural sections and	details to adequately describe the project.
** A color board (11"x17" maximum) con	ntaining actual color samples of all exterior finishes, keyed to the
elevations, and indicating the manufac	cturer's name and color designation.
	by the Design Review Board at the time of concept approval, such as
	he Board finds necessary in order to act on a final application.
Additional Submittal Requirements:	
Alterations/Additions	
	approval of proposed development as listed above, plus the following
additional materials.	approvat of proposed development as fished above, plus the following
	property lines, existing topography and the location of trees meeting the
(AT)	6-104.C.2, and if applicable, location of bordering streets, marshes and
beaches.	
Photographs of existing structure.	
Additional Submittal Requirements:	
Signs	
1000 to 100 to 1	ring dimensions, type of lettering, materials and actual color samples.
Accurate color rendering of sign show	ing difficults, type of federing, materials and actual color samples.
For frontending signs	
For freestanding signs:	
	wing location of sign in relation to buildings, parking, existing signs,
and property lines.	
Proposed landscaping plan.	
For wall signs:	THE ARREST CONTRACTOR OF THE C
	depicting the proposed location of the sign.
Location, fixture type, and wattage of	any proposed lighting.
EASTERN STREET FINE SEE SEE STREET SEE STREET SEE	
Note: All application items must be received by the	deadline date in order to be reviewed by the DRB per LMO Appendix D: D-23.
A representative for each agenda item is strongly en	scouraged to attend the meeting.
Are there recorded private covenants and	or restrictions that are contrary to, conflict with, or prohibit
	e private covenants and/or restrictions must be submitted with
this application. $\square$ YES $\boxtimes$ NO	private covenants and/or restrictions must be submitted with
tins application. [1125 [X]140	
To the heat of my knowledge the inform	ation on this application and all additional documentation is true
	ation on this application and all additional documentation is true
	de by all conditions of any approvals granted by the Town of Hilto
	itions shall apply to the subject property only and are a right of
obligation transferable by sale.	
	tate of Emergency due to a Disaster, the review and approval time
set forth in the Land Management Ordinance	e may be suspended.
1 ( ) 11	
General Clathers	21415
	8.14.18
SIGNATURE	DATE

\*\* We have requested samples from the Nichiha



August 14, 2018

Chris Darnell
Urban Designer, Town of Hilton Head
Developmental Review and Zoning Division
Town of Hilton Head, SC
<a href="mailto:chrisda@hiltonheadislandsc.gov">chrisda@hiltonheadislandsc.gov</a>
843-341-4676

Re: Hargray Retail - Building A 862 William Hilton Parkway.

Mr. Darnell,

Please find attached drawings for improvements to 862 William Hilton Parkway.

The building owner, Hargray Communications, will be renovating the first floor of the existing building to house their retail showroom and offices. The majority of the changes are interior with a few exceptions. A new entrance portal is planned for the retail entry. Other exterior modifications include repairs to the existing portico with new roofing, structural repairs, updated finishes and new paint. Final signage will be submitted by others.

The project is part of an existing developed site. The topography, setbacks and buffers are existing and will remain. The site is well vegetated with understory and trees. All existing trees will remain. The parking layout is existing and will remain.

The existing two-story office building was constructed in 1983. An existing retail space is located on the first floor. The retail space is currently vacant, but renovations will be occurring over the next couple months. The roof and mass of the existing building shall remain. The proposed exterior modifications are limited to the one-story portico along the southeast façade facing William Hilton Parkway. The existing portico is currently broken up into three sections. Each of the existing structures are deteriorated and in need of structural repair; as well as cosmetic updating. The existing structure is comprised of stucco columns supporting a glass roof structure. A new simple sloped Kalwall translucent panel roof will be installed at the existing structure; along with new beams bracing back to the building. A new Kalwall canopy with translucent panels will span between the existing portico. The new canopies will create an extension the portico along the entire front of the building to create a more pedestrian friendly front façade.

The east covered entryway will be modified to create a more defined retail entrance. This will be the main public entrance for the building. The new architectural feature will be a one-story entrance portal constructed of structural steel with metal framing. The framing will be skinned in Nichiha architectural wall panels. The Nichiha panels will also clad the upper section of the existing portico structures to help create a cohesive portico/walkway.

Fiberglass products are being used within the new developments just to the North and South of our project. These fiberglass panels are part of a brand defining upgrade to Hargray's architecture. The colors of the entrance portal have been modified to meet the local characteristic of the Town of Hilton Head. We recognize the red hues typically used within Hargray Communication logos and elements are contextually too saturated for this site and neighboring buildings. We have selected to use red earth tones as an accent color to the overall building color scheme. The main structure will remain a tan color in keeping with surrounding architecture. The new paint will match existing.

This application is accompanied by all required information. We trust that you and members of the Design Review Board will find our presentation acceptable and along with our clients, we look forward to working you on this project. Please call if you have any questions or if additional information is required.

Thanks so much,

Gretchen O Callejas, AIA

Project Architect Felder & Associates

Cc: Owner, Design Team, File

## Attachments:

- Application
- Photos of Surrounding Buildings
- Photos of the Existing Building
- Architectural Drawings of Proposed Changes
  - ASI.I Architectural Site Plan
  - o Al.I Floor Plan
  - A1.3 Partial Roof Plan at Portico
  - A3.0 Existing Elevations
  - A3.1 Proposed Elevations
  - A3.2 Exterior Perspectives
  - A5.I Entrance Portal Details






















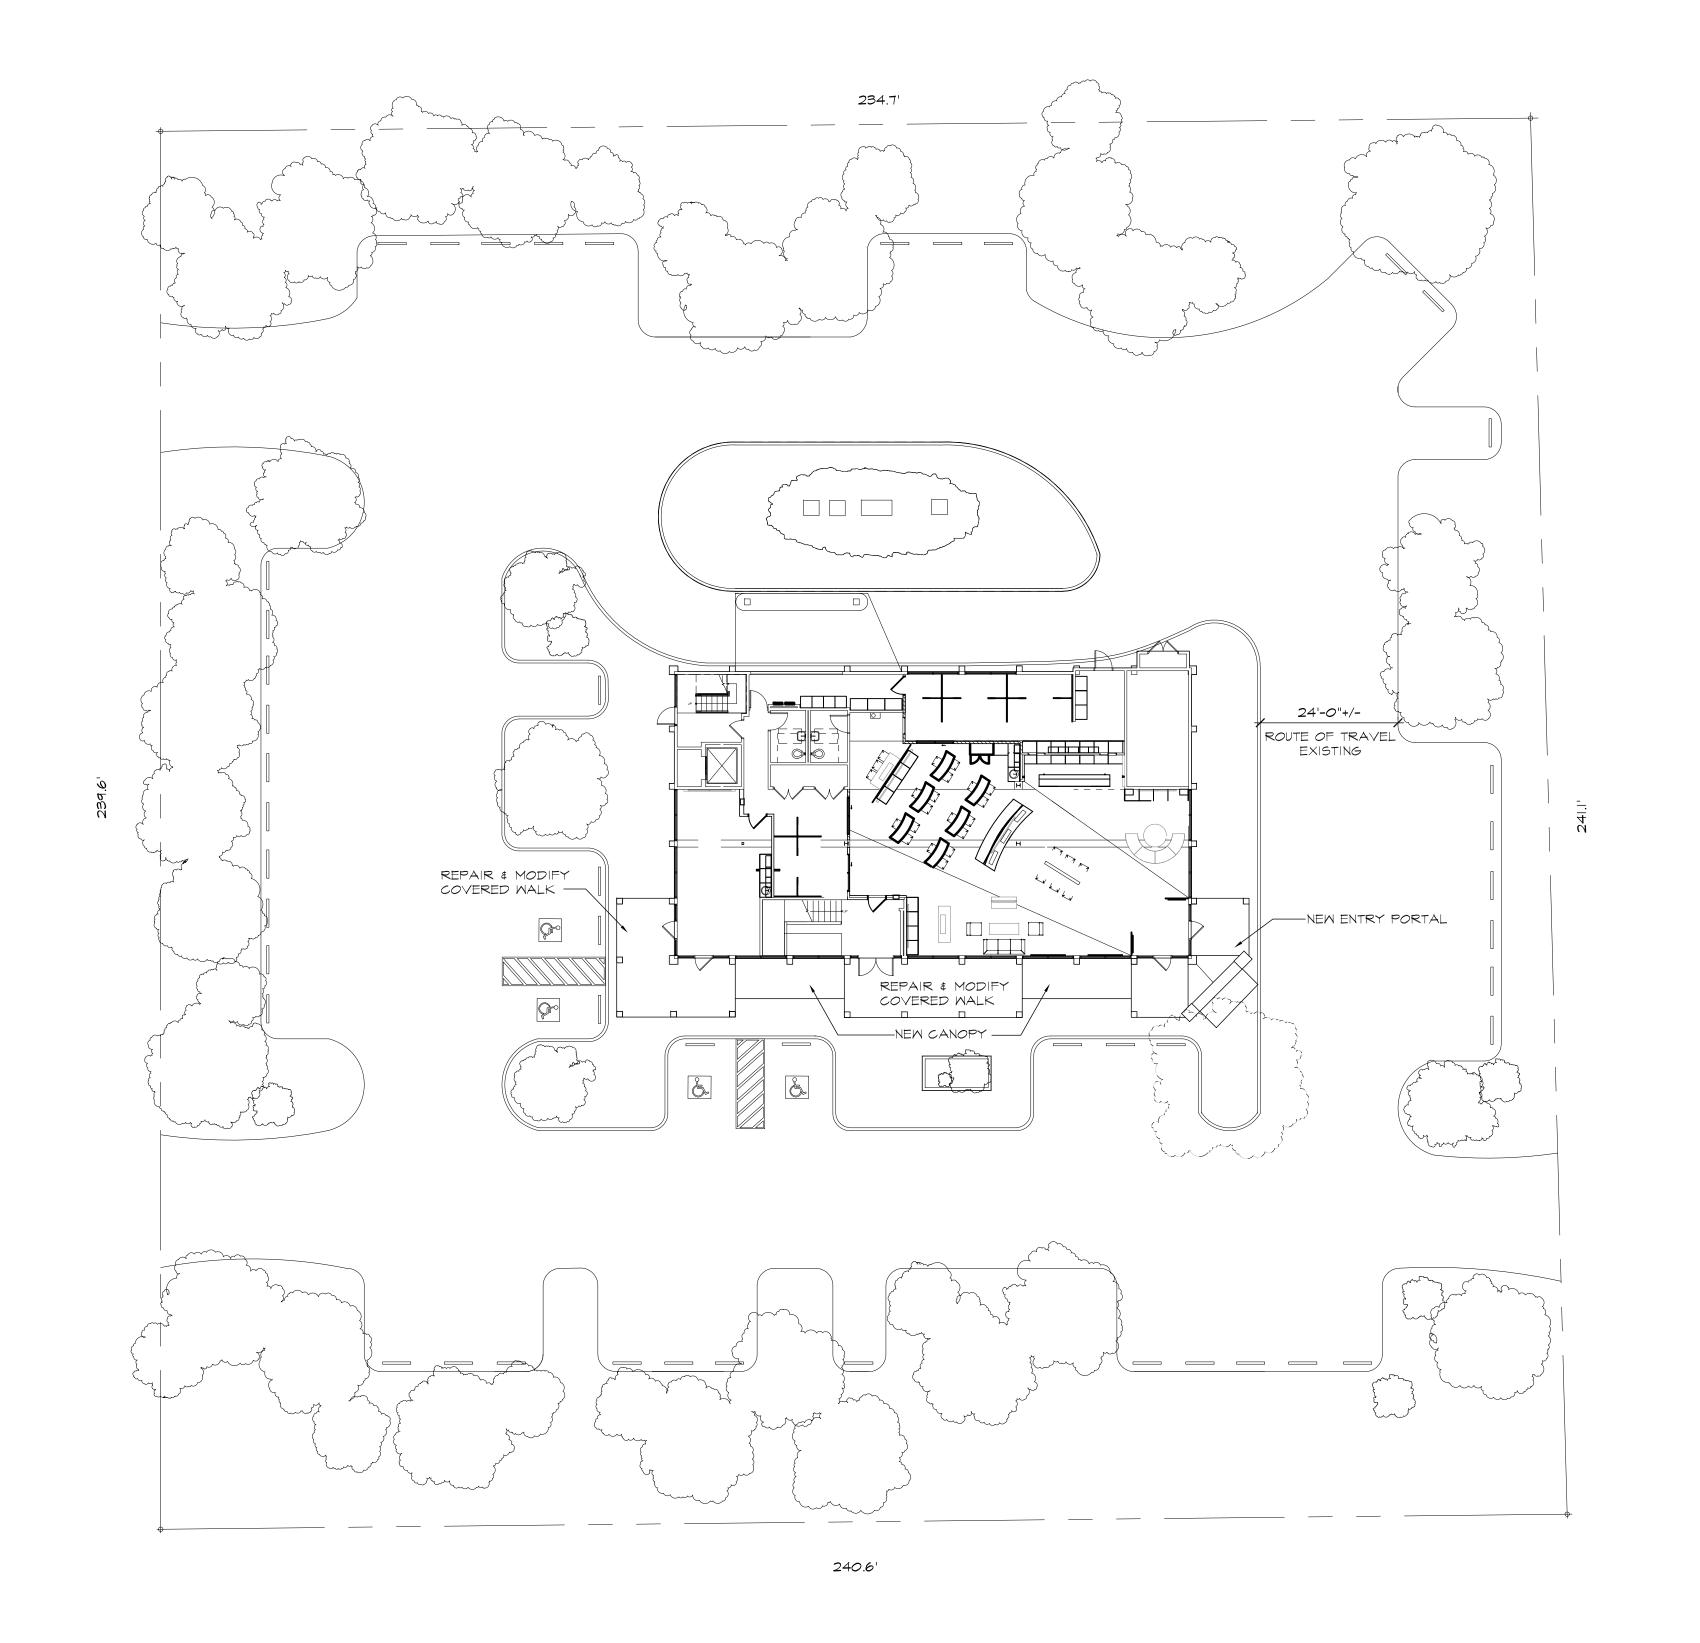



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on request.

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3. Do not scale dimensions from prints. Plans and details are not always drawn to scale. Use dimensions given or consult the Architect for further clarification.


A RENOVATION FOR THE HARGRAY RETAIL BUILDING 862 WILLIAM HILTON PKWY HILTON HEAD ISLAND, SC 29928


ARCHITECTURAL SITE PLAN - PROPOSED

ISSUED FOR REVIEW 08.14.18

JOB NO: 18.013 ISSUE DATE: 08.14.18 DRAWN: AJ

AS1.1

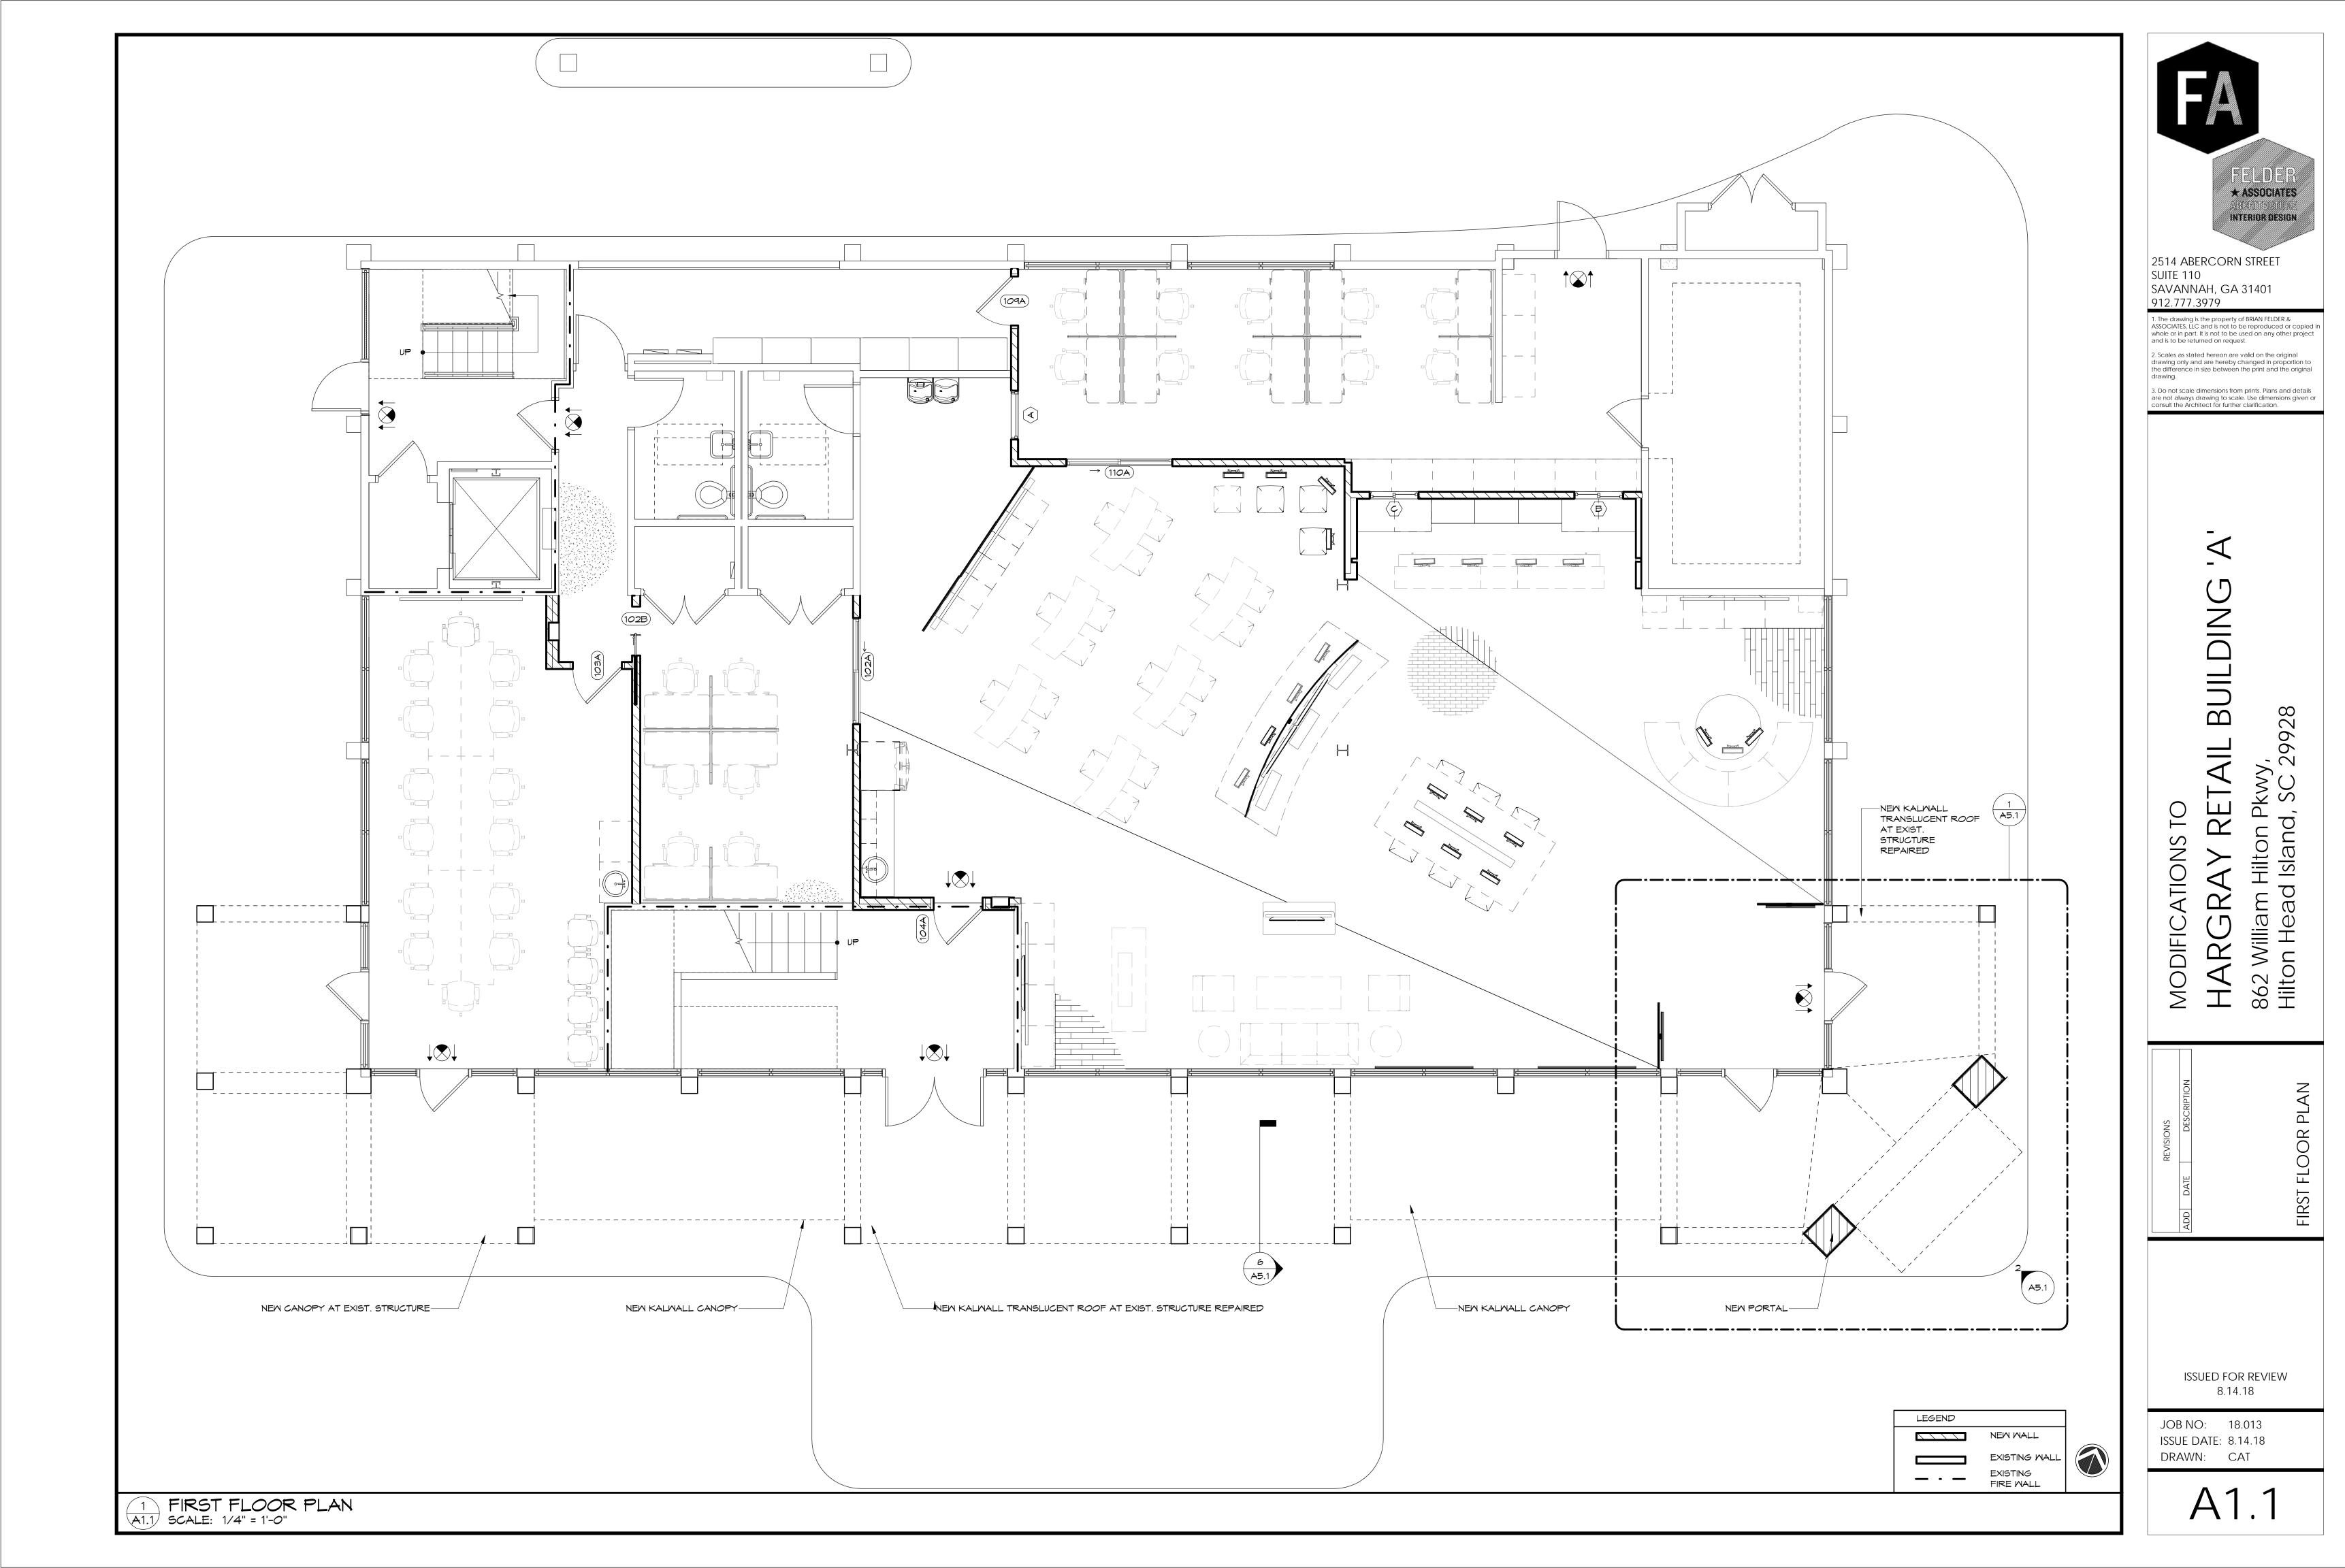

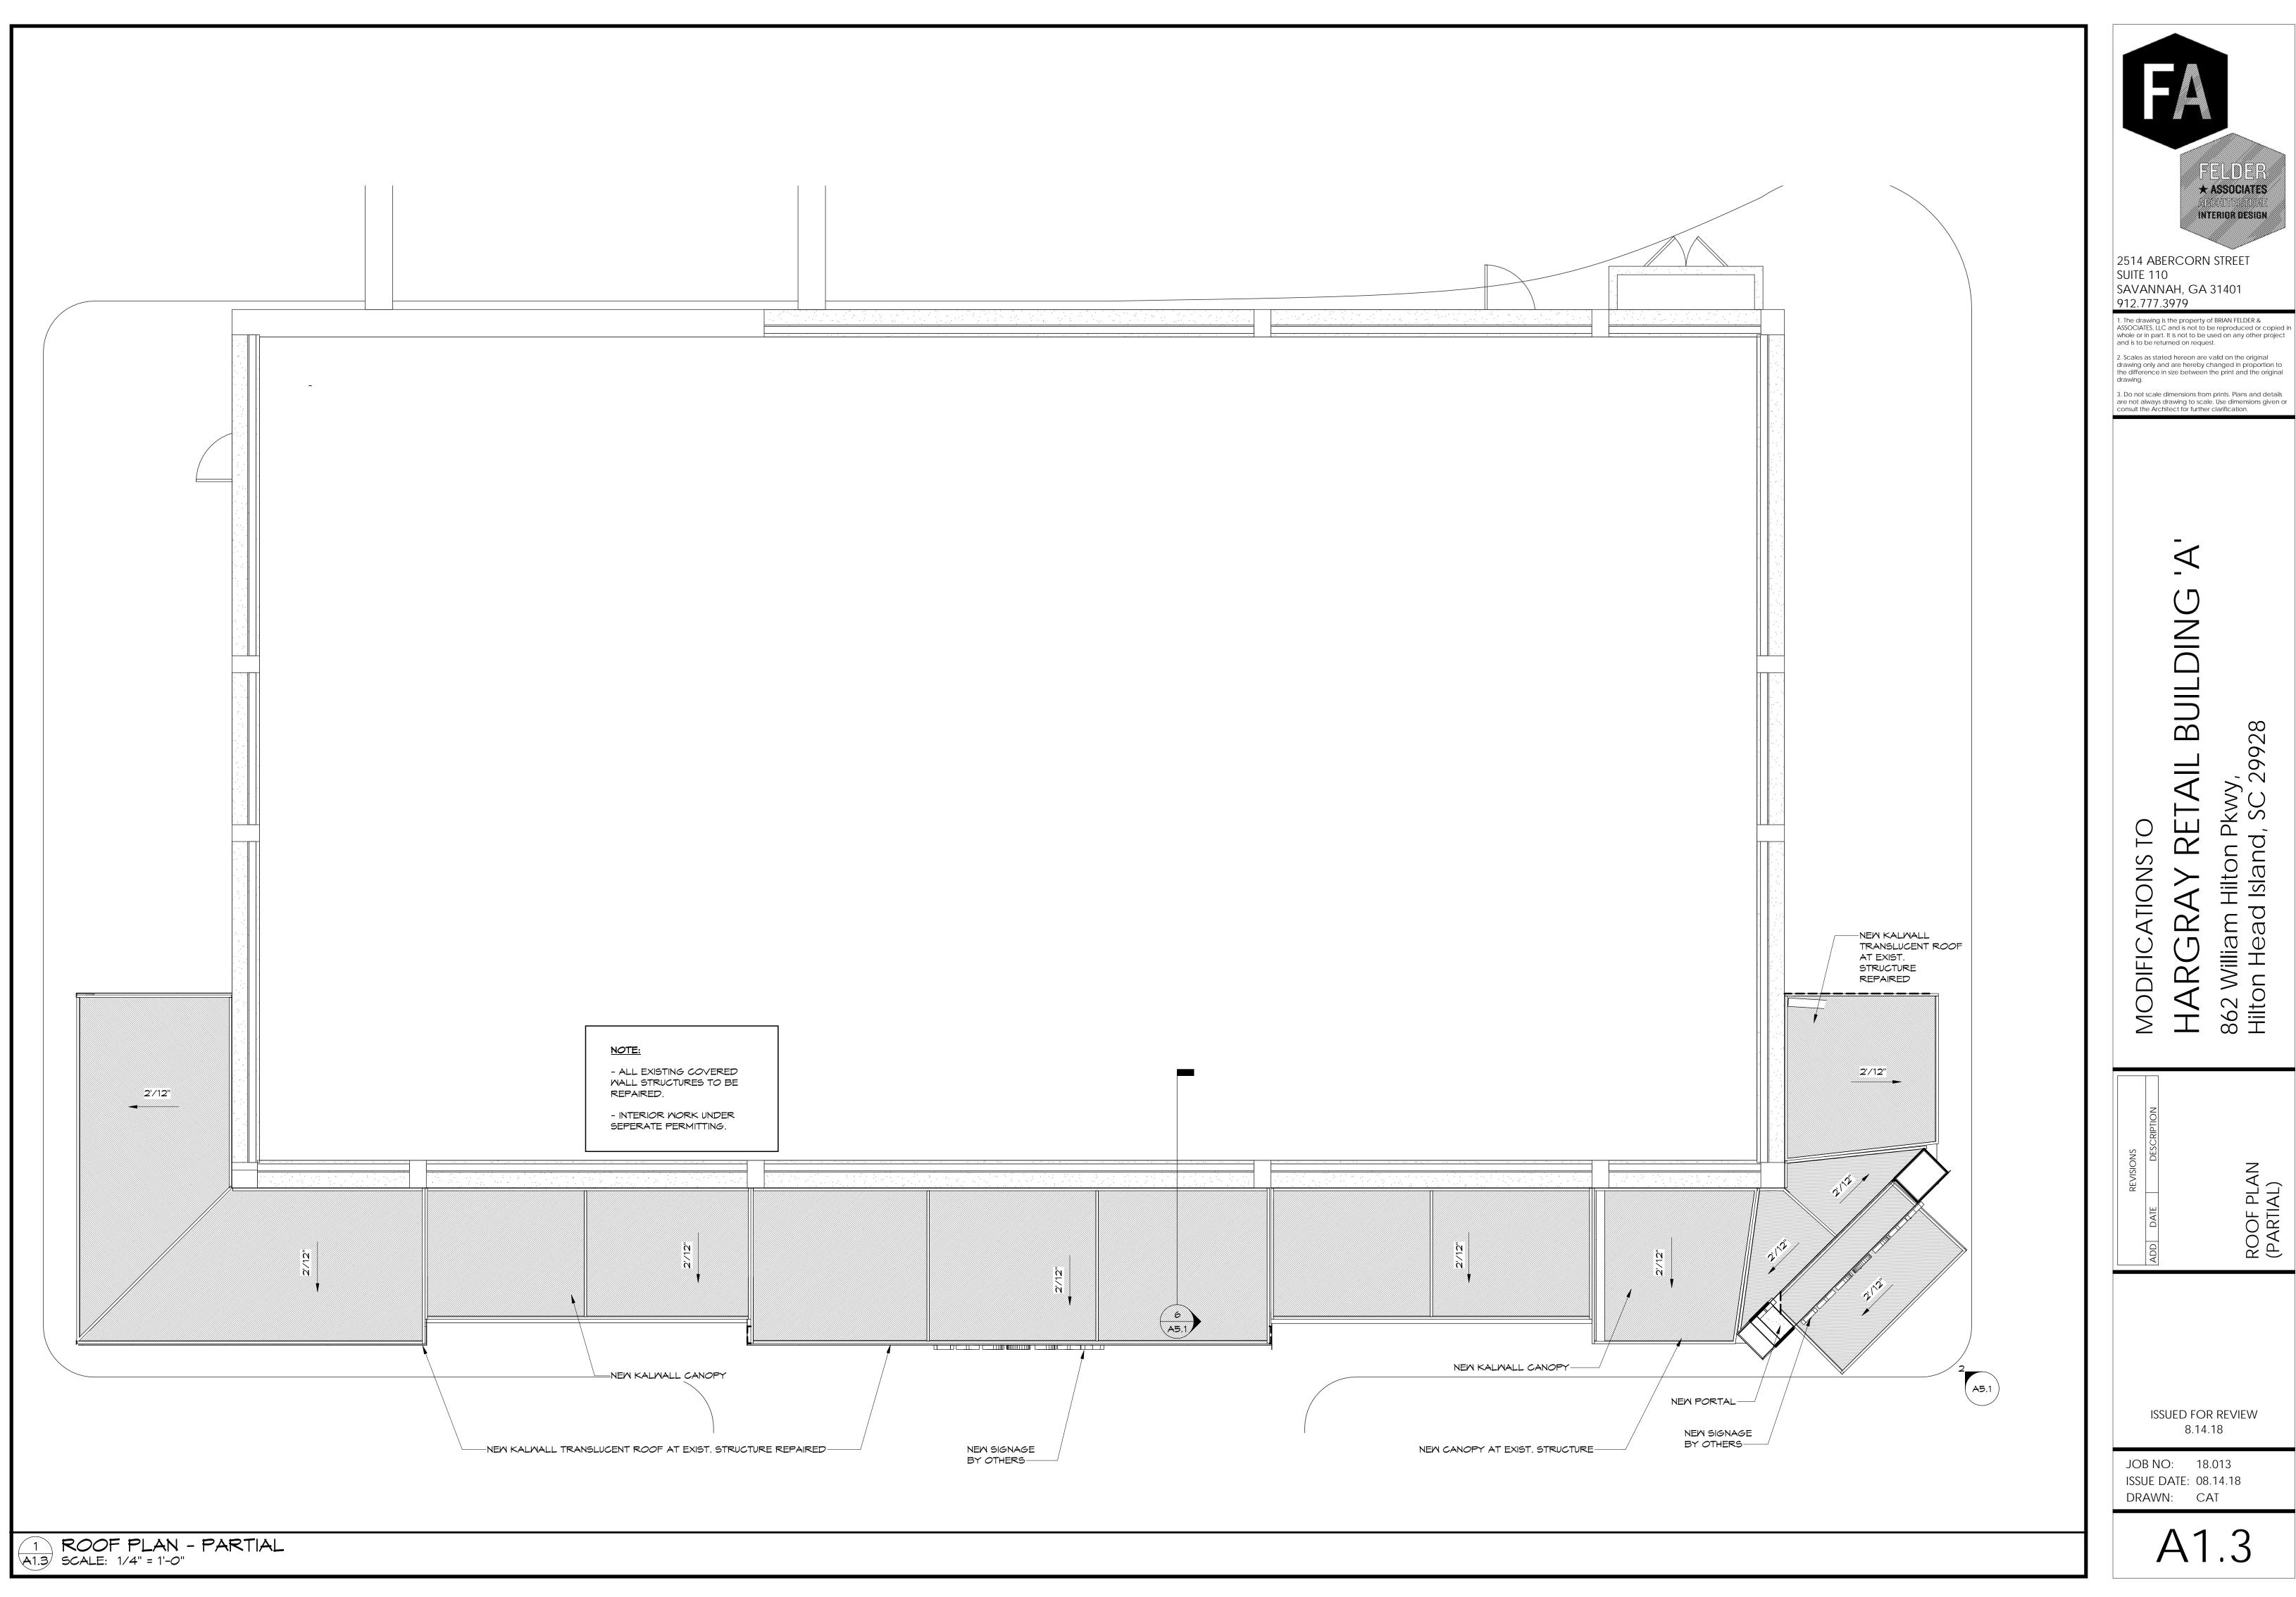

ROOF PLAN (PARTIAL)

ISSUED FOR REVIEW 8.14.18

JOB NO: 18.013 ISSUE DATE: 08.14.18 DRAWN: CAT



3 EXISTING FRONT ELEVATION PERSPECTIVE A3.0 SCALE:



2 EXISTING EAST CORNER PERSPECTIVE A3.0 SCALE:

MODIFICATIONS TO HARGRAY RETAIL BUILDING

2514 ABERCORN STREET

SAVANNAH, GA 31401

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SUITE 110

912.777.3979


XT. Hilton Head Island

EXIST. EXT. ELEVATIONS

ISSUED FOR REVIEW

JOB NO: 18.013
ISSUE DATE: 8.14.18
DRAWN: CAT

A3.0

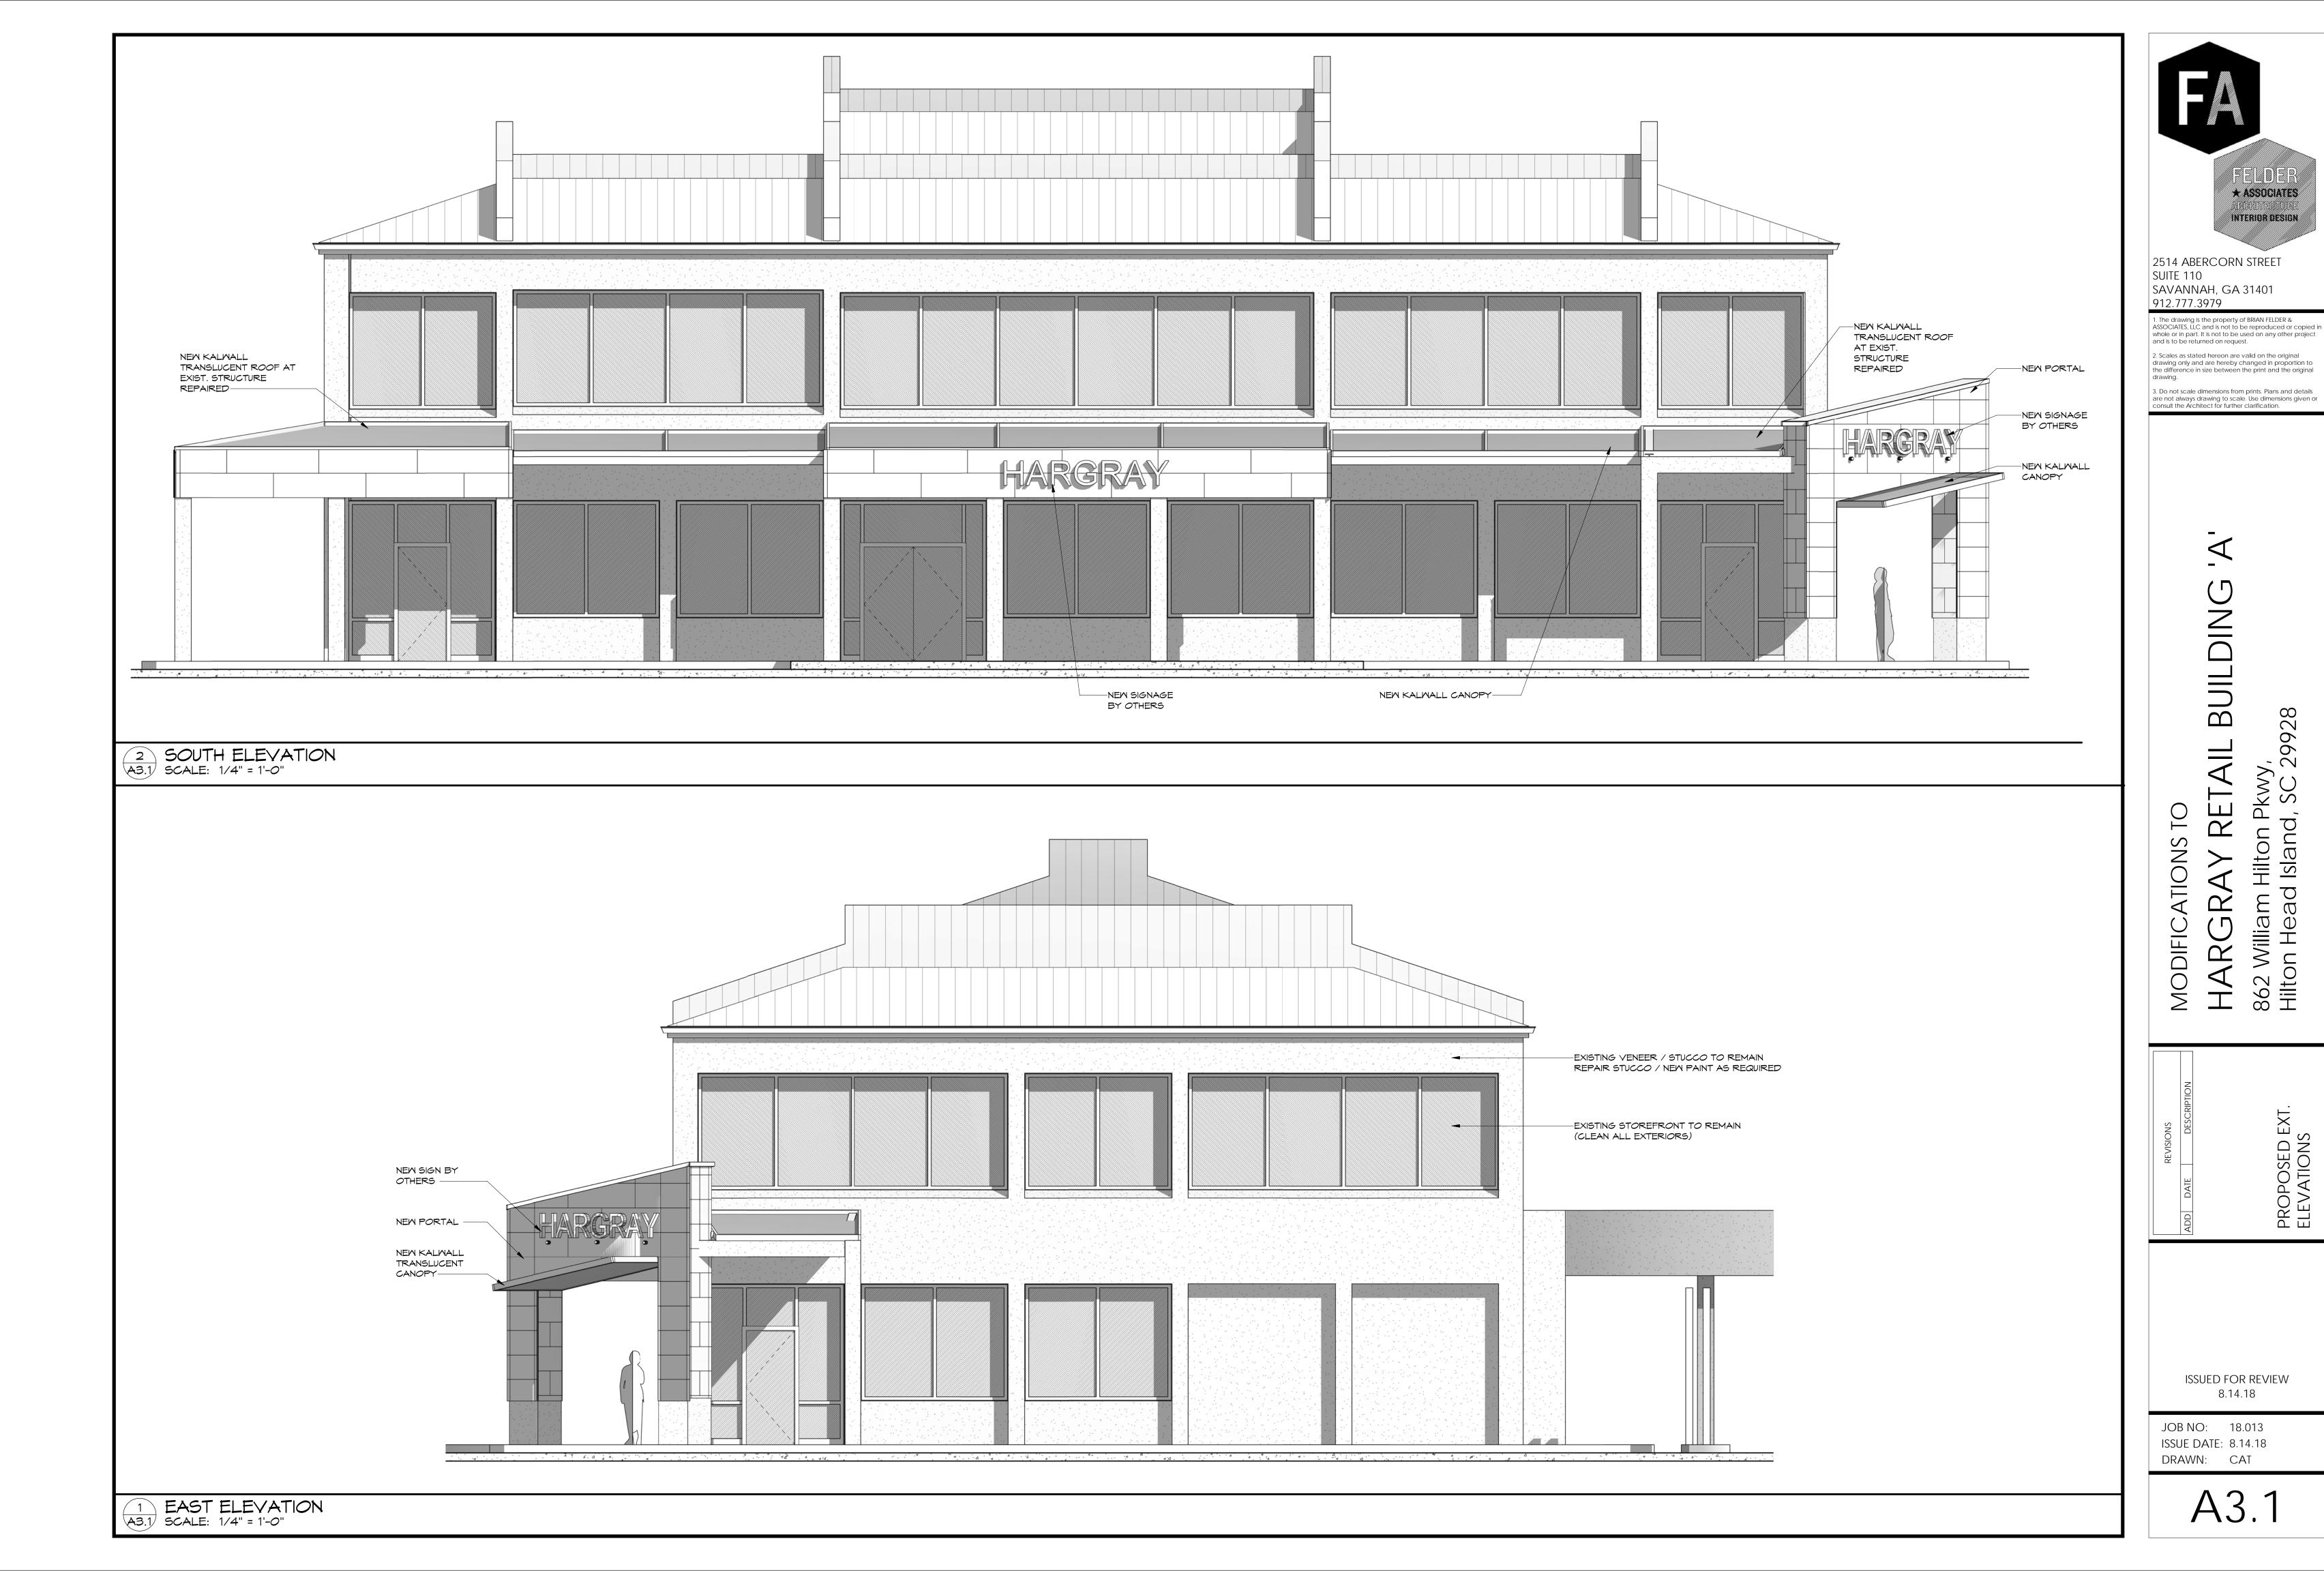

PROPOSED EXT. ELEVATIONS



2 FRONT ELEVATION A3.2 SCALE:



1 EAST CORNER PERSPECTIVE SCALE:

ARGRAY RETAIL BUILDING

2 William Hilton Pkwv,

MODIFICATIONS TO

2514 ABERCORN STREET

SAVANNAH, GA 31401

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SUITE 110


912.777.3979


IOR Hilto

JOB NO: 18.013 ISSUE DATE: 8.14.18

A3.2

ISSUED FOR REVIEW

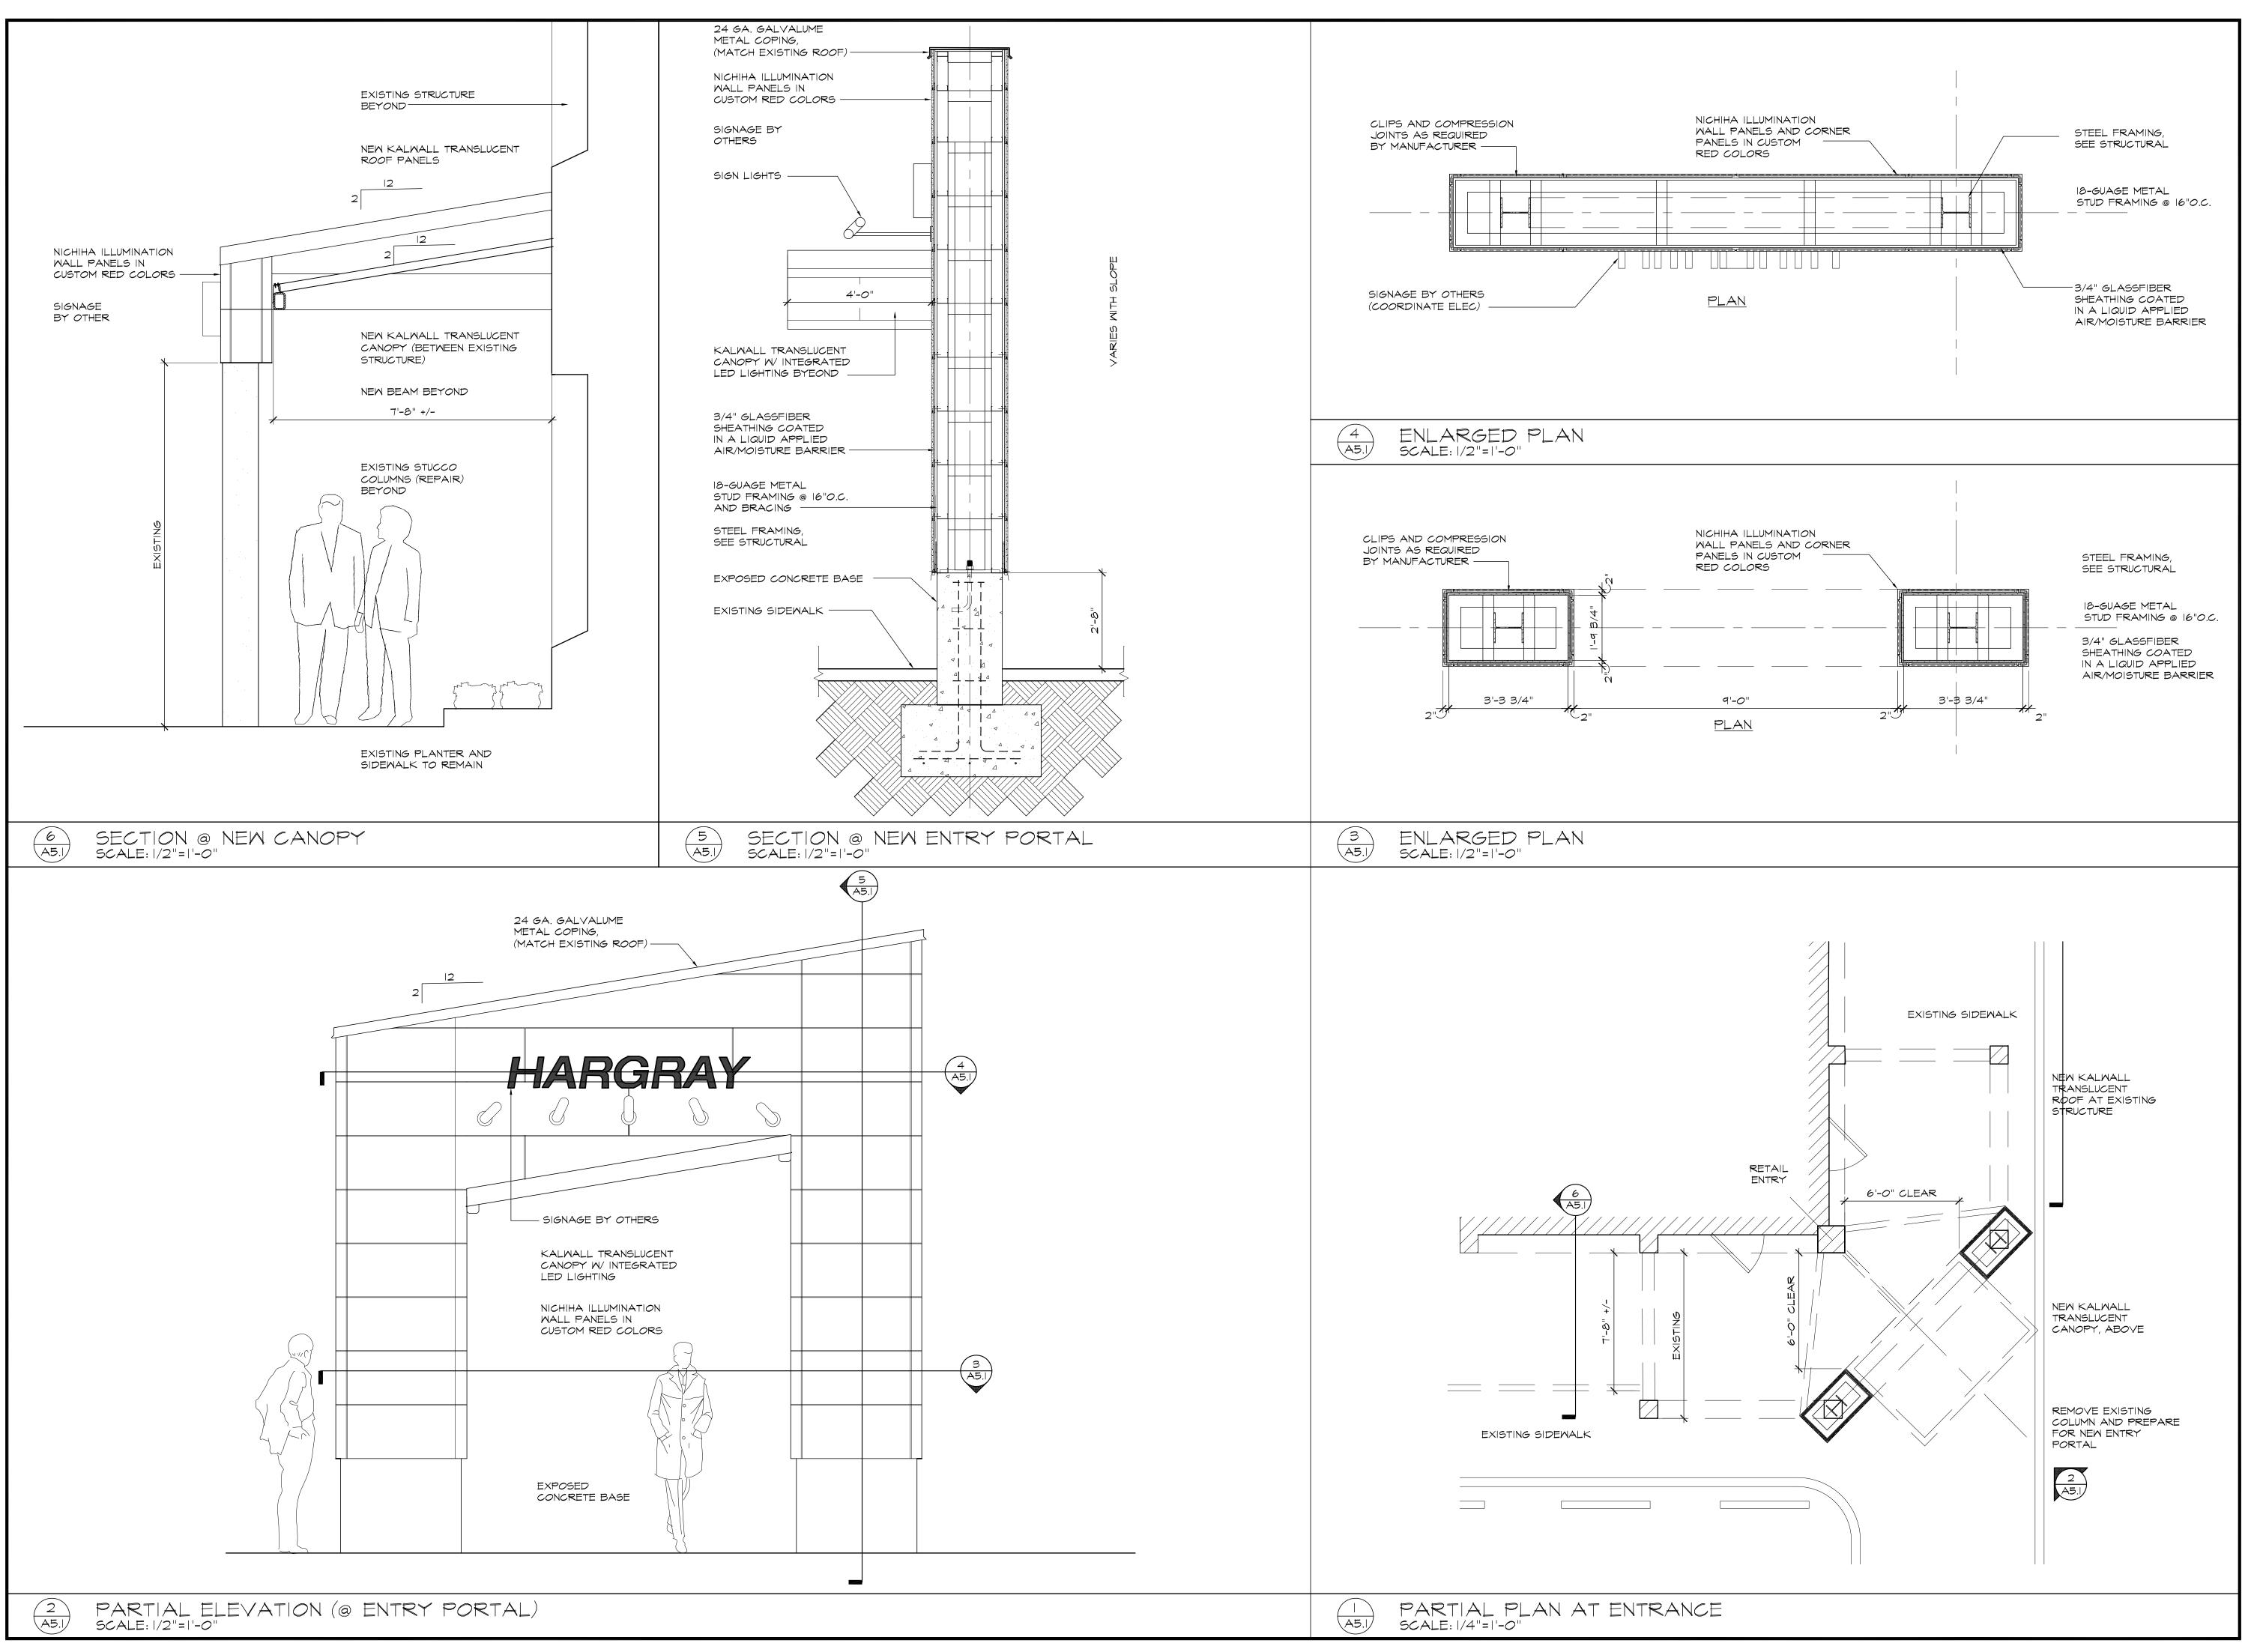

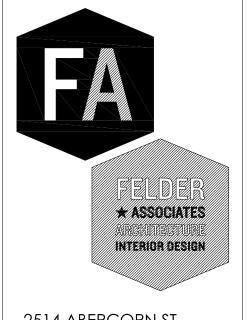

2514 ABERCORN ST. SUITE 110 SAVANNAH GA 31401 (912) 777-3979

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3. Do not scale dimensions from prints. Plans and details are not always drawn to scale. Use dimensions given or consult the Architect for further clarification.

AY RETAIL BUILDING 'A'

MC HA HITC DETAILS

ISSUED FOR REVIEW 8.14.18

JOB NO: 18.013
ISSUE DATE: 8.14.18
DRAWN: GOC

A5.1

# **DESIGN TEAM/DRB COMMENT SHEET**

The comments below are staff recommendations to the Design Review Board (DRB) and do NOT constitute DRB approval or denial.

PROJECT NAME: Hargray Building DRB#: DRB-001925-2018						
DATE: 08/16/2018						
RECOMMENDATION: Approval RECOMMENDED CONDITIONS:	Approval	with C	Conditions	Denial 🔀		
ARCHITECTURAL DESIGN						
DESIGN GUIDE/LMO CRITERIA	Complies Yes	No	Not Applicable	Comments or Conditions		
Utilizes natural materials and colors		$\boxtimes$		The red Nichiha architectural wall panels do not compliment the building and are not nature blending. Physical samples must be submitted for review and approval.		
Accessory elements are design to coordinate with the primary structure		$\boxtimes$		The asymmetrical sloped roof entrance portal does not relate to the building and is not in keeping with "Island Character". Consider a form or shape that references historical, "Island" architectural shapes.		
MISC COMMENTS/QUESTIONS						
1. Consider using a natural red on the letters in the st		_				
2. Is the existing landscape between the building and the sidewalk and under the Kalwall canopy irrigated? If not how will landscaping in this area be maintained?						



# Town of Hilton Head Island

Community Development Department
One Town Center Court

Hilton Head Island, SC 29928 Phone: 843-341-4757 Fax: 843-842-8908 www.hiltonheadislandsc.gov

FOR OFFICIAL US	E ONLY
Date Received:	
Accepted by:	
DRB #:	
Meeting Date:	

Applicant/Agent Name: Steven C	3. Stowers, AIA	Company	y:	Archited	ture 1	<b>)</b> 1	
Mailing Address: 21 B Market	et, Suite 1			State:			29906
Telephone: 843.790.4101 Fax	:N/A	E-mail:	Ste	eve@A101.De	esign	- 500 - 554 - 650	
Project Name: Renovations to 6 Lo	agoon Road	Project Address	s:	í Lagoon Rd,	HHI, S	C 299:	28
Parcel Number [PIN]: R 552 018 000							
Coning District: NC		Overlay Distric	<b>t(s):</b> For	est Beach			
	Annun on I						
DESIGN REVIEW B		REVIEW, M RB) SUBMIT		EQUIRE	ME	NTS	
Digital Submissions may be accepted	l via e-mail by c	alling 843-341-4	757.				
Project Category:							
Concept Approval – Proposed	Dovalonment		Α.	lteration/Add	tion		
Final Approval – Proposed De	STREET,		(i) (ii) (ii) (iii) (iii	ign	поп		
			31 - 3 - 3 - 3 - 3 - 3 - 3 - 3 - 3 - 3 -	in the second			
Submittal Requirements for All proje	cts:						
Private Architectural Review I jurisdiction of an ARB, the ap 2-103.I.4.b.iii.01. Submitting applicant.	plicant shall sub	mit such ARB's	written noti	ce of action p	er LM	O Secti	ion 16-
Filing Fee: Concept Approval- Alterations/Additions \$100, S:	Tanana Ali ili ili ili ili anno anno a manailli il ili il man	and the state of t	and the second s	200 - 100 ft - 100 mm - 100 mm - 100 ft 100			
Additional Submittal Requirements:  Concept Approval – Proposed Development	ale) of property losec. 16-6-104.C.  e specimen trees that ribing the design s.  coring uses and a	2, and if applicab , access, significan nay influence des intent of the projections	tle, location ant topographign. ect, its goal	of bordering	streets buffer es and	, marsh	nes and acks,
Conceptual sketches of primar	y exterior elevat	ions showing arc					•У•ш€•
development, materials, colors	development, materials, colors, shadow lines and landscaping.						

Last Revised 01/21/15

Additional Submittal Requirements:  Final Approval – Proposed Development  A final written narrative describing how the project conformer review guidelines of Sec. 16-3-106.F.3.  Final site development plan meeting the requirements of Final site lighting and landscaping plans meeting the requirements of Final floor plans and elevation drawings (1/8"=1'-0" min colors with architectural sections and details to adequate A color board (11"x17" maximum) containing actual color elevations, and indicating the manufacturer's name and of Any additional information requested by the Design Reviscale model or color renderings, that the Board finds need	Appendix D: D-6.F. uirements of Appendix D: D-6.H and D-6.I. imum scale) showing exterior building materials and ely describe the project. or samples of all exterior finishes, keyed to the color designation. riew Board at the time of concept approval, such as
Additional Submittal Requirements:  Alterations/Additions  All of the materials required for final approval of propose additional materials.  A survey (1"=30' minimum scale) of property lines, exist tree protection regulations of Sec. 16-6-104.C.2, and if a beaches.  Photographs of existing structure.	ting topography and the location of trees meeting the
Additional Submittal Requirements:  Signs  Accurate color rendering of sign showing dimensions, ty  For freestanding signs:  Site plan (1"=30" minimum scale) showing location of s and property lines.  Proposed landscaping plan.  For wall signs:  Photograph or drawing of the building depicting the projection of th	ign in relation to buildings, parking, existing signs, posed location of the sign.
Note: All application items must be received by the deadline date in order A representative for each agenda item is strongly encouraged to attend Are there recorded private covenants and/or restrictions the proposed request? If yes, a copy of the private covenants application. YES NO	the meeting. that are contrary to, conflict with, or prohibit
To the best of my knowledge, the information on this applicatual, and complete. I hereby agree to abide by all conditions Head Island. I understand that such conditions shall application transferable by sale.	ons of any approvals granted by the Town of Hilton
I further understand that in the event of a State of Emergence set forth in the Land Management Ordinance may be suspend	
SIGNATURE	8/15/18 DATE

Last Revised 01/21/15

2

August 14, 2018

Town of Hilton Head Island Community Development Department One Town Center Court Hilton Head Island, SC 29928



Project: Exterior Improvements to 6 Lagoon Road, Hilton Head Island, South Carolina

Please accept this design information for the proposed exterior improvements to the existing structure at 6 Lagoon Road. This building is part of Coligny Plaza.

# PROJECT DESCRIPTION

This project seeks to provide a new second level balcony and a new trellis along the Lagoon Road side of the building, replacing the dated and unsightly canvas canopy. The balcony will serve two tenant suites on the north side of the building and provide a location for new signage for the first floor tenant that will be submitted under a later application.

Additionally, the project will provide two second story porches for the tenants on the south side of the building, also provided with matching trellises.

Landscaping will also be replaced for the development to accommodate the new alterations.

Thank you for your consideration.

Sincerely,

Steven G. Stowers, AIA, LEED AP

Note from Staff,

This application includes a request for DRB approval of the asphalt shingle that has recently been added to the building replacing the wood shingles (see submission photos). This shingle matches other shingles at Colignly Plaza.

# ALLEGRO W LED

Architectural Outdoor


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PROJECT:	
TYPE:	
PO#:	QTY:
COMMENTS:	

## **FEATURES**

- Aluminum Housing w/ Textured Black Polyester Powder Coat Finish
- · Aluminum End Caps and Trim Bars w/ Textured Black Polyester Powder Coat Finish
- Aluminum Mount Pan w/ Hi-Reflectance White Powder Coat Finish
- Luminous White Acrylic Wrap-Around Diffuser
- Luminous White Acrylic Top and Bottom Lens Panels
- Mounts Over 4" Junction Box w/ Easy-hang Wall Mounting Plate (Included)
- CSA Approved For Wet Location For Vertical Mounting
- LED Light Fixture
- · Mounting Hardware Included
- Vandal Resistant

## LINE DRAWING



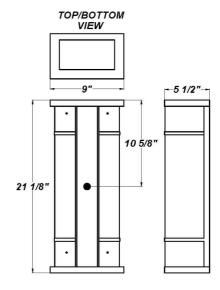





Antique CopPer Swedish











Matte Metallic Silver









TERONLIGHTING.COM

Textured White

> For RAL Colors & Custom Match -**Contact Teron** Lighting Inc.









# ALLEGRO W LED

Architectural Outdoor



 PROJECT:

 TYPE:

 PO#:
 QTY:

 COMMENTS:
 QTY:

Fixture Core

PRODUCT CODE	SOURCE/WATTAGE	VOLTAGE	DIMMING DRIVER
<b>ALLW</b> - Allegro W	L19.0-ZE700 - 30W @ 700mA 0-10V Dimming Driver L24.0-ZE875 - 33W @ 875mA 0-10V Dimming Driver L31.0-ZE1150 - 44W @ 1150mA 0-10V Dimming Driver	120V 277V (50 / 60Hz)	Not Applicable
ORDER INFO			
ALLW	L19.0-ZE700	120V	Not Applicable

Example ^ (may not represent a manufacturable product)

#### Aesthetics & Options

TRIM	FINISH	COLOR TEMP	OPTIONS
Not Applicable	AC - Antique CopPer AS - Antique Silver BT - Bronze Mist MB - Metallic Black SM - Matte Silver SN - Sand SW - Swedish Steel  TB - Textured Black (Standard) BZ - Textured Bronze TW - Textured White	<b>30K</b> - 3000K Color Temp <b>35K</b> - 3500K Color Temp <b>40K</b> - 4000K Color Temp	F - Fused TP - Tamper Resistant Screws
ORDER INFO			
Not Applicable	AC	:30K	F

Example ^ (may not represent a manufacturable product)

PROD	SOURCE	30K SPECS
ALLW	L19.0	30K - 3000K     Color Temp      2489 LED     Source Lumens      113 LED Source     Lumens Per Watt
	L24.0	30K - 3000K     Color Temp     3180 LED     Source Lumens     106 LED Source     Lumens Per Watt
	L31.0	30K - 3000K     Color Temp     4125 LED     Source Lumens     106 LED Source     Lumens Per Watt

REPLACEMENT	PART
White Acrylic Lens	
Assembly	

9801460

NOTES

Don't see the configuration you are looking for? Call us today at (513) 858-6004





■ SEND CUT-SHEET

#### HALO LED ICAT HOUSING for NEW CONSTRUCTION

The H750ICAT is a dedicated LED new construction housing to be used with designated HALO LED modules. The H750ICAT is designed for insulated ceilings and can be in direct contact with ceiling insulation\*. This AIRTITE housing design prevents airflow between conditioned and unconditioned spaces and saves on both heating and air conditioning costs. The LED connector system provides high efficacy code compliance when used with designated HALO LED modules and trims.

Catalog #	Туре
Project	
Comments	Date
Prepared by	

### **DESIGN FEATURES**

#### Housings

Aluminum construction for greater heat dissipation. H750 ICAT housing is gasketed to prevent airflow from heated or air conditioned spaces.

#### **Plaster Frame**

Galvanized steel frame. Housing adjusts in plaster frame to accommodate up to 1" ceiling thickness. Regressed locking screw for securing hanger bars. Cutouts included for easily crimping hanger bars in position

#### Slide-N-Side™ Junction Box

- Positioned to accommodate straight conduit runs.
- Seven ½" trade size conduit knockouts with true pry-out slots.
- Slide-N-Side wire traps allow non metallic sheathed cable to be installed without tools and without removing knockouts.
- Allows wiring connections to be made outside the box.
- Simply insert the cable directly into the trap after connections are made.
- Accommodates the following standard non-metallic sheathed cable type:
- U.S. #14/2, #14/3, #12/2, #12/3
- Canada: #14/2, #14/3, #12/2

### GOT NAIL! Pass -N-Thru™ Bar Hangers

Bar Hanger features include

- Pre-installed nail easily installs in regular lumber, engineered lumber and laminated beams.
- Safety and Guidance system prevents snagging, ensures smooth, straight nail penetration and allows bar hangers to be easily removed if necessary
- Automatic leveling flange aligns the housing and allows holding the housing in place with one hand while driving nails.
- Housing can be positioned at any point within 24" joist spans
- Score lines allow tool-free shortening for 12" joists and bar hangers do not need to be removed for shortening.
- Bar hangers may be repositioned 90° on plaster frame
- Integral T-bar clip snaps onto T-bars – no additional clips are required.

#### **LED Module Connection**

Halo LED modules simply install with a plug-in 120V-277V rated line voltage wiring connector (UL and CSA Listed Luminaire Disconnect). This non-screw-base connection preserves the high efficacy rating and prevents use of low efficacy incandescent sources (see LED Module specifications).

#### Caution

Connection is rated for 120V and 277V input. Installer must verify LED module voltage is compatible with the applicable voltage input. If uncertain, consult a qualified electrician.

### Labels

- UL/cUL Listed 1598 Luminaire
- CE Marking "Conformité Européene" conformity with the Council of European Communities Directives, meeting internationally recognized compliance when used with ML56 Series LED modules
- UL/cUL Listed for Feed Through
- UL/cUL Listed for Damp Location
- UL/cUL Listed for Wet Location with select trims
- UL/cUL Listed for direct contact with insulation and combustible material\*
- Rated for 20W maximum

#### Qualification

May be used with qualified Halo LED modules and designated trims for High Efficacy Luminaire Compliance:

- State of California Title 24
- International Energy Conservation Code (IECC)
- Washington State Energy Code
- New York State Energy Conservation Construction Code
   AIR-TITE™ Compliant
- Certified under ASTM-E283 standard for air-tight construction



### H750ICAT

6" New Construction IC AIR-TITE™ Housing For

Halo LED Modules and Trims

- ML56 Series
- RL56 Series

**High Efficacy LED Housing** 

FOR USE IN INSULATED CEILINGS

FOR DIRECT CONTACT WITH INSULATION\*

















Qualified and compliant with select trims. Refer to ENERGY STAR® Qualified Products List and CEC (T24) Appliance Database for listings.

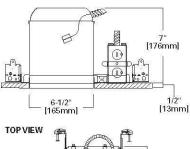

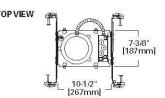



### **ORDERING INFORMATION - RL56 SERIES**

**SAMPLE NUMBER:** H750ICAT - RL560WH6927 Order housing, light module, trim and separately.

Housing	RL56 LED - Compatible LED Retrofit Modules
H750ICAT= 6" Aperture, New Construction, IC AIR-TITE™, High Efficacy LED Housing	80 CRI  RL560WH6827= 5"/6" Retrofit Baffle - Trim LED Module, 80CRI, 2700K, Matte White RL560SN6827= 5"/6" Retrofit Baffle - Trim LED Module, 80CRI, 2700K, Satin Nickel RL560WH6830= 5"/6" Retrofit Baffle - Trim LED Module, 80CRI, 3000K, Matte White RL560SN6830= 5"/6" Retrofit Baffle - Trim LED Module, 80CRI, 3000K, Satin Nickel RL560WH6835= 5"/6" Retrofit Baffle - Trim LED Module, 80CRI, 3500K, Matte White PL560WH6835= 5"/6" Retrofit Baffle - Trim LED Module, 80CRI, 2700K, Matte White RL560WH6927= 5"/6" Retrofit Baffle - Trim LED Module, 90CRI, 2700K, Satin Nickel RL560WH6930= 5"/6" Retrofit Baffle - Trim LED Module, 90CRI, 3000K, Satin Nickel RL560SN6930= 5"/6" Retrofit Baffle - Trim LED Module, 90CRI, 3000K, Matte White RL560SN6930= 5"/6" Retrofit Baffle - Trim LED Module, 90CRI, 3000K, Satin Nickel RL560WH6935= 5"/6" Retrofit Baffle - Trim LED Module, 90CRI, 3000K, Matte White RL560WH6935= 5"/6" Retrofit Baffle - Trim LED Module, 90CRI, 3000K, Matte White

### **ORDERING INFORMATION - RA56 SERIES**

**SAMPLE NUMBER:** H750ICAT - RA5606927WH Order housing, light module, trim and separately.

Housing	RA56 LED - Compatible LED Retrofit Modules
H750ICAT= 6" Aperture, New Construction, IC AIR-TITE™, High Efficacy LED Housing	Very Wide Flood - VWFL Models  RA5606927WH= 5"/6" LED Adjustable Gimbal, 90CRI, 2700K, White, Very Wide Flood RA5606930WH= 5"/6" LED Adjustable Gimbal, 90CRI, 3000K, White, Very Wide Flood  Narrow Flood - NFL Models  RA5606927NFLWH= 5"/6" LED Adjustable Gimbal, 90CRI, 2700K, White, Narrow Flood RA5606930NFLWH= 5"/6" LED Adjustable Gimbal, 90CRI, 3000K, White, Narrow Flood

## **ORDERING INFORMATION - ML56 SERIES**

**SAMPLE NUMBER:** H750ICAT - ML5606830 - 693WB Order housing, light module, trim and separately.

lousing	ML56 LED Light Modules	ML56 LED Trims	ML56 System Accessories
750ICAT= 6" Aperture, New Construction, IC (AIR-TITETM, High Efficacy LED (Housing)	600 Series / 80 CRI ML5606827= 5"/6" LED Retrofit Downlight Light Module, 600 lumen, 80CRI, 2700K ML5606830= 5"/6" LED Retrofit Downlight Light Module, 600 lumen, 80CRI, 3000K ML5606835= 5"/6" LED Retrofit Downlight Light Module, 600 lumen, 80CRI, 3500K ML5606840= 5"/6" LED Retrofit Downlight Light Module, 600 lumen, 80CRI, 4000K  600 Series / 90 CRI ML5606927= 5"/6" LED Retrofit Downlight Light Module, 600 lumen, 90CRI, 2700K ML5606930= 5"/6" LED Retrofit Downlight Light Module, 600 lumen, 90CRI, 2700K ML5606930= 5"/6" LED Retrofit Downlight Light Module, 600 lumen, 90CRI, 3000K ML5606940= 5"/6" LED Retrofit Downlight Light Module, 600 lumen, 90CRI, 4000K  900 Series / 80 CRI ML5609827= 5"/6" LED Retrofit Downlight Light Module, 900 lumen, 80CRI, 2700K ML5609830= 5"/6" LED Retrofit Downlight Light Module, 900 lumen, 80CRI, 2700K ML5609835= 5"/6" LED Retrofit Downlight Light Module, 900 lumen, 80CRI, 3500K ML5609840= 5"/6" LED Retrofit Downlight Light Module, 900 lumen, 80CRI, 3500K ML5609840= 5"/6" LED Retrofit Downlight Light Module, 900 lumen, 80CRI, 3500K ML5609840= 5"/6" LED Retrofit Downlight Light Module, 900 lumen, 90CRI, 2700K ML5609927= 5"/6" LED Retrofit Downlight Light Module, 900 lumen, 90CRI, 2700K ML5609935= 5"/6" LED Retrofit Downlight Light Module, 900 lumen, 90CRI, 2700K ML5609940= 5"/6" LED Retrofit Downlight Light Module, 900 lumen, 90CRI, 3000K ML5609945= 5"/6" LED Retrofit Downlight Light Module, 900 lumen, 90CRI, 3000K ML5612830= 5"/6" LED Retrofit Downlight Light Module, 900 lumen, 90CRI, 3000K ML5612840= 5"/6" LED Light Module, 1200 lumen, 80CRI, 2700K ML5612840= 5"/6" LED Light Module, 1200 lumen, 80CRI, 3000K ML5612840= 5"/6" LED Light Module, 1200 lumen, 90CRI, 3000K ML5612940= 5"/6" LED Light Module, 1200 lumen, 90CRI, 3000K ML5612940= 5"/6" LED Light Module, 1200 lumen, 90CRI, 3000K ML5612940= 5"/6" LED Light Module, 1200 lumen, 90CRI, 3000K		ML56CLIP= 6" Friction Clip Kit - For use with inon-torsion spring housings. 6" clips included.)  WW6955C= Wall Wash Insert - Specular Kick Reflector for 695WW (1 included with trim), For double wall washir or replacement.  TRM690WH= 6" LED Oversize Trim Ring for use with 59" series trims, White 6.9" I.D., 9.5" O.D. Ring slips over LED trim. Inset design allows 6" trim to fit into oversize ring for an even trim surface  EBA560PK= Replacement screwbase adapter to LED disconnect with cap  ML56-1200 Series Beam Forming Optic Med BFR56NFL=Beam forming reflector kit, narrow flood, 25° nominal  BFR56MH=Media holder, accepts one 3.45" lens. Requires BFR56NFL & L345S order separately.  L345SF=3.45" diameter soft focus lens. Requires BFR56NFL and BFR56MH, order separately.













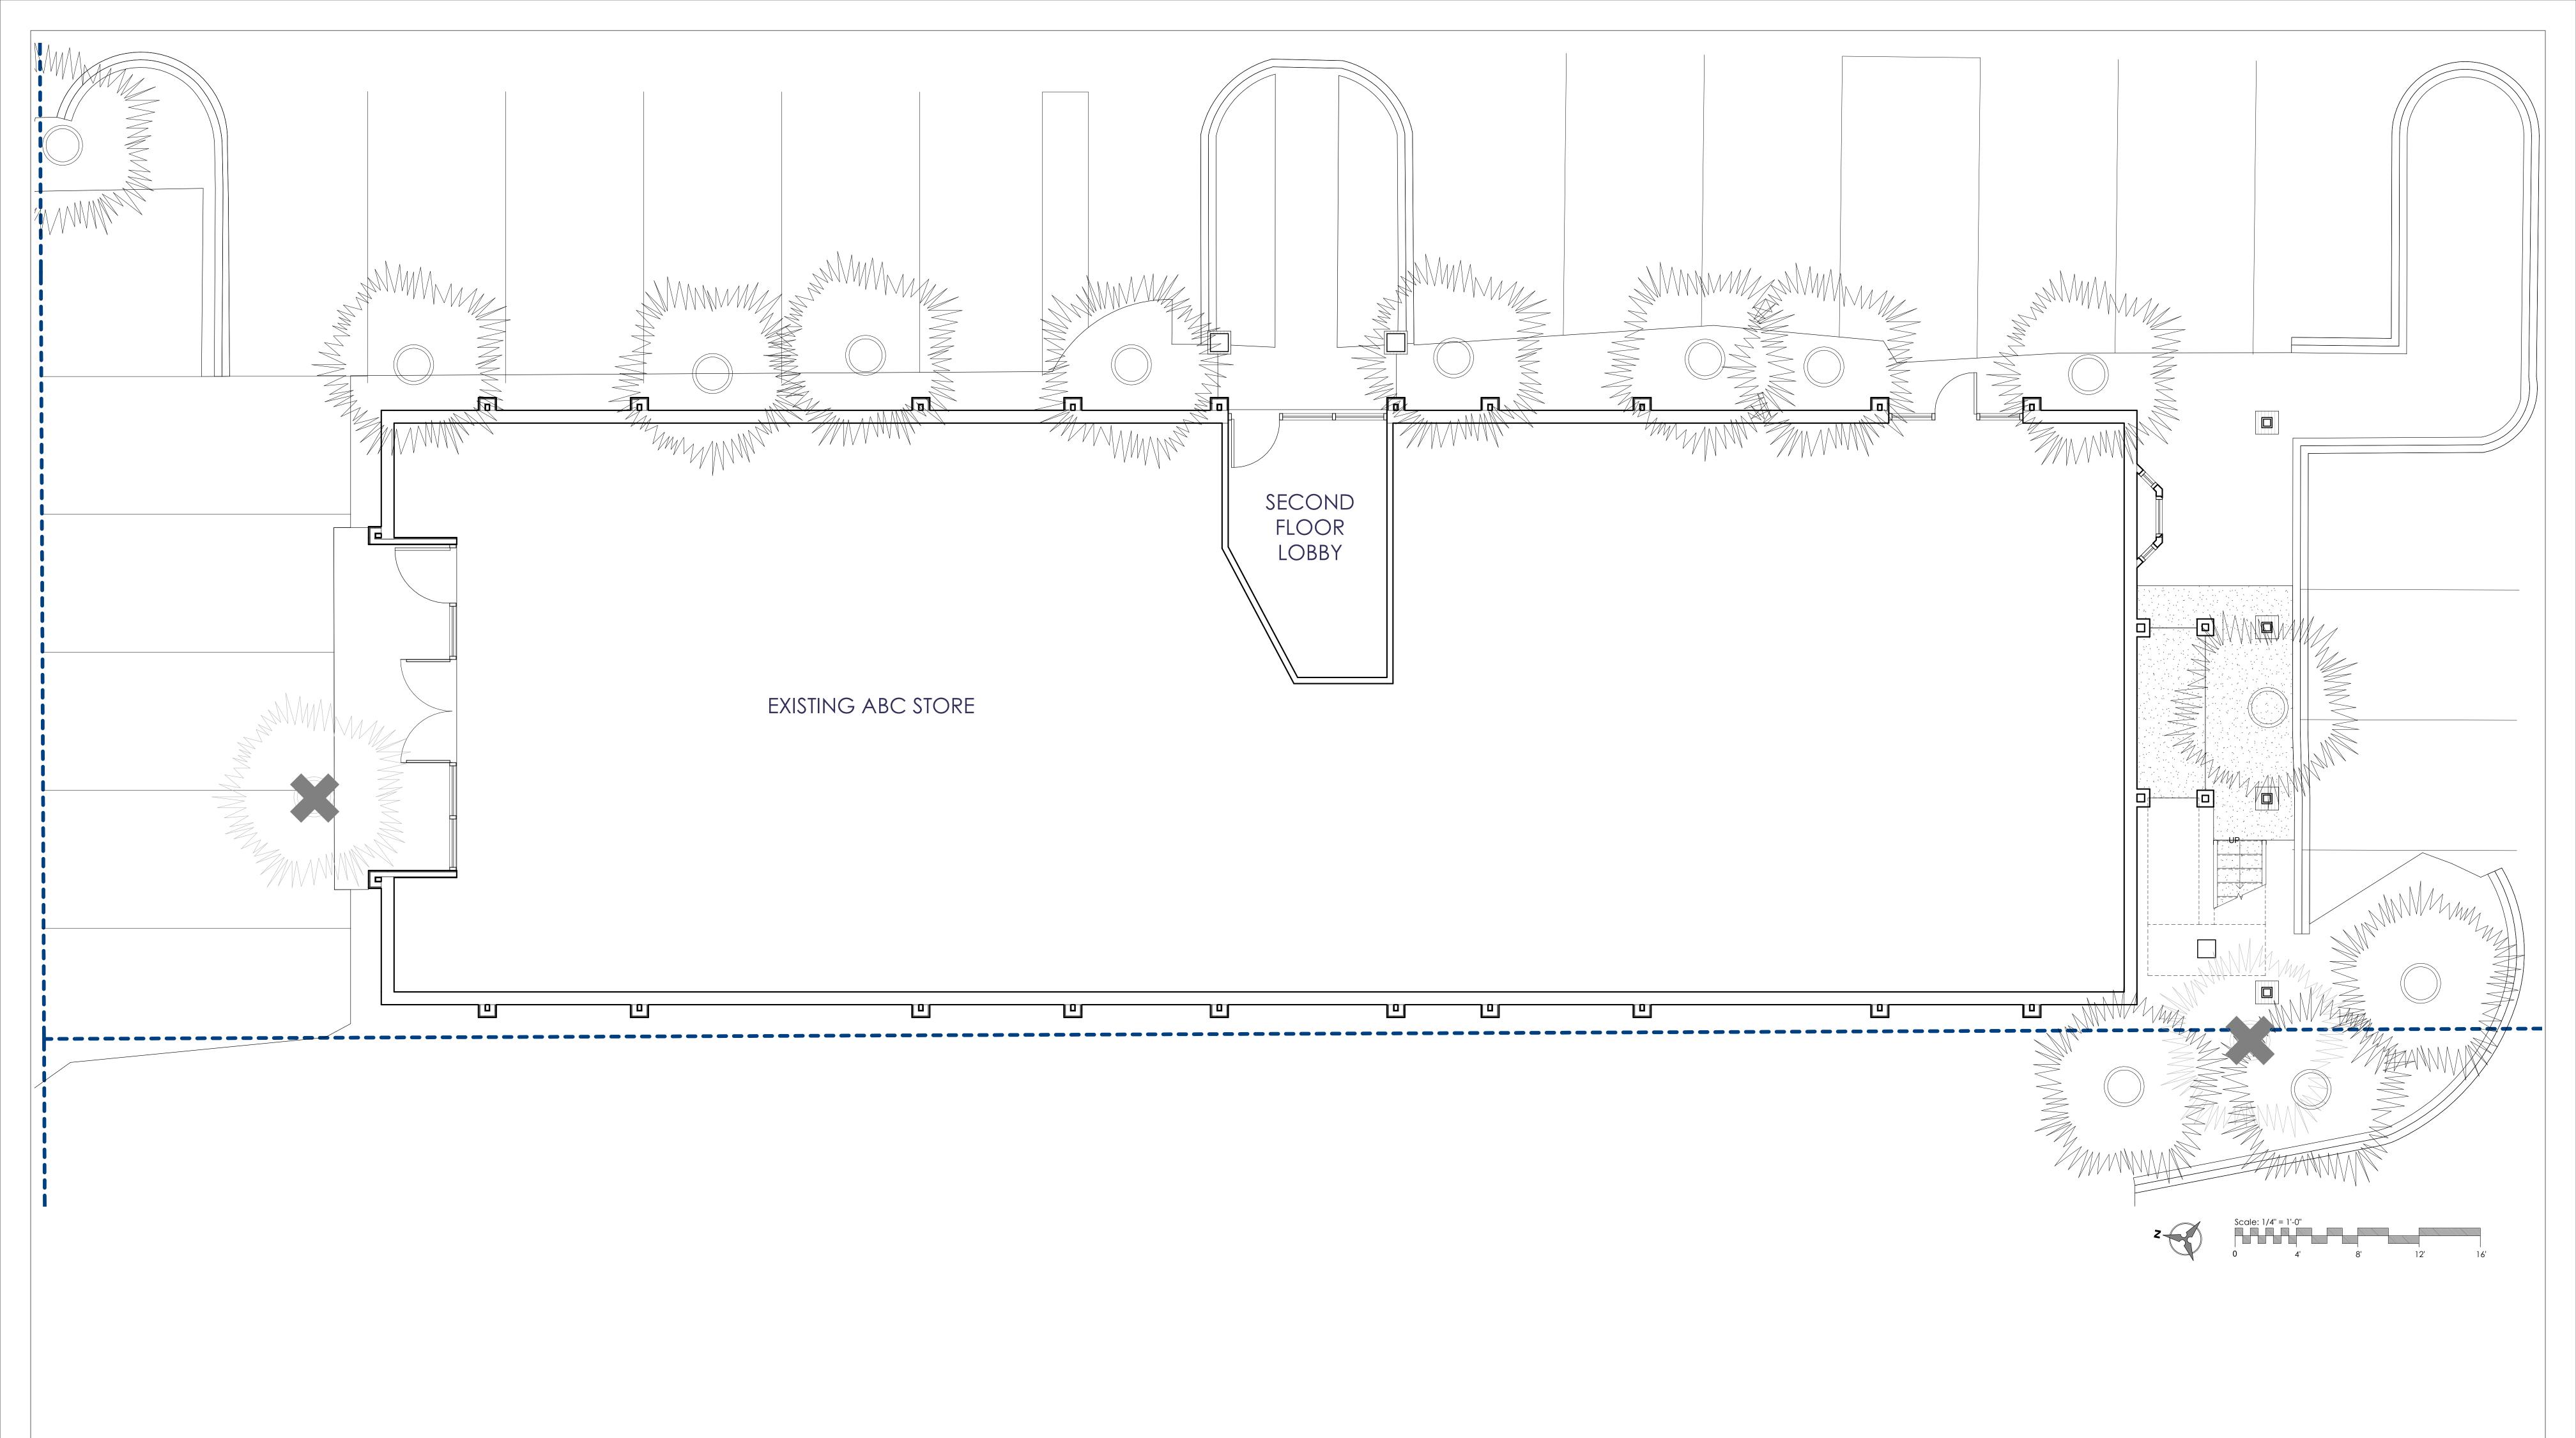




First Floor Plan

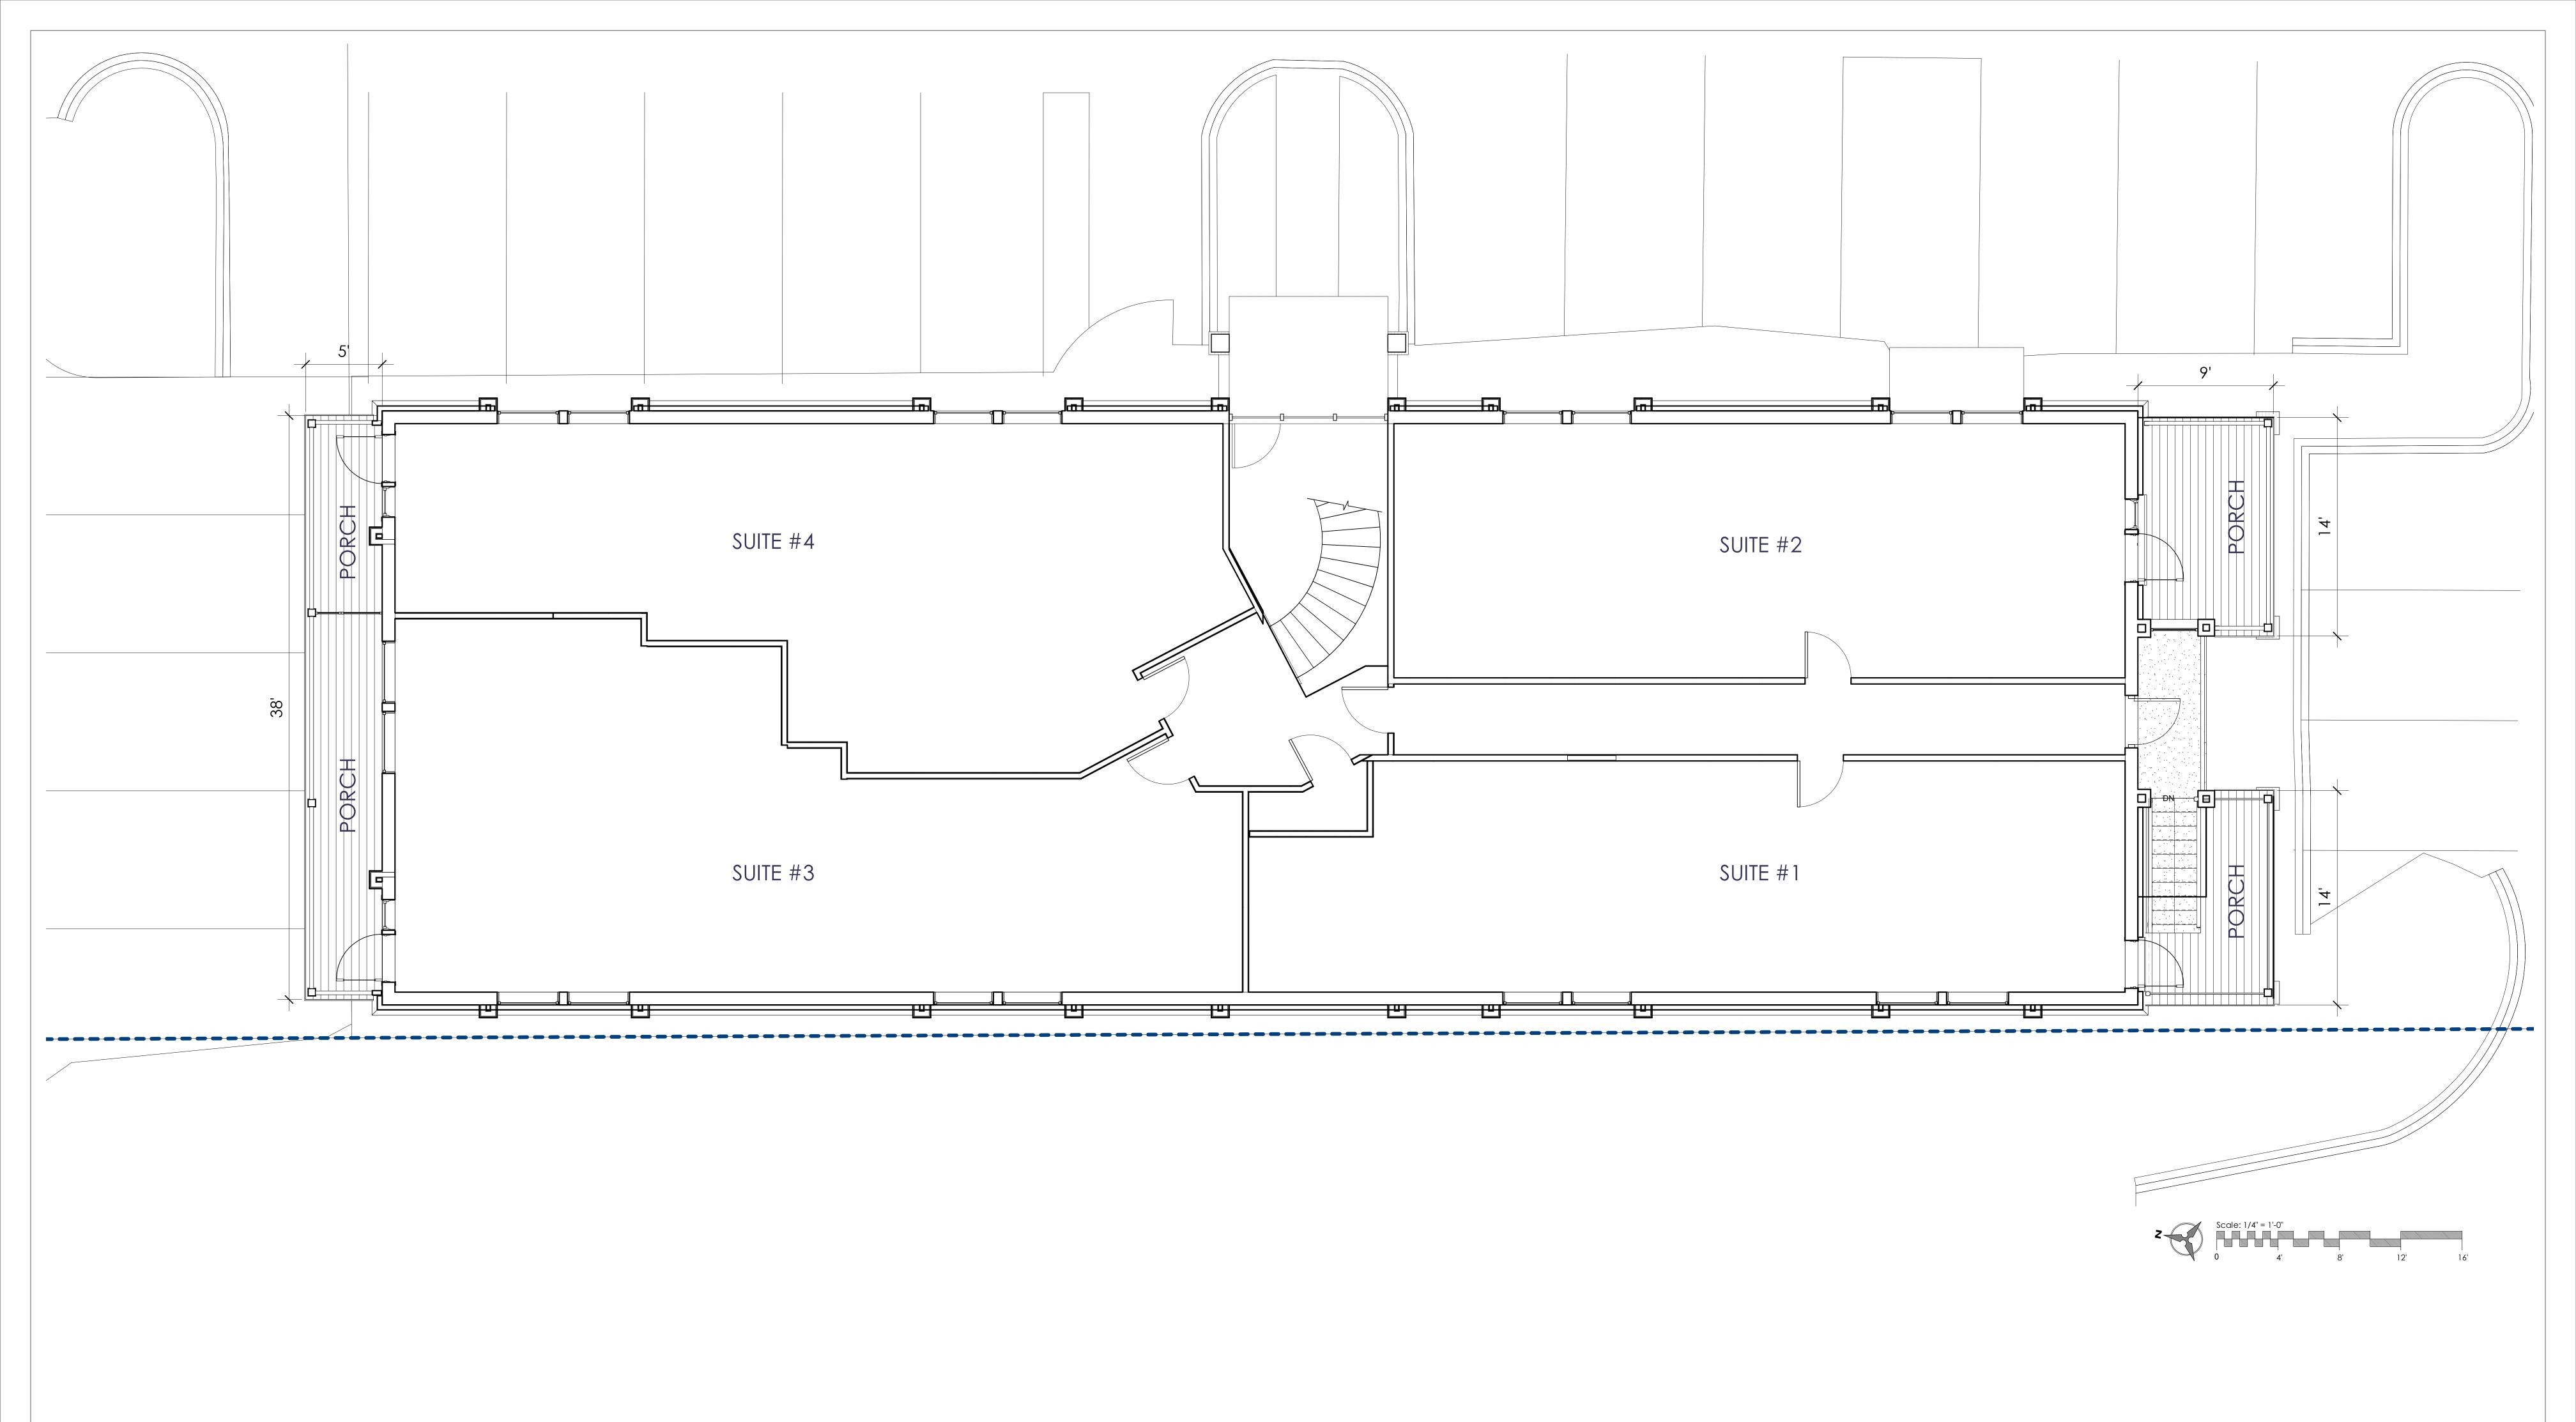




Second Floor Plan

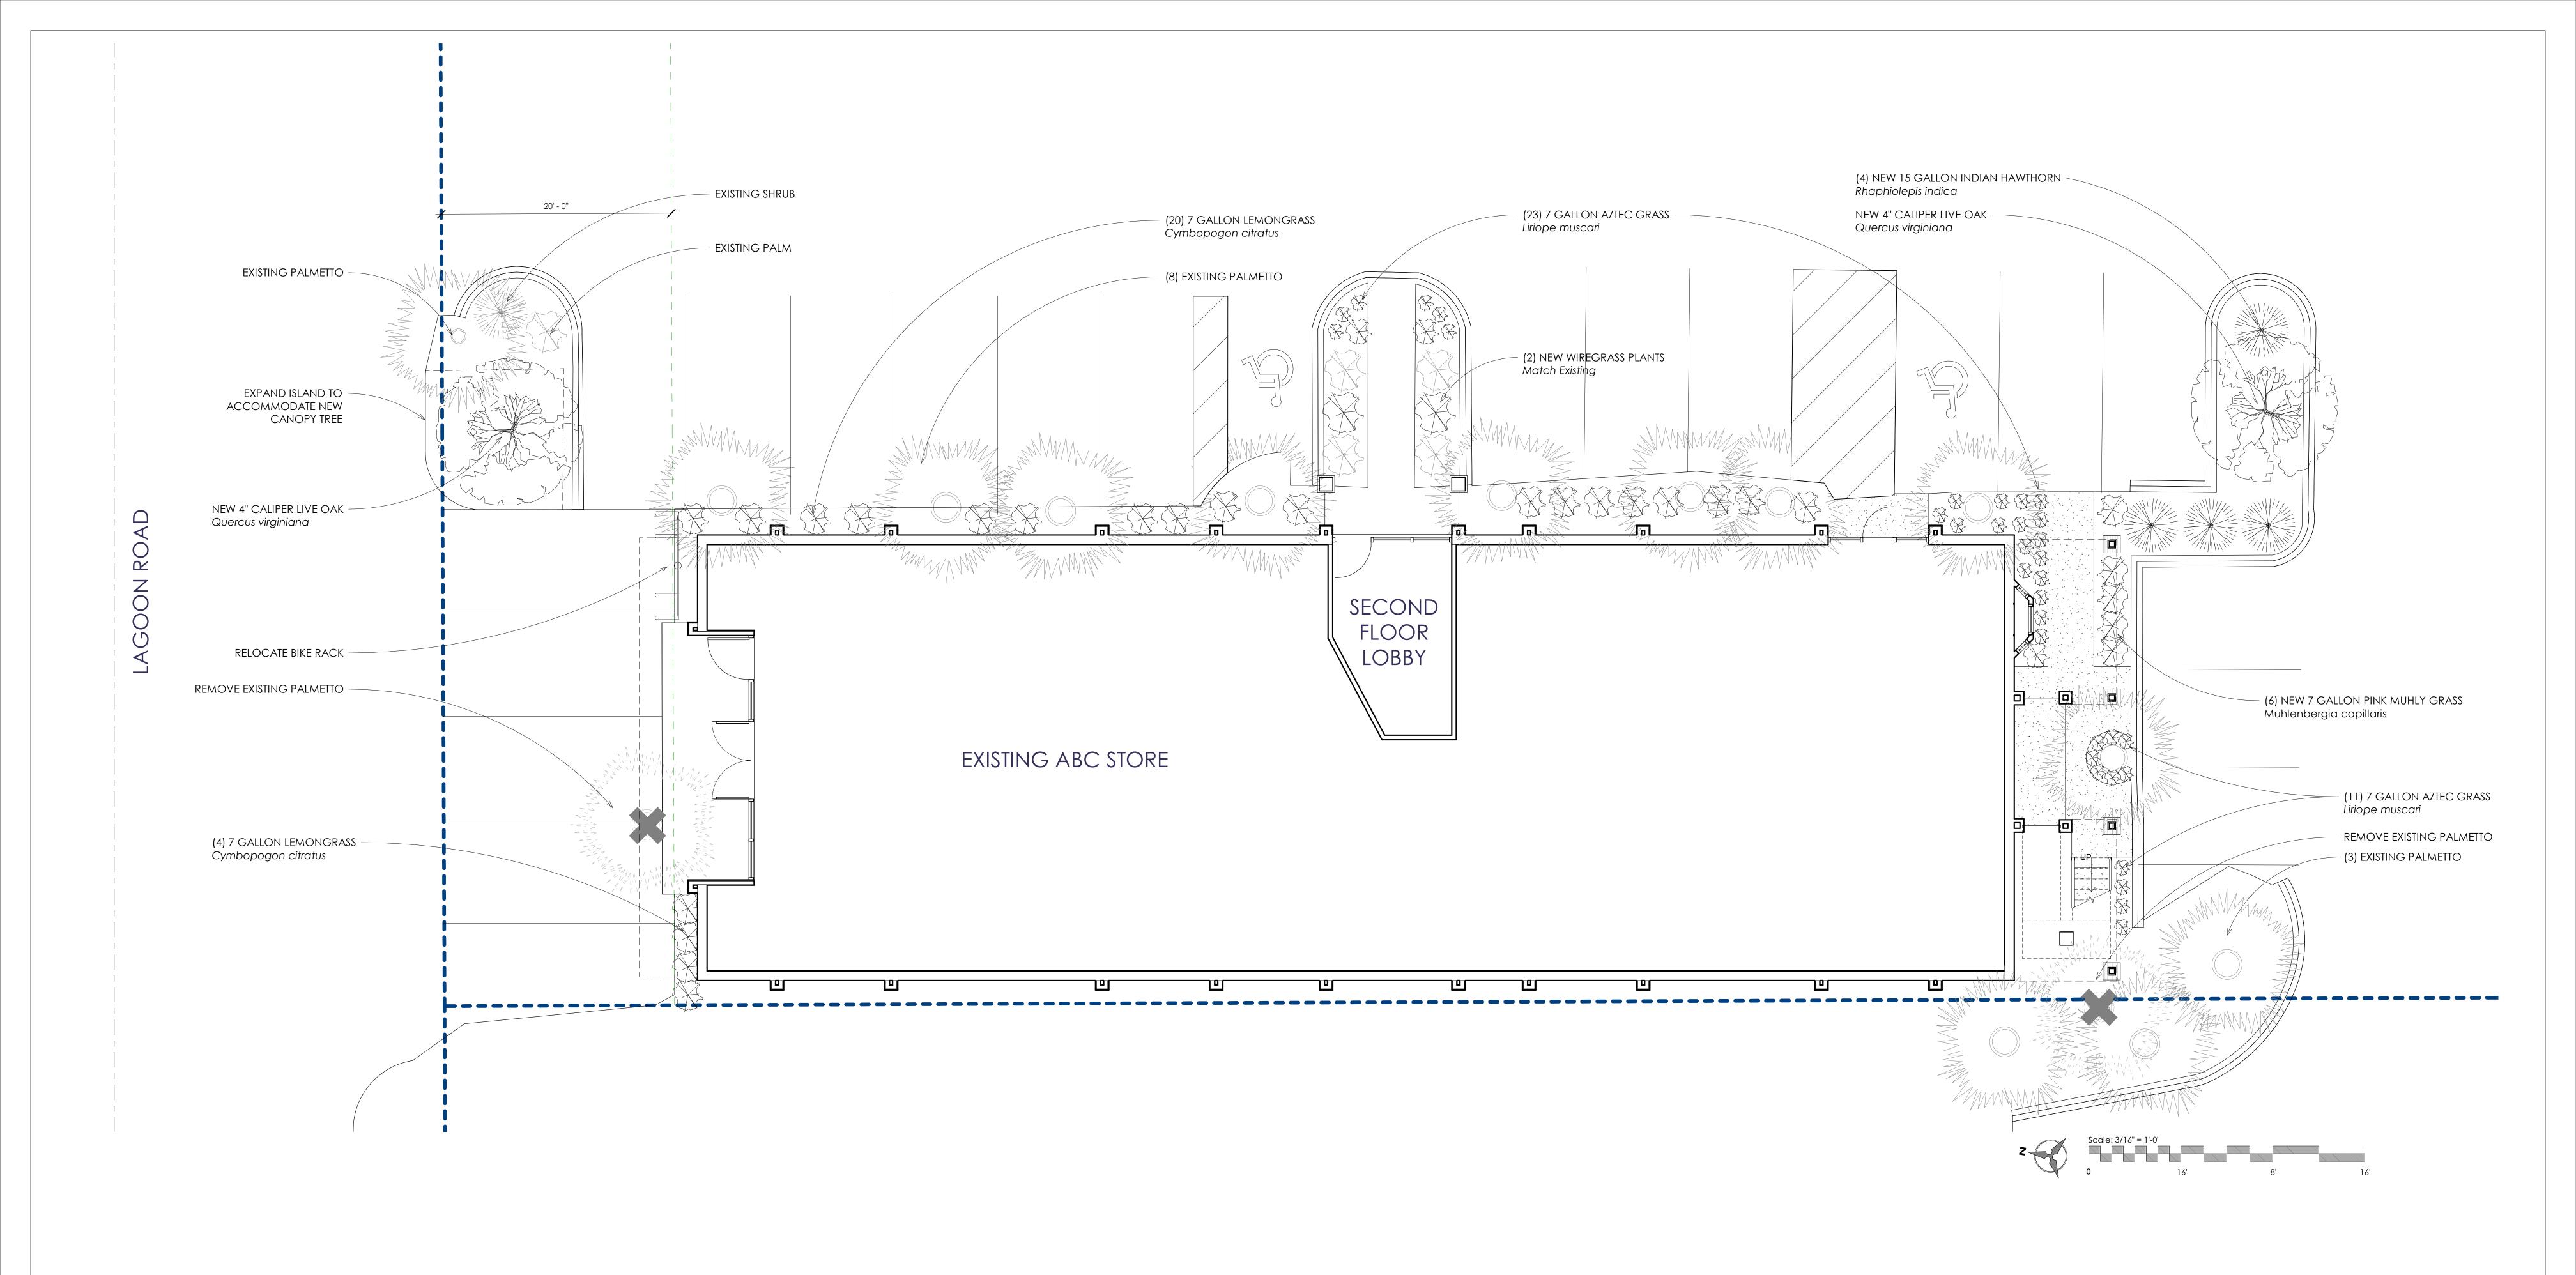



First Floor Plan

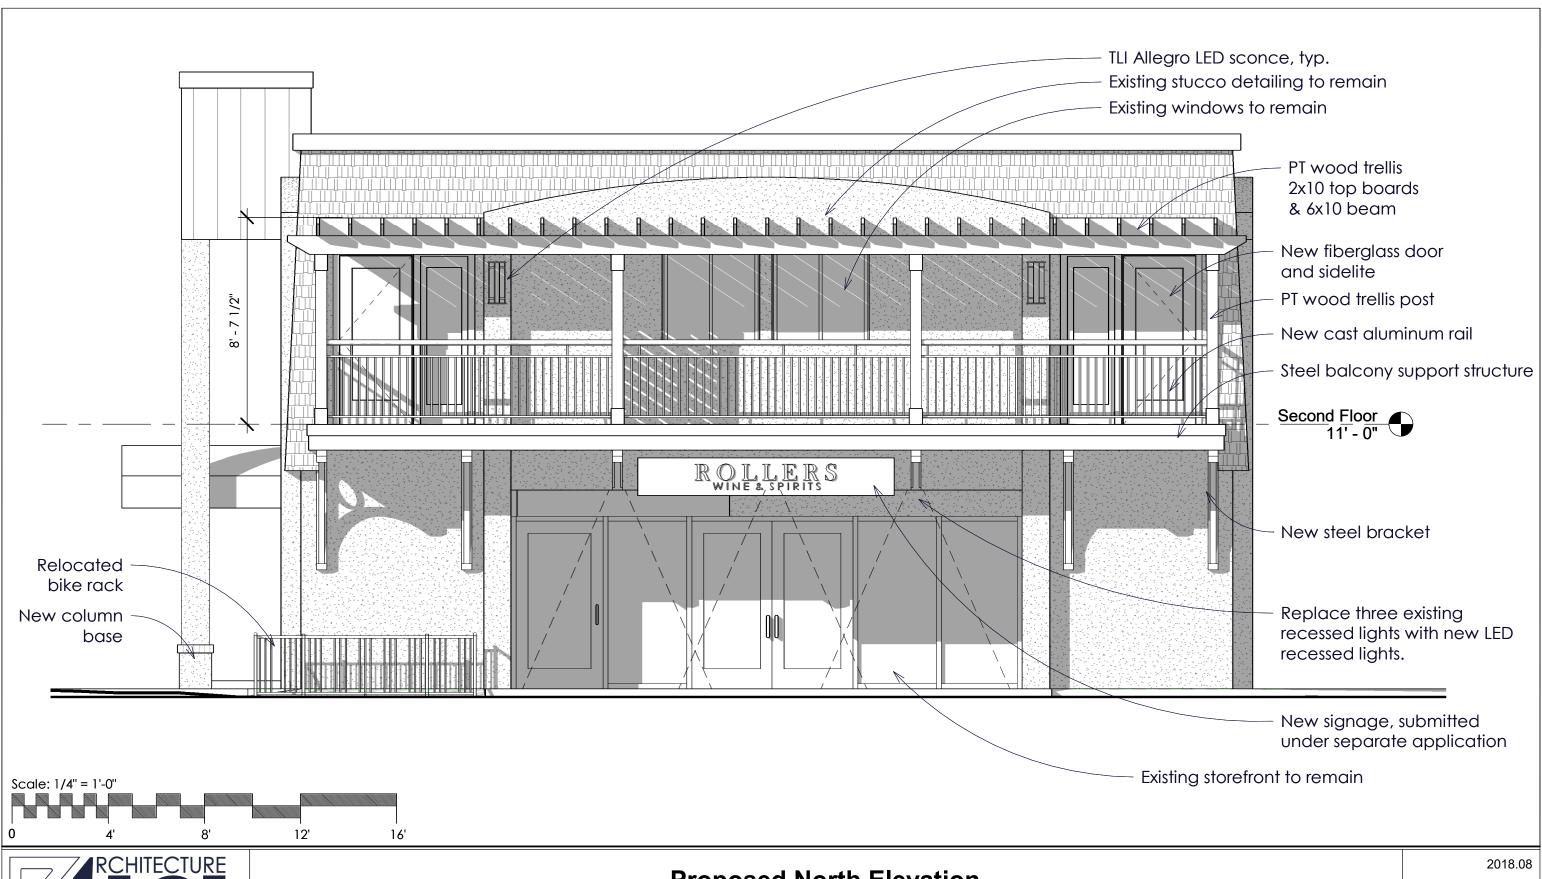




**Proposed North Elevation** 

August 20, 2018

EXTERIOR RENOVATIONS TO 6 LAGOON ROAD

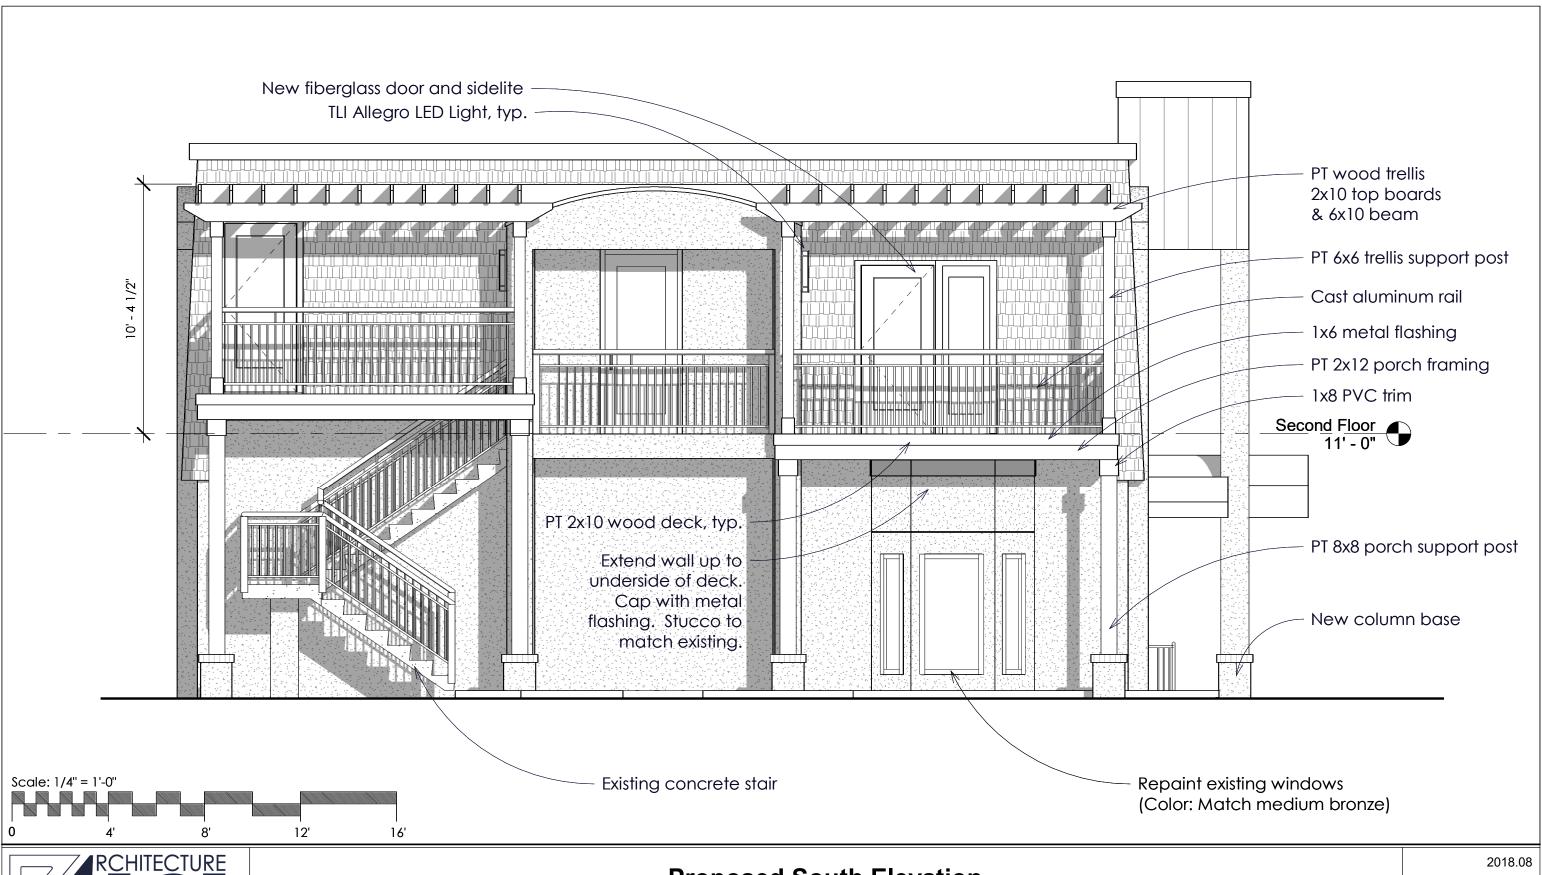




## **Proposed South Elevation**

August 20, 2018

EXTERIOR RENOVATIONS TO 6 LAGOON ROAD

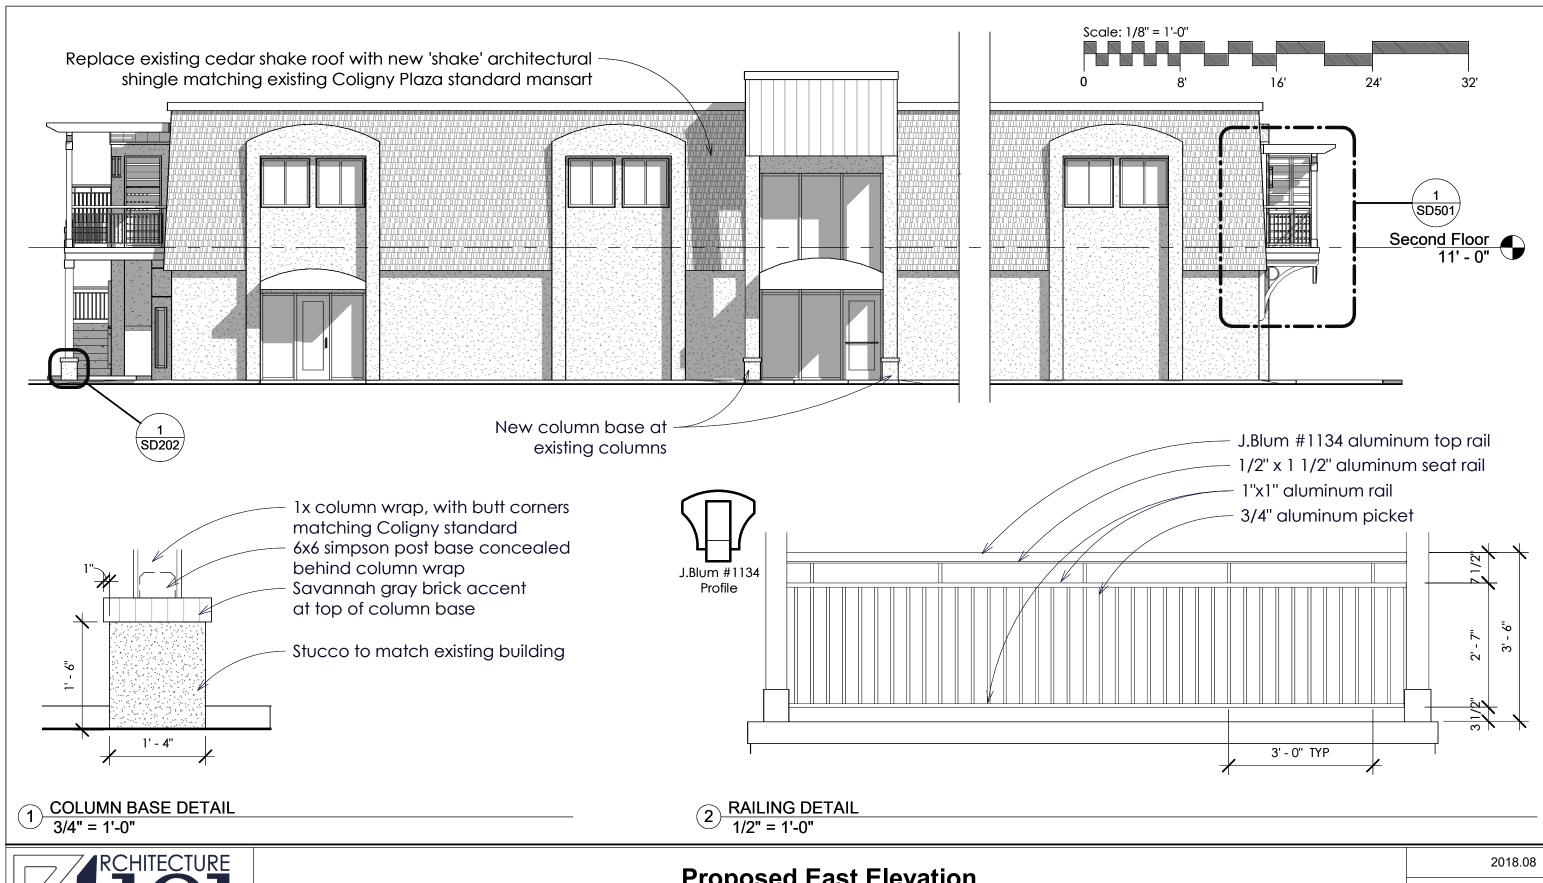




## **Proposed East Elevation**

August 20, 2018

RENOVATIONS TO 6 LAGOON ROAD

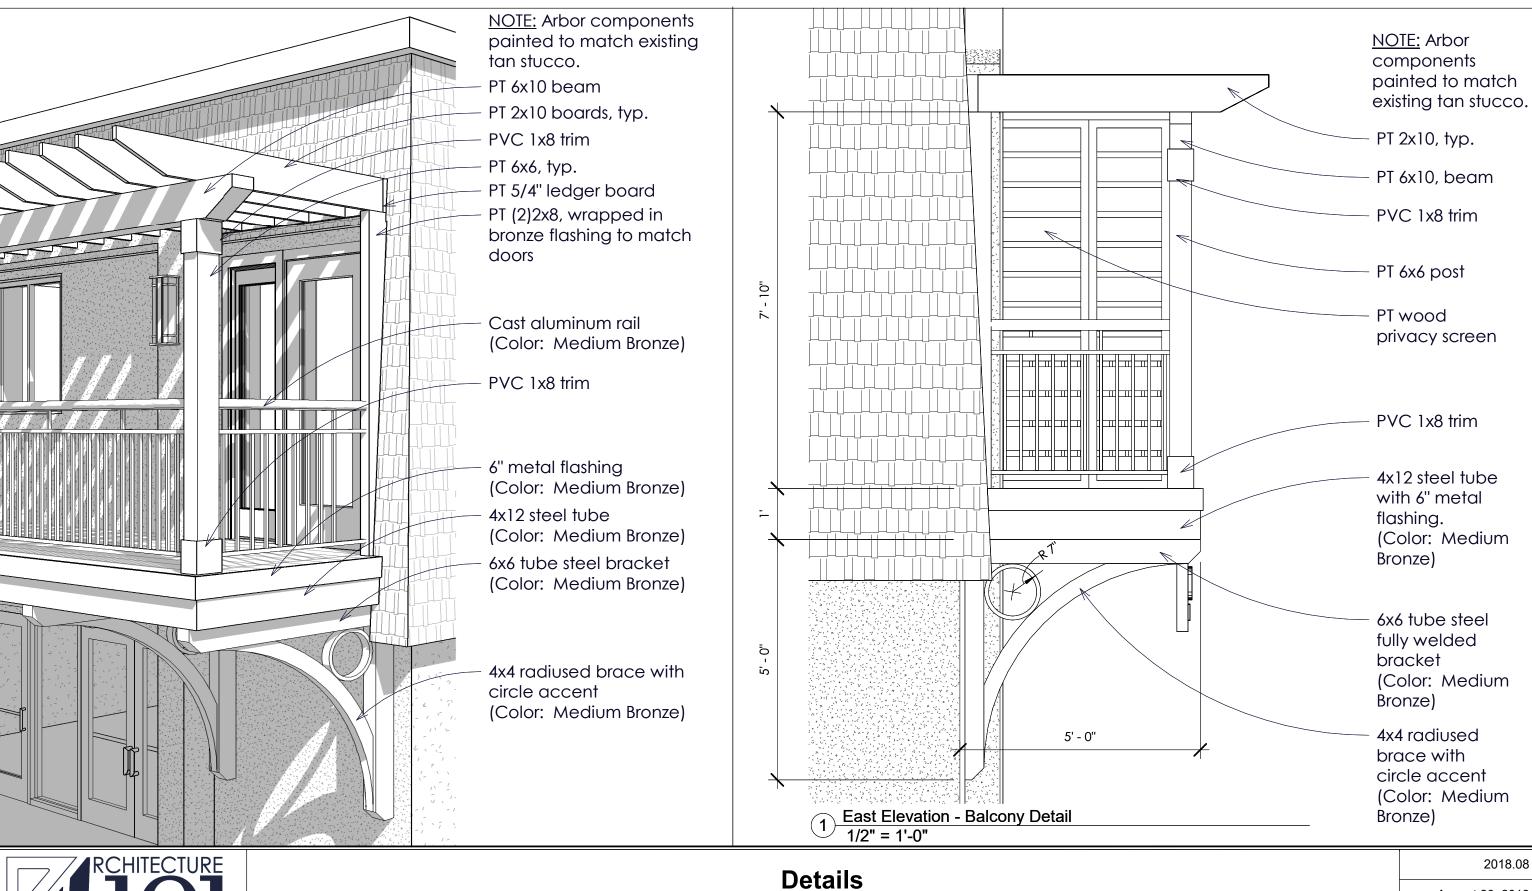



August 20, 2018

RENOVATIONS TO 6 LAGOON ROAD





**Proposed Lagoon Road View (Northeast)** 

2018.08

August 20, 2018

RENOVATIONS TO 6 LAGOON ROAD

A701





**Proposed Coligny View (Southeast)** 

August 20, 2018

RENOVATIONS TO 6 LAGOON ROAD

A702

### **DESIGN TEAM/DRB COMMENT SHEET**

The comments below are staff recommendations to the Design Review Board (DRB) and do NOT constitute DRB approval or denial.

PROJECT NAME: 6 Lagoon	DRB#: DRB-001931-2018			
DATE: 08/16/2018				
RECOMMENDATION: Approval Approval with Conditions Denial RECOMMENDED CONDITIONS:  1. Specify color to improvements on South Elevation (Coligny Plaza side). Submit for staff review and approval.				
ARCHITECTURAL DESIGN				
DESIGN GUIDE/LMO CRITERIA	Complies Yes	No	Not Applicable	Comments or Conditions
Utilizes natural materials and colors		$\boxtimes$		Specify the color of all new additions to the building.
Has a strong roof form with enough variety to provide visual interest				Revise the bay window roof to better coordinate with the new architectural detail additions. Done.
LANDSCAPE DESIGN				
DESIGN GUIDE/LMO CRITERIA	Complies Yes	No	Not Applicable	Comments or Conditions
Provides Landscaping of a scope and size that is in proportion to the scale of the development				Provide a landscape Plan. Done.
NATURAL RESOURCE PROTECTION				
DESIGN GUIDE/LMO CRITERIA	Complies Yes	No	Not Applicable	Comments or Conditions
Supplemental and replacement trees meet LMO requirements for size, species and number				Provide a Landscape Plan that includes a Live Oak at Lagoon and the back of the building. Done.

#### MISC COMMENTS/QUESTIONS

- 1. Show 20' street setback off Lagoon per LMO 16-3-105.B.3 (Balcony may occupy the Street Setback) Added.
- 2. The project requires a Minor DPR.
- 3. Provide a Landscape Plan. Done.
- 4. Revise the site plan to show, at a minimum the middle of Lagoon Road. Done.
- 5. The privacy screen seems out of place on the Coligny Plaza elevation. Revised.
- 6. Remove asphalt to reconfigure and clarify the landscape island at Lagoon. Planting should include a Live Oak. Done.
  - 7. Remove the sidewalk in the island on the Coligny Plaza end of the building. Planting should include a Live Oak. Done.
  - 8. Staff does not support changing the wood shingles to asphalt shingles. Consider another material to replace the wood shingles. In reconsideration of the context, given the prevalence of green asphalt shingles at Coligny, Staff supports approval of the shingles currently on the building.

# Article III Board Organization and Duties

#### Section 1. Membership.

- 1. **Number and Qualifications.** The Board shall consist of seven members appointed by the Town Council. To the extent practicable, the appointed members shall include at least one attorney and at least two but not more than three design professionals (such as a registered architect, a landscape architect or a graphic artist). None of the members shall hold an elected public office or position with the Town of Hilton Head Island or Beaufort County, South Carolina, and no former Board member shall be appointed to the Board without having been absent from the Board for a period of at least one year.
- 2. **Length of Terms.** Members of the Board shall be appointed annually for three-year terms effective each July 1, with all such terms ending on June 30 of the applicable year, unless a member is appointed to fill a vacancy. Vacancies shall be filled by the Town Council by appointments for the balance of any unexpired terms.
- 3. **Term Limits.** No member may serve more than two successive terms, except at the pleasure of the Town Council when the Council believes that such continuation of service is in the best interest of the Community and is for a specific purpose. Service to fill an unexpired term of less than one and one-half years shall not constitute a term of service for the purpose of these term limits.
- 4. **Attendance/Absences.** Board members are expected to attend all Board meetings. Each member of the board who has prior knowledge that they will not be able to attend a scheduled Regular Meeting of the board shall notify the Secretary no later than 4:30 P.M. 10 A.M. the business day before the meeting. In the case of an emergency, a member shall give the earliest possible notification. The Secretary or Staff shall notify the Chairperson in the event that the projected absence(s) will produce a lack of a quorum.
- 5. **Removal.** Three (3) unexcused absences at Regular or Special Meetings of the Board during one calendar year shall be cause for recommendation by the Chairperson to the Town Council to reconsider the appointment of that member. Attendance records shall be reviewed annually by the Chairperson.