

#### Town of Hilton Head Island

### Design Review Board Meeting Tuesday August 22, 2023 – 2:30 p.m.

#### **A**GENDA

The Design Review Board meeting will be held in person at Town Hall in the Benjamin M. Racusin Council Chambers.

- 1. Call to Order
- 2. FOIA Compliance Public notification of this meeting has been published, posted, and distributed in compliance with the South Carolina Freedom of Information Act and the requirements of the Town of Hilton Head Island.
- 3. Roll Call
- 4. Approval of Agenda
- 5. Approval of Minutes
  - a. Meeting of June 13, 2023, Regular Meeting
  - **b.** Meeting of August 8, 2023, Regular Meeting

#### 6. Appearance by Citizens

Citizens may submit written comments via the <u>Town's Open Town Hall Portal</u>. The portal will close at 4:30 p.m., the day before the meeting. Comments submitted through the portal will be provided to the Design Review Board and made part of the official record.

#### 7. Unfinished Business

None

#### 8. New Business

- a. Sign DRB-001566-2023 New entrance sign at 15 Wimbledon
- b. Alteration/Addition DRB-001566-2023 New fountain structure and internal sign at 15 Wimbledon
- c. New Development Final DRB-001563-2023 Final review for both Phase 1 and Phase 2 at 1 South Forest Beach

#### 9. Board Business

a. Election of Officers for Term July 1, 2023 – June 30, 2024

#### 10. Staff Report

a. Minor Corridor Report

#### 11. Adjournment

Please note that a quorum of the Town Council may result if four (4) or more of their members attend this meeting.



#### Town of Hilton Head Island

#### **Design Review Board Meeting**

June 13, 2023, at 2:30 p.m.

#### **MEETING MINUTES**

Present from the Board: Cathy Foss, Chair; Annette Lippert; John Moleski; Ryan Bassett;

Todd Theodore; Tom Parker

Absent from the Commission: Judd Carstens

Present from Town Council: David Ames

**Present from Town Staff:** Brian Eber, *Development Services Manager*; Alexis Cook, *Principal Planner*; Shea Farrar, *Senior Planner*; Michael Connolly, *Senior Planner*; Karen

Knox, Board Secretary; Brian Glover, Administrative Assistant

#### 1. Call to Order

Chair Foss called the meeting to order at 2:30 p.m.

#### 2. FOIA Compliance

Public notification of this meeting has been published, posted, and distributed in compliance with the South Carolina Freedom of Information Act and the requirements of the Town of Hilton Head Island.

#### 3. Roll Call

As noted above.

#### 4. Approval of Agenda

Chair Foss asked if the staff had any changes to the agenda. Ms. Lippert moved to approve the Agenda. Mr. Parker seconded. By a show of hands, the Motion passed with a vote of 6-0-0.

#### 5. Approval of Minutes

a) Regular Meeting of May 10, 2023

Chair Foss asked for a Motion to approve the Minutes of May 10, 2023. Mr. Theodore moved to approve. Mr. Moleski seconded. By a show of hands, the Motion passed with a vote of 6-0-0.

#### 6. Appearance by Citizens

Public comments concerning agenda items were to be submitted electronically via the Open Town Hall HHI portal. No comments were received on the Open Town Hall Portal. No citizens spoke at the meeting.

#### 7. Unfinished Business

#### a) Sign – DRB-000917-2023 – Modifications to an existing Walmart sign.

Ms. Farrar provided the staff's presentation as included in the packet. The applicant provided an additional presentation. The board asked several questions about the colors, their specific numbers, the flex-based color, the foam core material, and the requirements to conform to sign size regulations, and addressing requirements.

The Board had a short discussion about the project.

Ms. Lippert moved to approve with the following conditions:

- Background color to be the medium grey.
- Existing sign background to be light grey.
- The off-white for the lettering.
- The darker yellow for the spark.
- The material of the signage should be matching an HDU.
- Plans to include a landscaping plan.
- Permitting will determine if an address needs to be added to the monument sign.

Mr. Parker seconded the motion. The motion was carried with a vote of 6-0.

## b) Alteration/Addition – DRB-000920-2023 – External color changes to Walmart Building.

Ms. Farrar provided the staff's presentation as included in the packet. The applicant provided an additional presentation. The board asked several questions, including questions about the new doorway, the colors matching the sign color, and the existing shingles.

Ms. Lippert moved to approve with the following conditions:

- Everything that is listed as Walmart blue will be revised to P135E medium grey.
- Yellow spark will be the darker yellow.
- The lettering will be off-white.
- PMS colors will be provided for all colors.

Mr. Parker seconded the motion. The motion carried with a vote of 6-0.

#### 8. New Business

None

#### 9. Board Business

The Board discussed two signs and if the signs followed the design guidelines.

The board held a discussion on the use of awnings, their definition in the LMO and design guidelines, and possible changes in the future.

#### 10. Staff Report

a) Minor Corridor Report

**11. Adjournment**The meeting adjourned at 3:40 p.m.

Submitted By: \_\_\_\_\_

**Brian Glover Administrative Assistant** 

Date:



#### Town of Hilton Head Island

#### **Design Review Board Meeting**

August 8, 2023, at 2:30 p.m.

#### **MEETING MINUTES**

Present from the Board: Judd Carstens, Vice-Chair; Annette Lippert; Todd Theodore; Tom

Parker; Ryan Bassett

Absent from the Commission: Cathy Foss and John Moleski

**Present from Town Staff:** Shawn Colin, *Assistant Town Manager*; Brian Eber, *Development Services Manager*, Alexis Cook, *Principal Planner*; Shea Farrar, *Principal Planner*; Michael

Connolly, Senior Planner; Karen Knox, Board Secretary

#### 1. Call to Order

Vice Chair Carstens called the meeting to order at 2:30 p.m.

#### 2. FOIA Compliance

Public notification of this meeting has been published, posted, and distributed in compliance with the South Carolina Freedom of Information Act and the requirements of the Town of Hilton Head Island.

**3. Swearing in Ceremony of Reappointed Board Members:** Judd Carstens, Annette Lippert, Todd Theodore

Shawn Colin, Assistant Town Manager, reappointed Board Members Judd Carstens, Annette Lippert and Todd Theodore and thanked them for their service to the Board and the Community.

#### 4. Roll Call

As Noted Above.

#### 5. Approval of Agenda

Vice Chair Carstens asked if Staff had any changes to the Agenda. Ms. Cook said there were no changes. Vice Chair Carstens asked the Board for a Motion to reverse the order of presentation for the items under New Business so that DRB 001482-2023 New Overlook at Driessen Beach Park is reviewed first, followed by DRB-001497-2023 New Pavilion at 1 South Forest Beach (Beach House.) Ms. Lippert moved to approve. Mr. Bassett seconded. The Motion passed with a vote of 5-0.

Vice Chair Carstens also asked for a Motion to move the Election of Officers for the Term July 1, 2023 to June 30, 2024 to the next meeting so that Chair Foss will be able to participate. Mr. Theodore moved to approve. Mr. Parker seconded. The Motion passed with a vote of 5-0.

#### 6. Approval of Minutes

a) Regular Meeting of June 13, 2023

The meeting Minutes of June 13, 2003 will be presented for approval at the next meeting.

#### 7. Appearance by Citizens

Public comments concerning agenda items were to be submitted electronically via the Open Town Hall HHI portal. No comments were received on the Open Town Hall Portal. No citizens spoke at the meeting.

#### 8. Unfinished Business - None

#### 9. New Business

a) Alteration/Addition - DRB-001482-2023 - New Overlook at Driessen Beach Park

Ms. Cook provided staff's presentation as included in the packet. The staff recommended approval with no conditions as submitted. This is the concept approval which is the initial review. You will see this again at final approval for this design. Following staff's presentation, the Applicant gave a brief overview and answered questions from the Board.

Mr. Parker moved to approve as submitted. Mr. Theodore seconded. The Motion passed with a vote of 5-0.

# b) Alteration/Addition - DRB-001497-2023 - New Pavilion at 1 South Forest Beach (Beach House)

Ms. Cook provided the staff's presentation as included in the packet and provided background on previous reviews and approvals. In 2022, the 1<sup>st</sup> Phase of this Project had preliminary courtesy reviews. There were three reviews done by the Board – April, 2022, June, 2022 and November 2022. The Phase 1 review was completed on December 16, 2022. It had three conditions. Two of which were: get a Building Permit and the other was to apply for a Major DPR. The Major DPR has been applied for. The third was to apply for a Second Phase which is what you are seeing today and to request a Variance for the locations with the OCRM line. They went for the Variance in June, 2023 and it was approved on June 14, 2023 by the Board of Zoning Appeals. Ms. Cook also mentioned that there are 3-4 slides that were not included in the Packet and wanted to give the Board the option of just reviewing what was submitted. Vice-Chair Carstens said they could review it at this meeting and just call out the additional slides.

The Applicant was then asked by Ms. Cook to present their slide package to the Board. The Architect, Gregory Villegas, with WATG and Lance Kalani, the Landscape Architect for the project provided background on the project stating that they used Celebration Park as their inspiration for the project. They began their

presentation by reviewing the site plan with the proposed minor modifications as well as the Phase 2 review for the pavilion submission. The minor modifications included the relocation of the shower, the connection of the kitchen facility to the restroom which was required as part of the flood mitigation for the project. Some visuals that were not included in the packet were the addition of Tiki Hut visuals, as well as a bathroom entrance staircase visual. It was also explained that the fences are planned to be updated but the look will be updated to match the overall architectural theme. It was also mentioned that some components of the conceptual approval for Phase 1 had been modified. That included the removal of a trellis and the introduction of a portal covered access at the parking lot to improve cover from the parking lot into the hotel. Greg explained the staircase to the restrooms was also improved and included on the plan set submitted to the Development Plan group. Lance provided a summary of materials that are to be used around the pool, and that included pervious pavers, some wood decking around the Tiki and Event Pavilions, brick was later considered as a lighter color material. Greg then discussed the architecture of the concrete base columns will be consistent throughout the Tiki and the Event Pavilion. He also summarized the shingles, the pavilion wood staining, the fencing, the decking to further elaborate on materials.

At the conclusion of the presentation, Ms. Lippert mentioned that she would have a number of questions. Vice Chair thanked the applicants for the submittal and then moved to Ms. Lippert to provide feedback and questions. She began her discussion by thanking the applicant and then began to discuss how the application appeared incomplete and had too many inconsistencies to provide a vote.

Ms. Lippert's Comments were the following:

- The light fixtures on A3.02 need to be referenced on the plan set and the color appears to be black. Black is not a color approved by the DRB and should be resubmitted as a different color.
- A number of trim was called out to be white, and white is color not approved by the DRB and should be resubmitted.
- Section A Detail 3 on A3.04 needs more detail and clarity on the purpose of the dashed line.
- She would like to see Tabby Stucco on the base column as the proposed concrete provides too industrial of a look.
- The restroom structure that was discussed during the conceptual Phase 1 review overhang has not been updated.
- More overall clarity on materials used and call outs to clarify.
- Removal of "Painted wood" note on A3.04

Vice Chair then thanked Annette for her comments and asked Mr. Parker if he had any comments, his summary was the following:

- Stainless steel on A3.04 is not the most aesthetically pleasing material, and the knife plate at Celebration Park may be better option on the column.
- Break up the louvre on the pavilion to better match Lowcountry style.

 Agreement with previous comments to recommend tabby material at the column base, to increase the overhang of all buildings, and to not include white trim.

Vice Chair then thanked Mr. Parker for his comments and asked Mr. Theodore if had any comments, his summary was the following:

- Requested full landscape plan with quantities.
- Concerns with palm lighting and the overall height and quantity of lights.
- The updated fence material needs callouts for the what types of materials, what standard details are needed, etc.

Vice Chair then thanked Mr. Theodore for his comments and asked Mr. Bassett if had any comments, his summary was the following:

- Mr. Bassett agreed with previous comments regarding no white trim, updating the material on the column base to a tabby or shell material.
- Requested a call-out or response on the plan to how the drainage from the roof will be handled, if gutters will be used or if the drainage will flow from the roof to the pavers. If the latter, to consider if the drip line may have impact on the paver or materials below.

Vice Chair then thanked Mr. Bassett for his comments and asked Ms. Cook if the Board would see the Applicants again for the Beach House, or if this was the final review. Ms. Cook then discussed that there are three options that the Board could continue with if they so choose. Vice Chair elaborated that the packet did not feel complete and that it felt like there were missing details in the package. Ms. Cook began to explain that there was a miscommunication with the applicant. There was previously a Notice of Action submitted to the applicant that was only for the conceptual review, which let the Applicant to believe that the Phase 1 submittal was approved from the Board. Based on this miscommunication, the Vice Chair and Ms. Cook concluded that both Phase 1 and Phase 2 would need to come back for one final approval so that comments could be addressed for both Phases.

Vice Chair then provided his comments as follows:

- Request a full landscape plan.
- Improvements to the Northern access public boundary were discussed in Phase 1 and still needs improvements.
- Agreed with previous comments that the concrete would be better with textured tabby or shell.
- String lights need to be clarified on the plan, as they are included in the visuals.
- Details need to be provided for the changes to the fences, gates and steps.
- Provide callouts if fans are to be provided in the pavilion. Ensure that conduits are concealed.
- Cabanas need a cut need.

After the Vice Chair concluded his comments, Mr. Theodore asked the clarifying question if the applicant still needs to come for final on the Phase 1 application. Vice Chair agreed with the question. It was agreed upon by the Board that the Final review would still be needed by the applicant for the entire project including both phases. The Applicant asked if they could discuss the next steps in the hallway. After the lengthy discussion, Ms. Cook advised the Board that the Applicant will withdraw today and reapply today to meet the deadline to be on the August 22, 2023 Meeting Agenda. The entire package (Phase 1 and Phase 2) will be reviewed and considered as the Final Review for both Phase 1 and Phase 2. Vice Chair Carstens asked the Applicant to formally withdraw for the record. The Applicant withdrew.

#### 10. Board Business

#### 11. Staff Report

a) Minor Corridor Report
 Alexis Cook provided the Minor Corridor Report to the Board.

#### 12. Adjournment

The meeting adjourned at 4:14 p.m.

Submitted By:	
	Karen Knox Board Secretary
Date:	



#### Town of Hilton Head Island

Community Development Department One Town Center Court

Hilton Head Island, SC 29928 Phone: 843-341-4757 Fax: 843-842-8908

www.hiltonheadislandsc.gov

FOR OFFICIAL US	E ONLY
Date Received:	
Accepted by:	
DRB #:	
Meeting Date:	

Applicant/Agent Name: Owner - HH Island Acquisition Agent - Brett Callaghan	Partners, LLC Company: HH Island Acquisition Partners, LLC
Mailing Address: 9654 North Kings Hwy, Unit 101	City: Myrtle Beach State: SC Zip: 29572
Telephone: 843-458-3348 Fax:	E-mail: bcallaghan@progressbuildersllc.com
Project Name: Madiencane Hilton Head Port Royal	Project Address: 77 Folly Field Road
Parcel Number [PIN]: R 5 1 0 0 0 9 0 0 0	
Zoning District: RD	Overlay District(s): CR
Name of the state	
CORRIDOR	REVIEW, MAJOR
DESIGN REVIEW BOARD (DE	RB) SUBMITTAL REQUIREMENTS
Digital Submissions may be accepted via e-mail by c	ealling 843-341-4757.
Project Category:	
Concept Approval – Proposed Development	X Alteration/Addition
Final Approval – Proposed Development	X Sign
Submittal Requirements for All projects:	
jurisdiction of an ARB, the applicant shall sub	otice of Action (if applicable): When a project is within the smit such ARB's written notice of action per LMO Section 16-to the ARB to meet this requirement is the responsibility of the
	opment \$175, Final Approval – Proposed Development \$175, or check made payable to the Town of Hilton Head Island.
tree protection regulations of Sec. 16-6-104.C. beaches.  A site analysis study to include specimen trees views, orientation and other site features that r.  A draft written narrative describing the design reflects the site analysis results.  Context photographs of neighboring uses and a Conceptual site plan (to scale) showing proposes.	intent of the project, its goals and objectives and how it architectural styles. sed location of new structures, parking areas and landscaping. tions showing architectural character of the proposed

review guidelines of Sec. 16-3-106.F.3.  Final site development plan meeting the require Final site lighting and landscaping plans meetin Final floor plans and elevation drawings (1/8"= colors with architectural sections and details to A color board (11"x17" maximum) containing a elevations, and indicating the manufacturer's na Any additional information requested by the De	ng the requirements of Appendix D: D-6.H and D-6.I.  1'-0" minimum scale) showing exterior building materials and adequately describe the project.  actual color samples of all exterior finishes, keyed to the
additional materials.  A survey (1"=30' minimum scale) of property li	of proposed development as listed above, plus the following ines, existing topography and the location of trees meeting the 2, and if applicable, location of bordering streets, marshes and
For freestanding signs:	
A representative for each agenda item is strongly encouraged  Are there recorded private covenants and/or rest	ate in order to be reviewed by the DRB per LMO Appendix D: D-23.  I to attend the meeting.  rictions that are contrary to, conflict with, or prohibit e covenants and/or restrictions must be submitted with
factual, and complete. I hereby agree to abide by all Head Island. I understand that such conditions shobligation transferable by sale.	this application and all additional documentation is true conditions of any approvals granted by the Town of Hiltonall apply to the subject property only and are a right of Emergency due to a Disaster, the review and approval times
set forth in the Land Management Ordinance may be  But Caug  SIGNATURE	60 m and Sandard Sandard Sandard and an

#### **Hilton Head Port Royal Resort**

Hilton Head Island, SC

#### **Final DRB Project Narrative**

August 8, 2023

On October 18, 2021, HH Island Acquisition Partners was approved with specific conditions for the redevelopment of the property formerly knows as The Port Royal Racquet Club Tract (parcel 4 – Wimbledon Court) along Folly Field Road into a signature destination resort in keeping with Hilton Head Island vernacular. No changes are being proposed to those approved plans.

The property is being named (as previously approved) and branded "The Maidencane", and as a result more detailed design has been proposed for the main entry including signage and a water feature directly in front of the clubhouse's porte-cochere in order to provide a strong sense of arrival for guests.

The main sign is being proposed within the median and is aligned with the fence and columns proposed along Folly Field Road. The sign is a two-post design with a simple trellis structure on top. The double-sided wood sign panel will hang from the trellis and will have dark bronze detailing and matching off-set lettering. Each 10x10 post will have a battered tabby base with brick cap. The low water feature directly behind the sign will have the same tabby finish and brick cap as the sign and feature stand-up bronze lettering to denote guests' arrival at The Maidencane. The design was inspired by Town of Hilton Head's Coligny Beach Park signage and features natural colors and materials.

Supplementary nightscape lighting has been added for maximum guest safety within the outdoor amenity area surrounding the pool/lazy river, so they can safely be utilized during less than favorable light conditions. These fixtures will match pervious approved fixture assemblies, 3,000k, pole and dark bronze color.


Updated splash pad location to allow for additional clear space away from existing live oaks and specific a program. All color finished to align with the island character.




HH ISLAND ACQUISITION PARTNERS, LLC

FIFTEEN WIMBLEDON - OVERALL CONTEXT MAP

SEPTEMBER 28, 2021

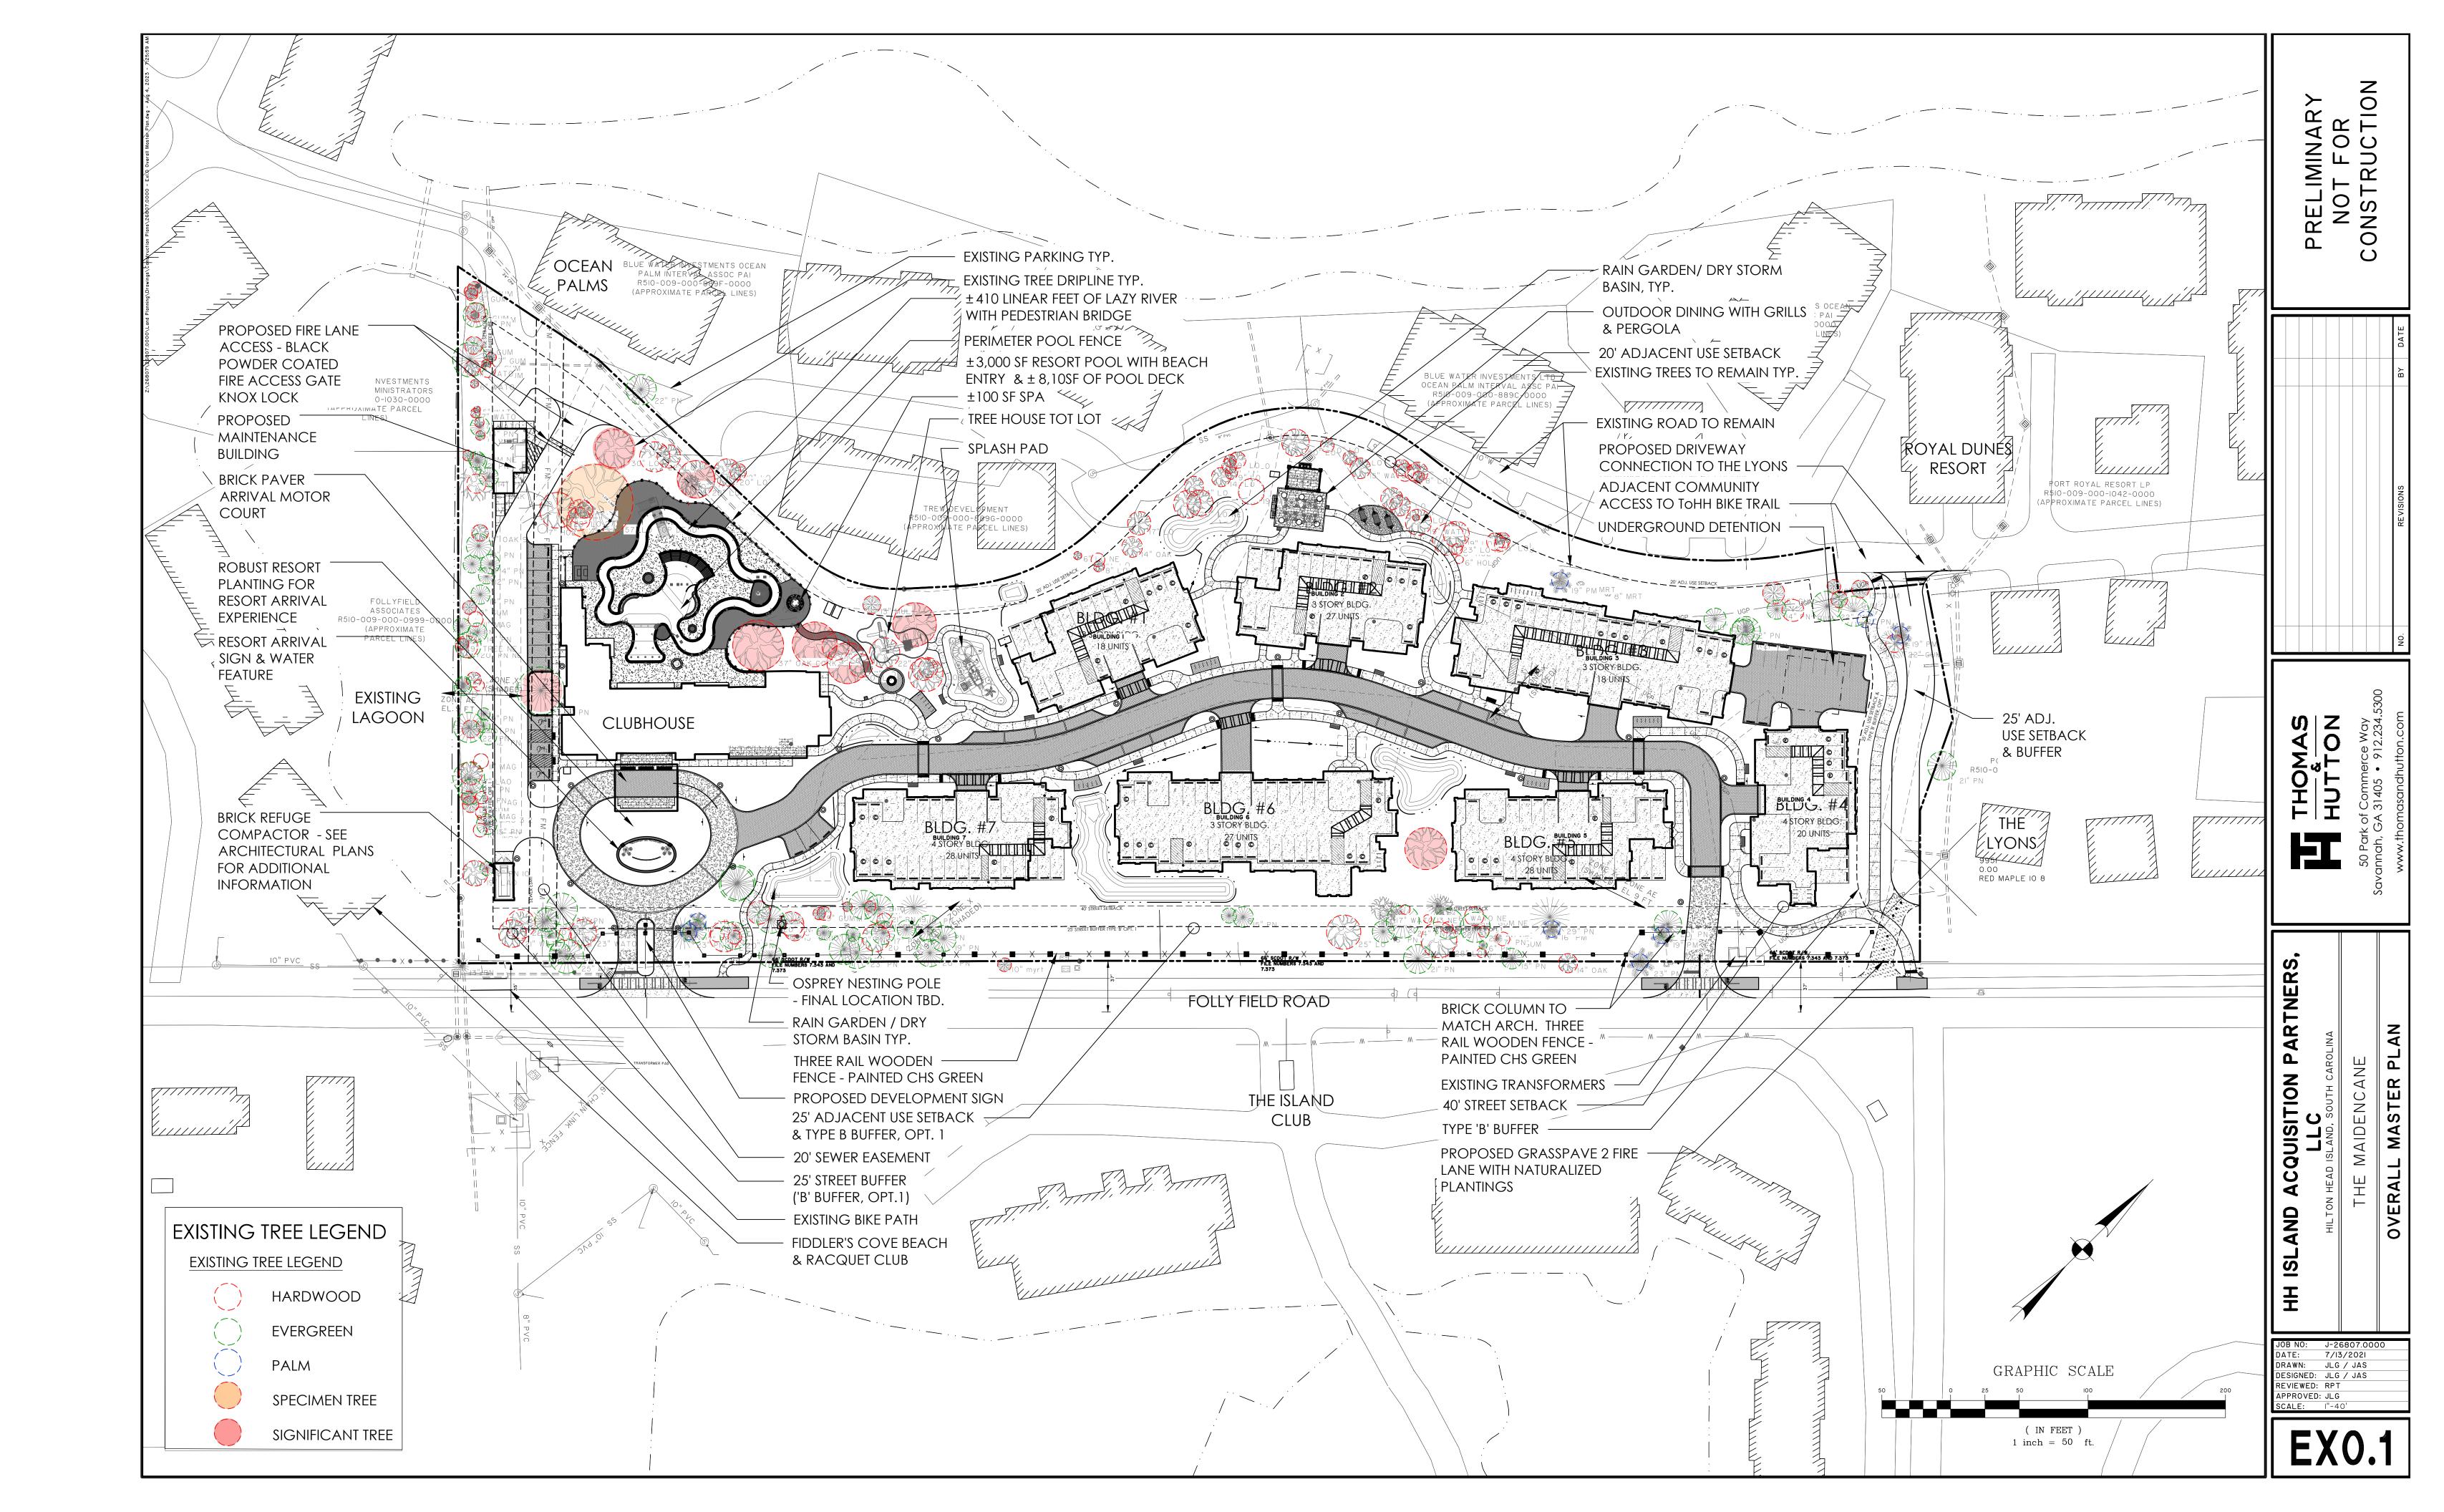


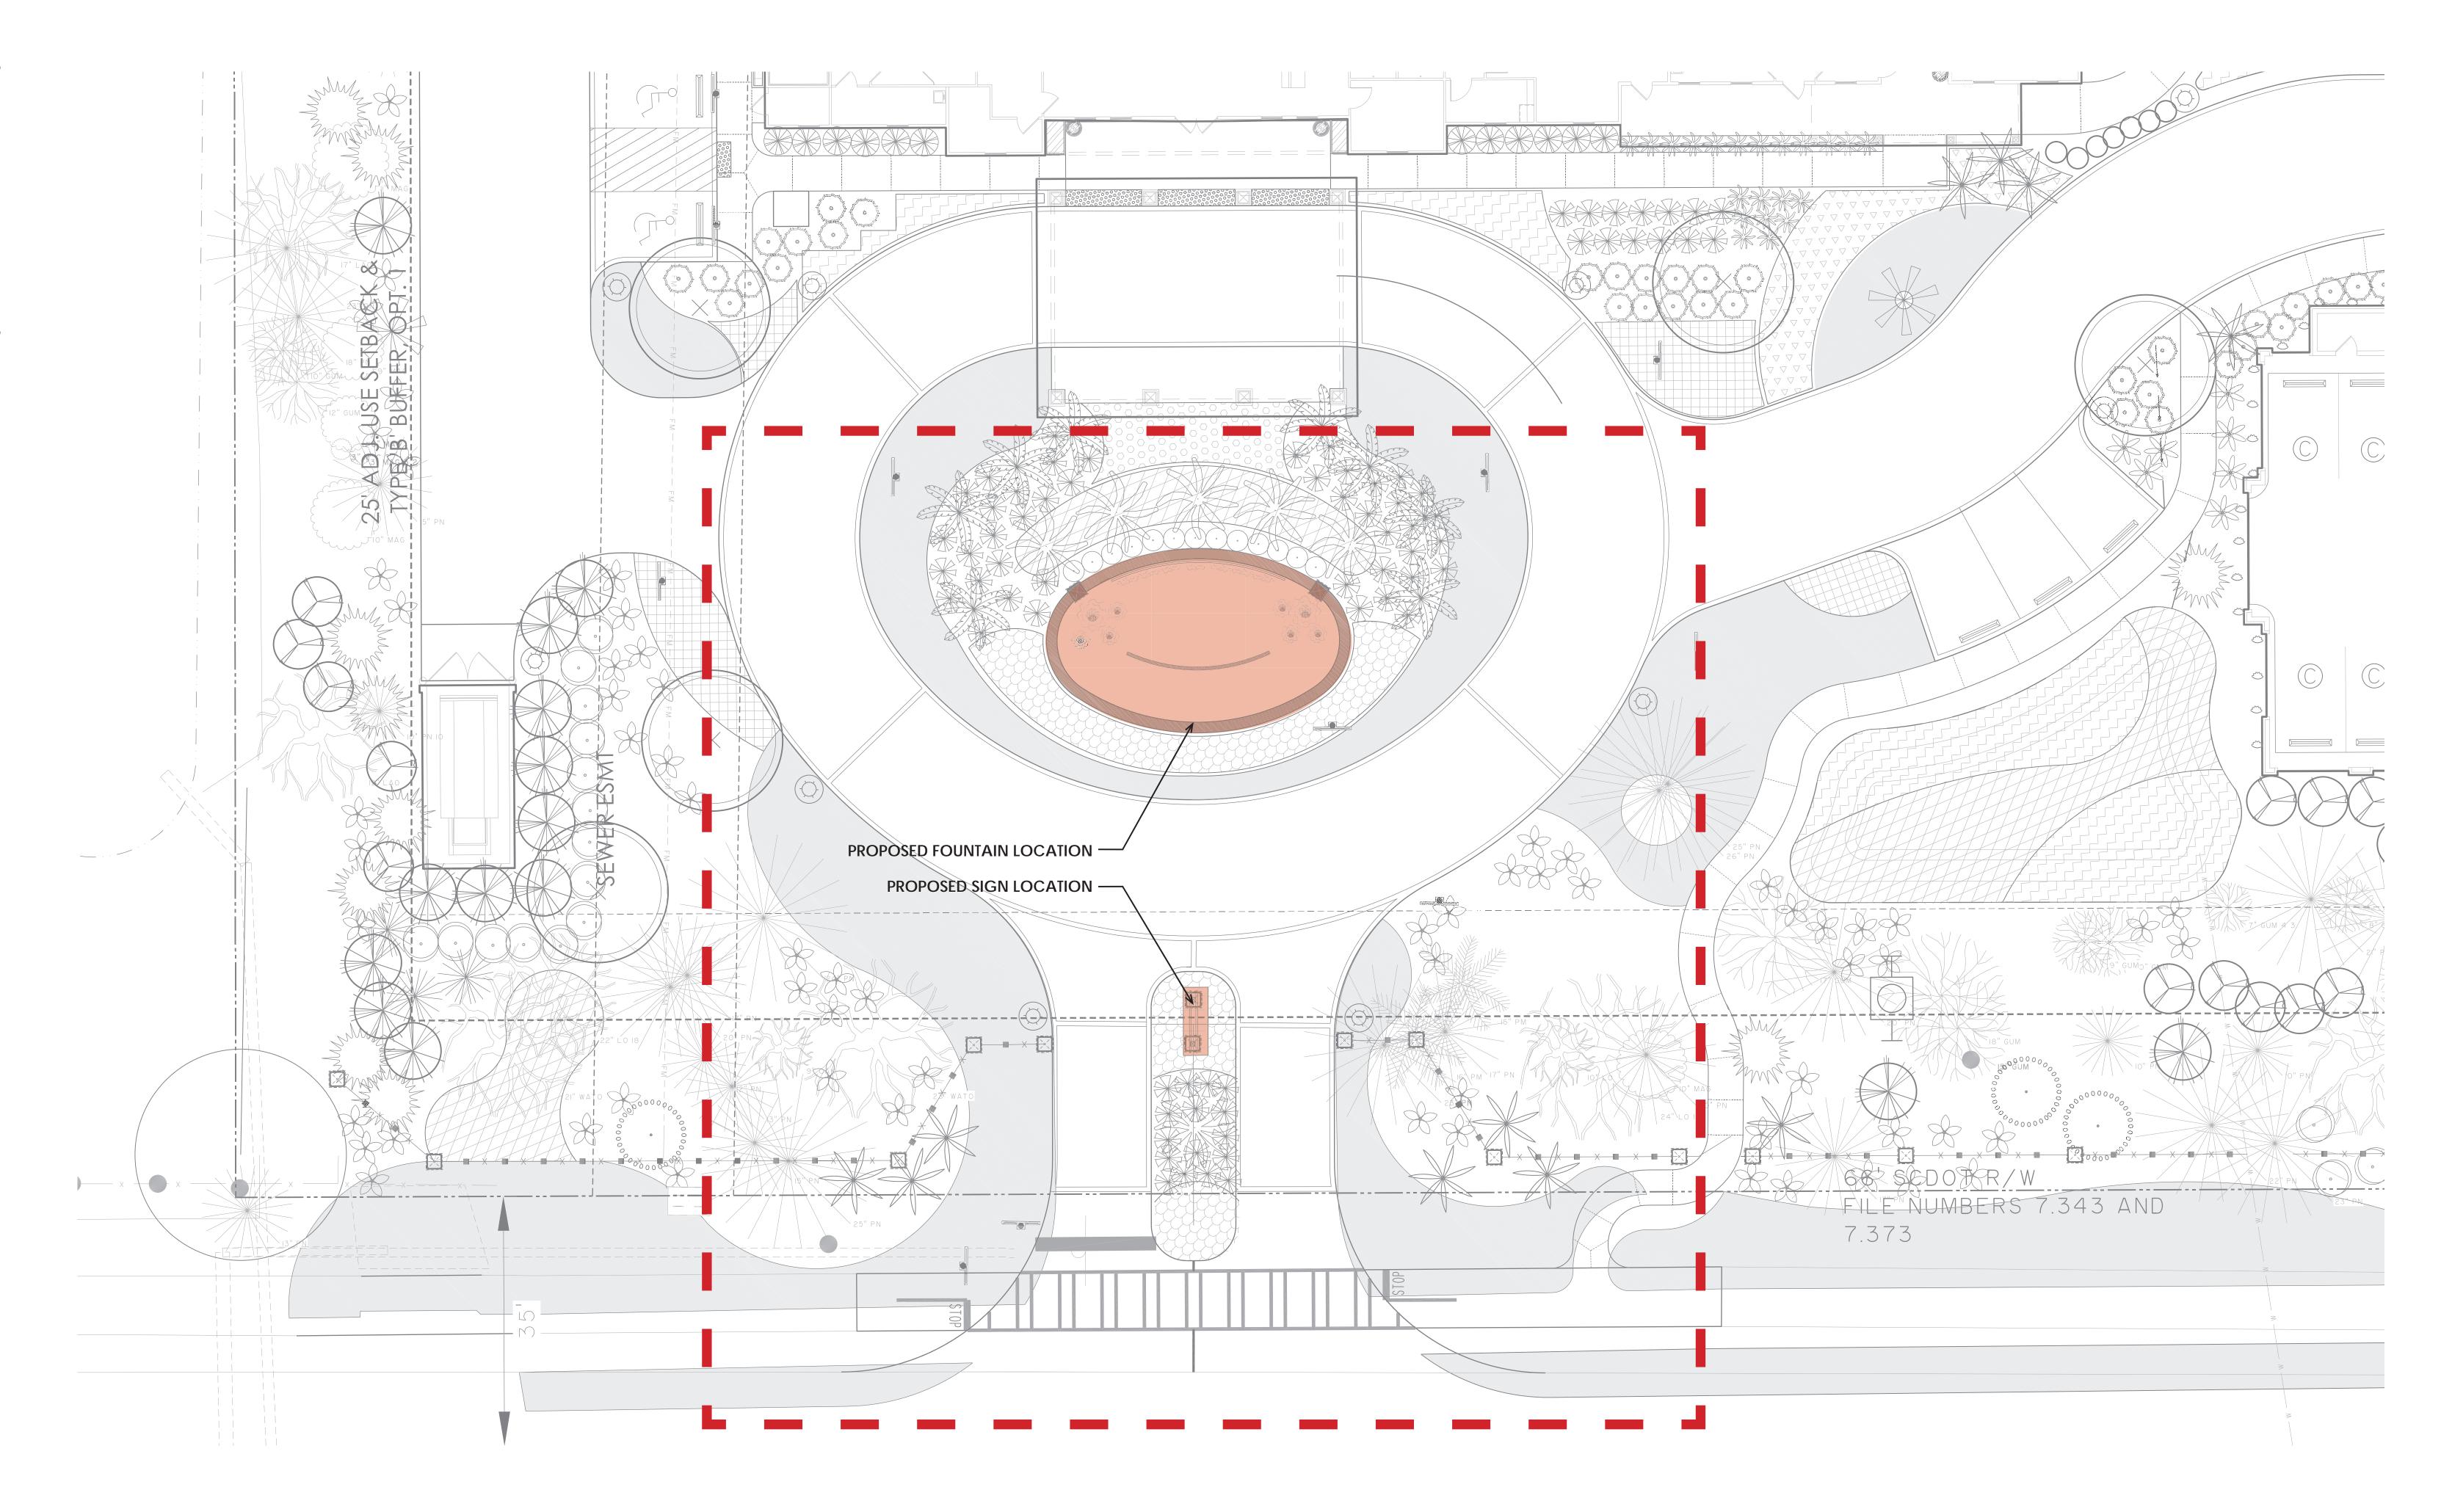

HH ISLAND ACQUISITION PARTNERS, LLC

THE MAIDENCANE - PROPOSED FOUNTAIN AND SIGN LOCATIONS

JUNE 26, 2023

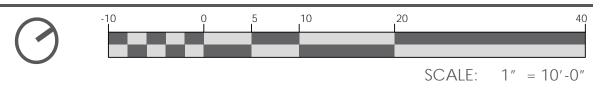





# LEGEND

- **A** ± 2 1/2' Brass / Bronze Sans Serif Lettering
- **B** ± 16" Low Fountain Wall with Brick Cap and Tabby Stucco Veneer
- **C** Brick Paver Motor Court
- D ± 36" Brick Column
- E ± 32" Fountain Wall with Brick Cap & Stucco
- F Concealed Water Wall Spillway
- G Cedar Arbor Slat to be Fastened to Each 3"x8" Joist
- H Cedar 3"x10" Beam Notched to Recieve Joist (Notch Not Exceed 2")
- ± 18' SF. Double Sided Sign Panel
- J 10x10" Cedar Post
- **K** Batter Tabby Column with Brick Cap
- L ± 1' Brass / Bronze Sans Serif Lettering to be Attached to Sign Panel

# MATERIALS

Cedar Wood




Tabby Stucco





Brick



Brass / Bronze

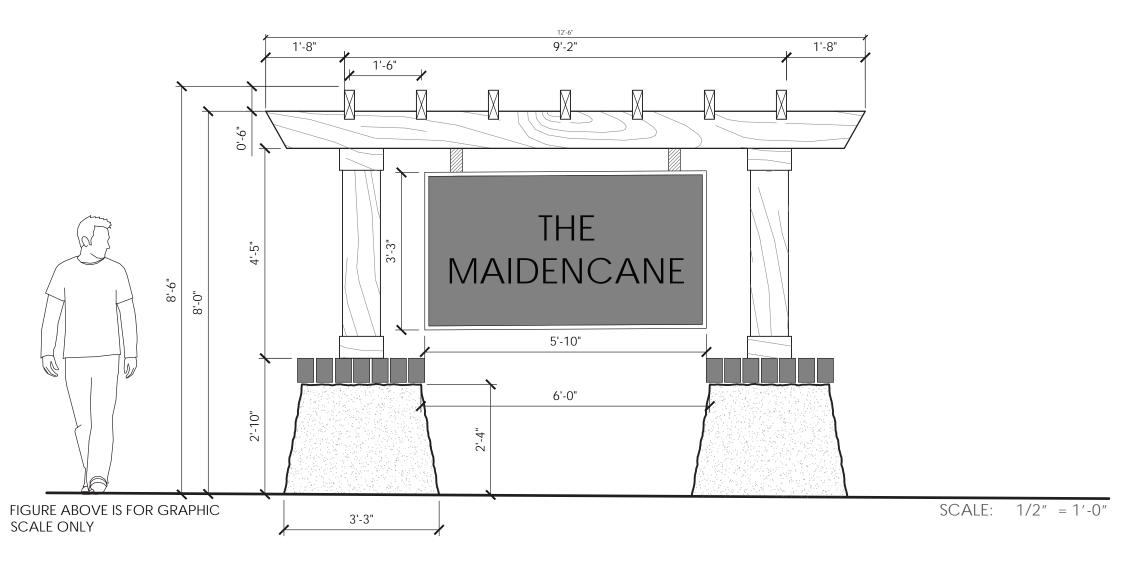

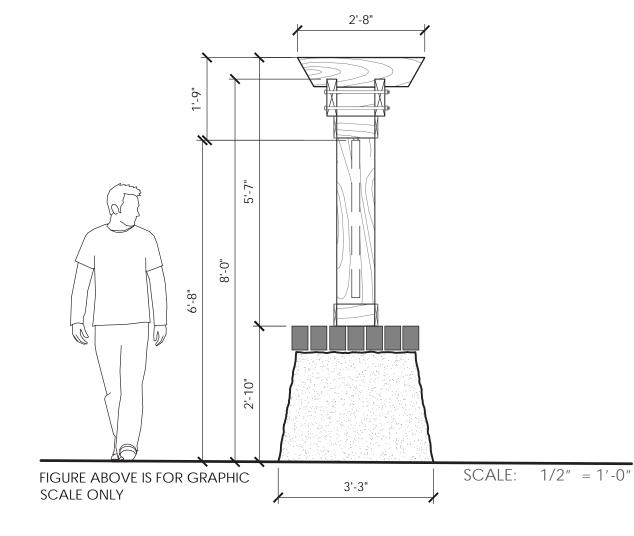

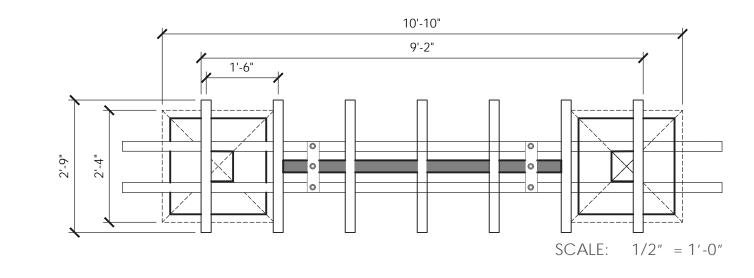


HH ISLAND ACQUISITION PARTNERS,

PERSPECTIVES NOT TO SCALE

THE MAIDENCANE - SIGNAGE RENDERINGS, MATERIALS AND DIMENSIONS

JUNE 26, 2023

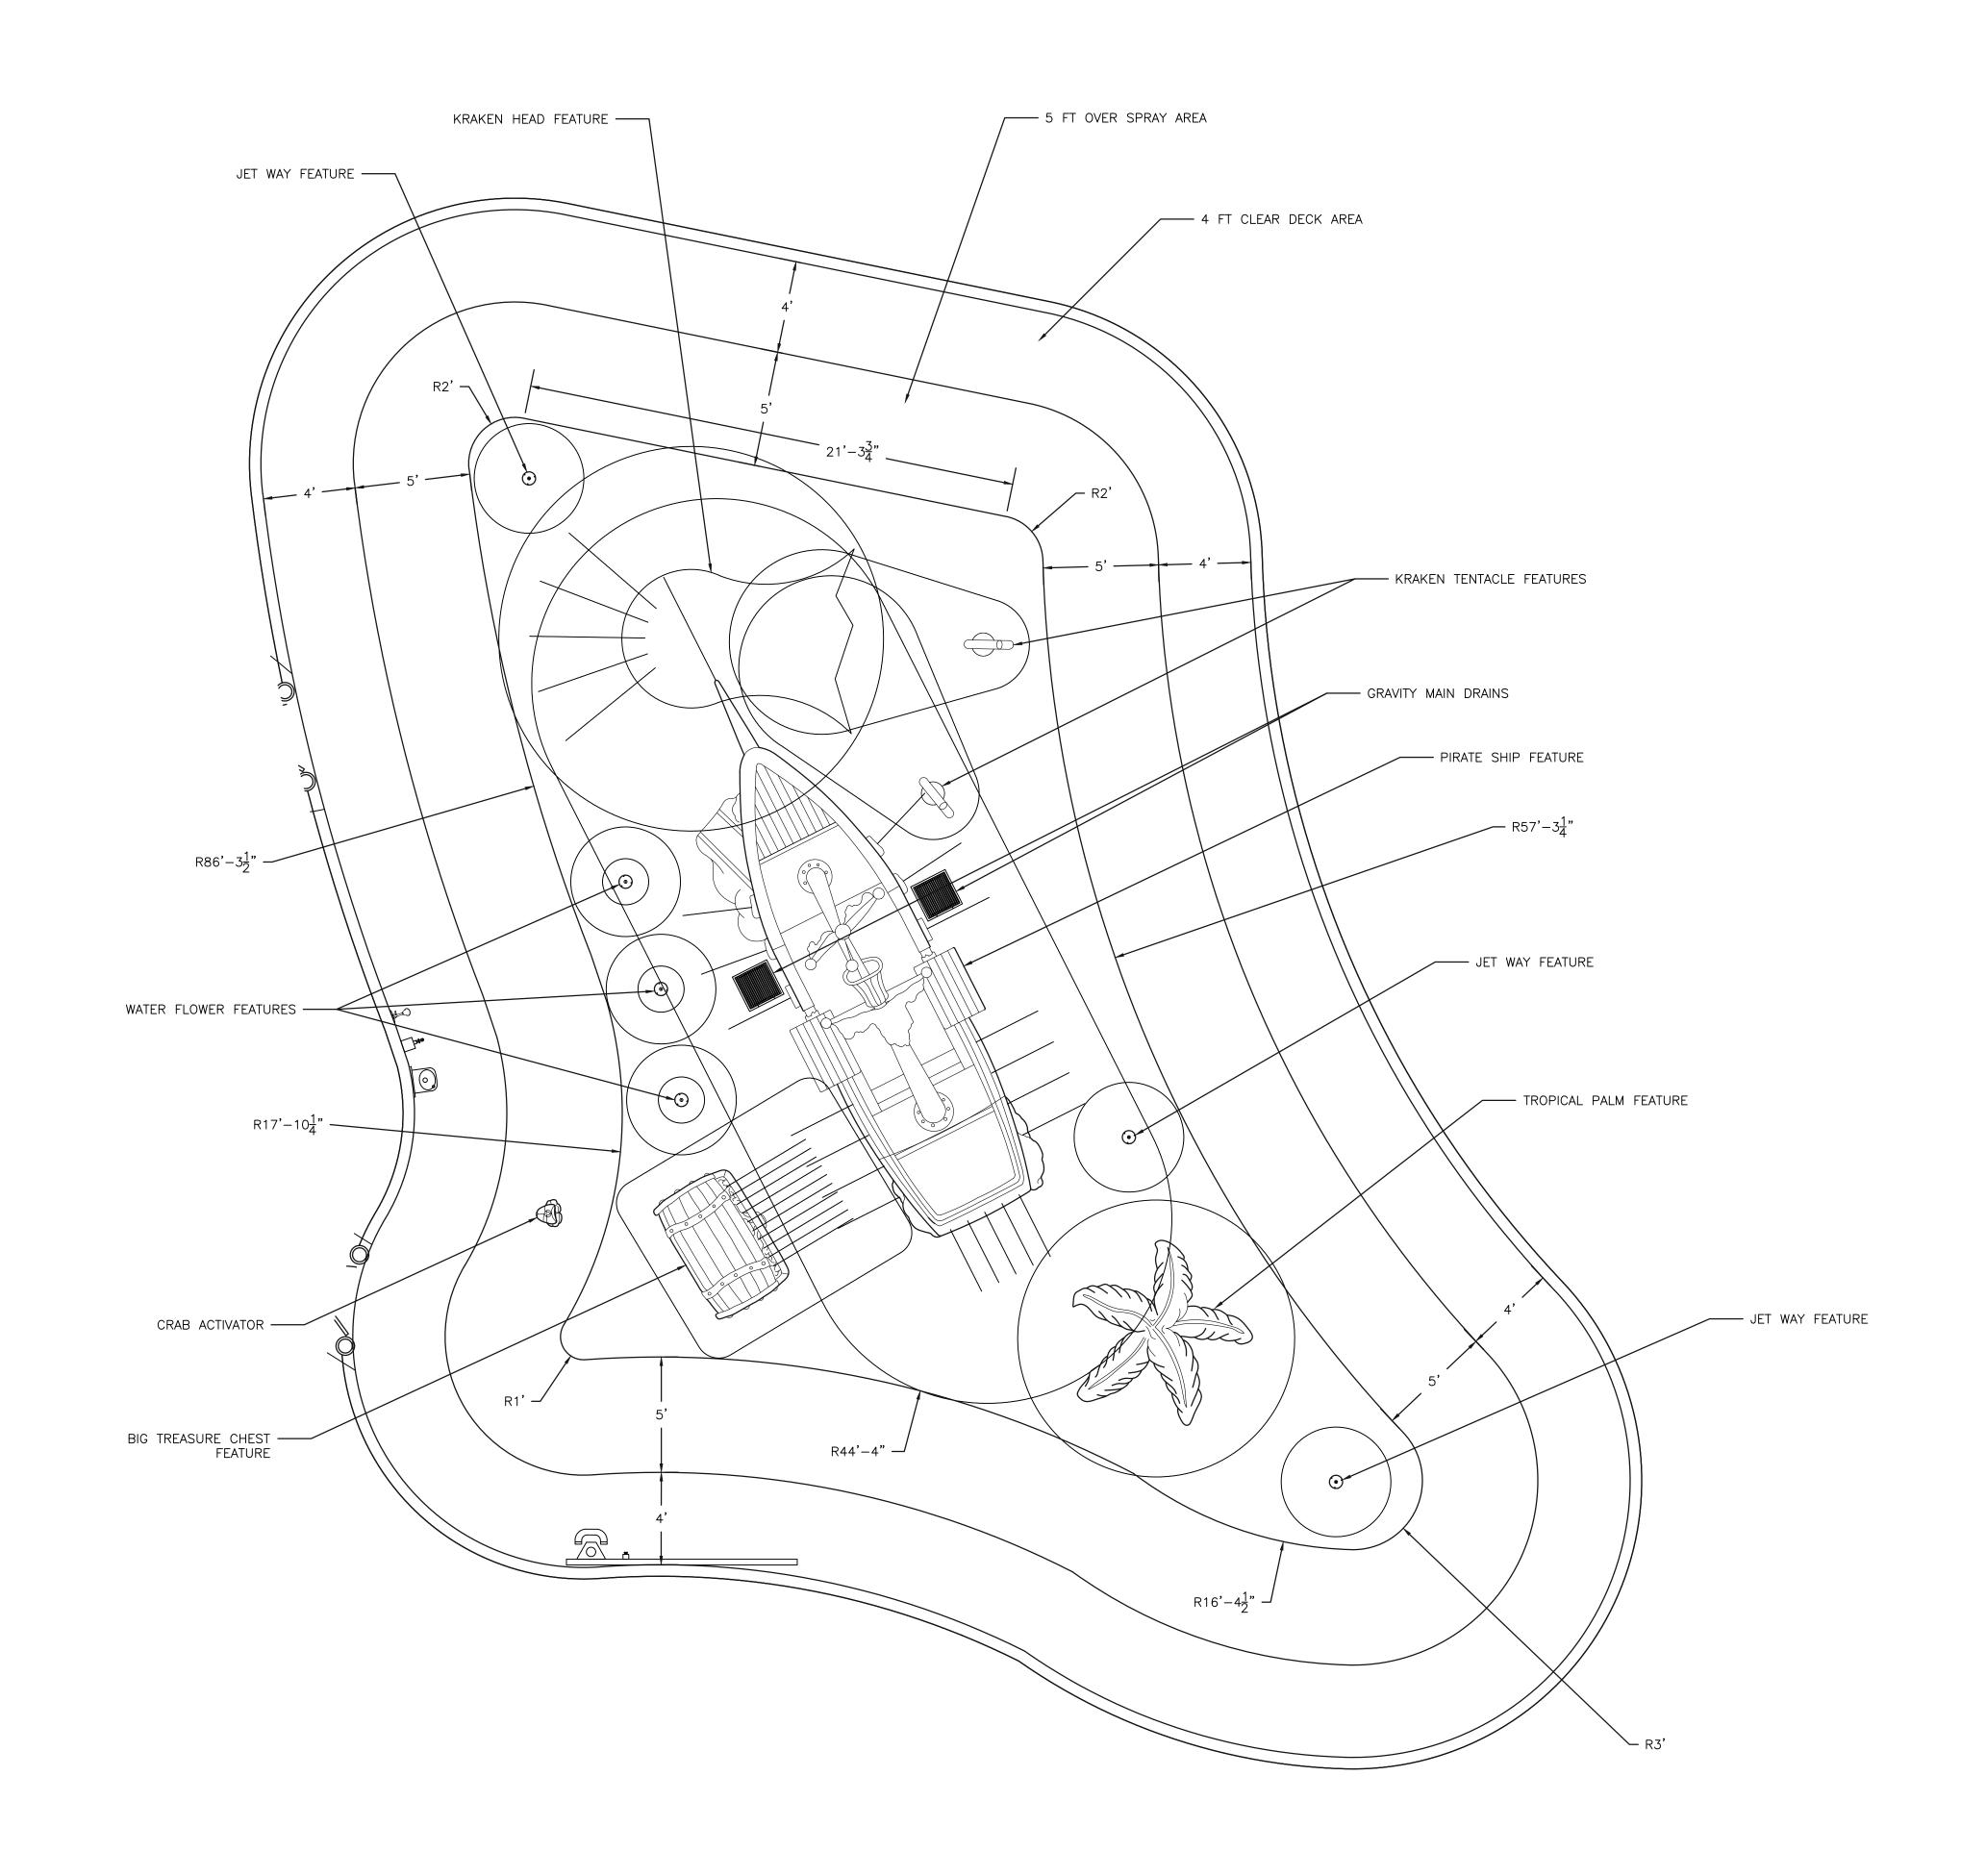



AQUATIC FACILITY CONSULTING 243 Heather Glen Dr. Boiling Springs, SC 29316 O/C: (864) 386-1498

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1 HEALTH COMMENTS 05.26.23 TDE
0 ISSUE FOR PERMIT 12.21.22 TDE
NO. REVISION DATE BY

15 WIMBLEDON HILTON HEAD, SC

SPLASH PAD DIMENSIONS & LAYOUT

DATE: 03.25.22

DRAWN BY: TJL CHECKED BY: TDE


PROJECT NO: 0857


SP-2


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SPLASH PAD DIMENSIONS & LAYOUT

SP-2 SCALE: 1/4" = 1'-0"



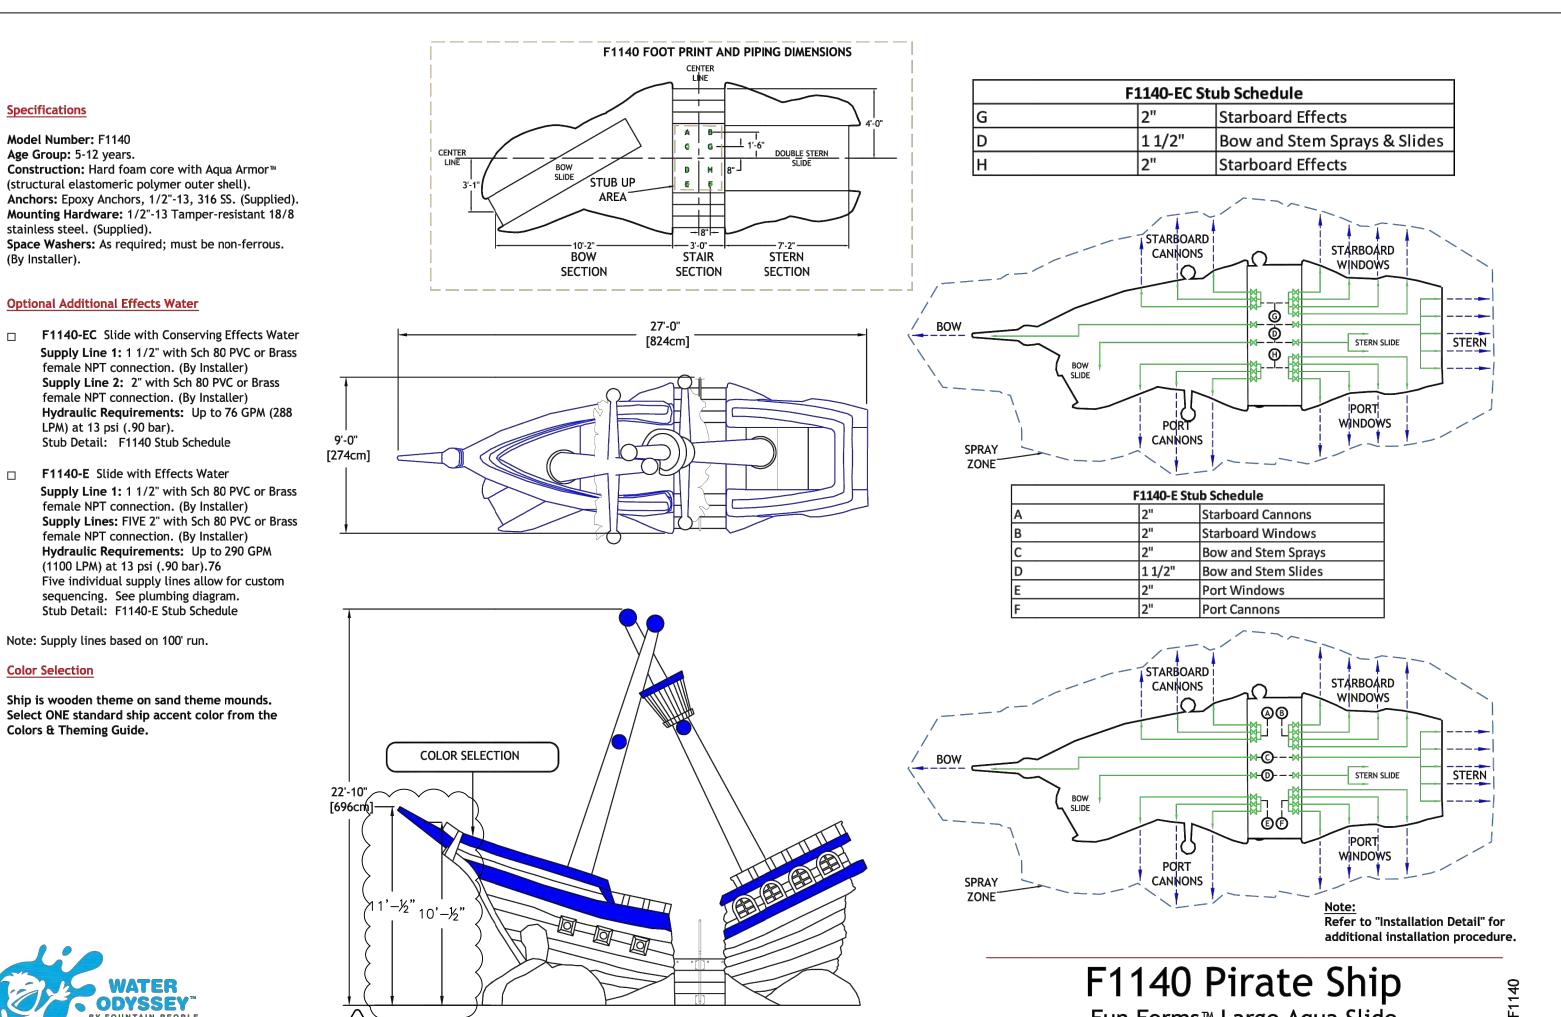

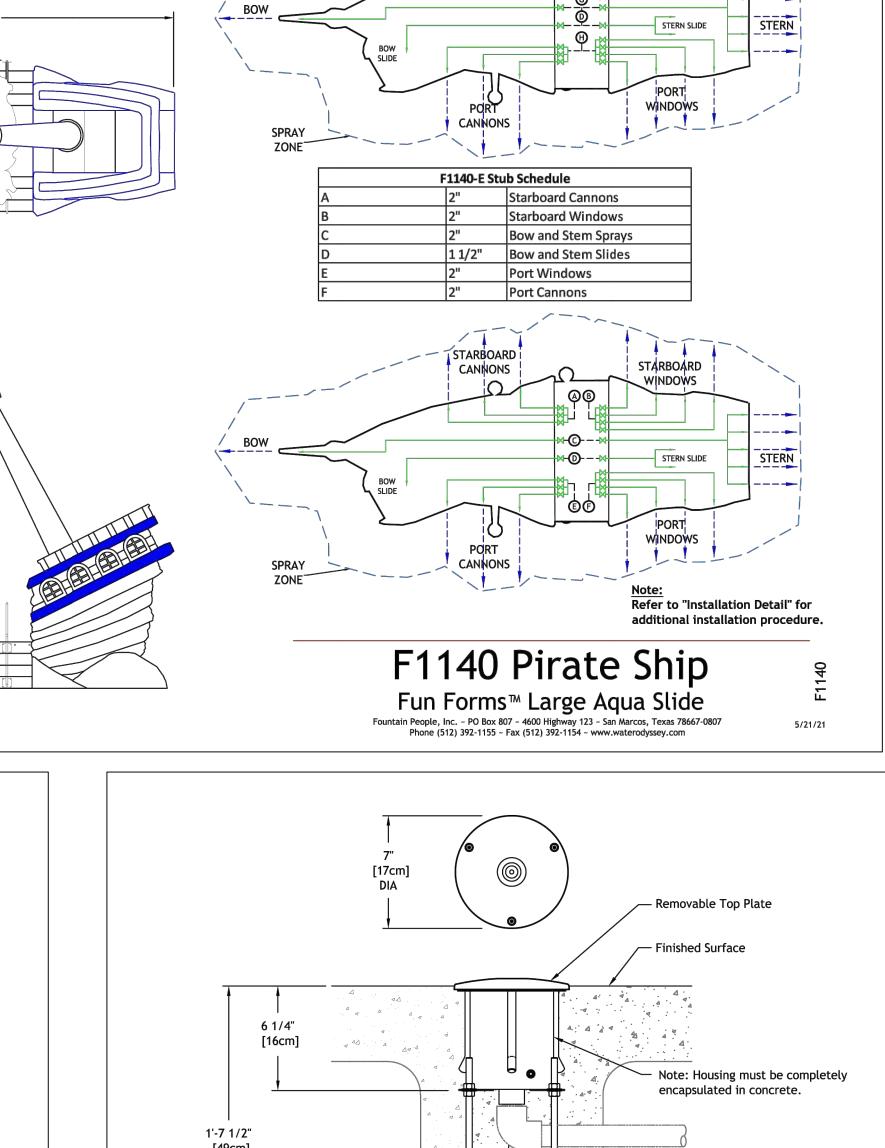

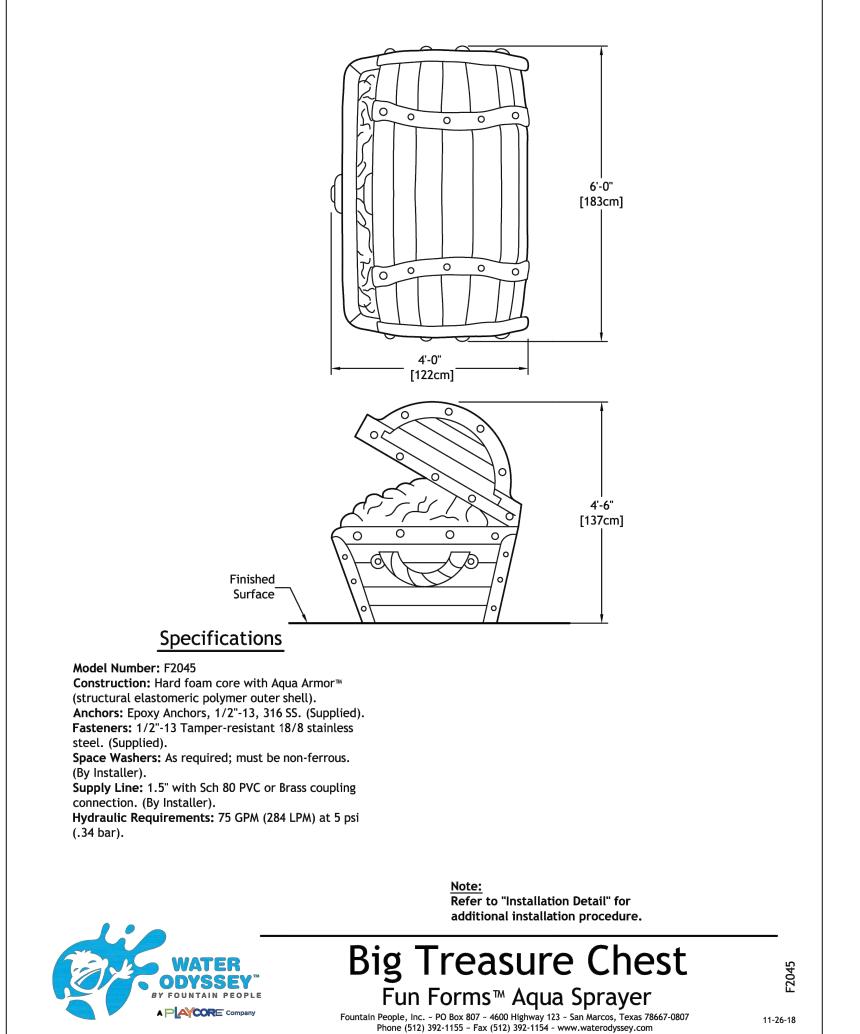**Specifications** 

(By Installer).

Model Number: F1140

Age Group: 5-12 years.

stainless steel. (Supplied).

Optional Additional Effects Water

LPM) at 13 psi (.90 bar).

☐ **F1140-E** Slide with Effects Water

(structural elastomeric polymer outer shell).

female NPT connection. (By Installer)

female NPT connection. (By Installer)

female NPT connection. (By Installer)

female NPT connection. (By Installer) Hydraulic Requirements: Up to 290 GPM

(1100 LPM) at 13 psi (.90 bar).76

sequencing. See plumbing diagram.

Stub Detail: F1140-E Stub Schedule


Ship is wooden theme on sand theme mounds.


Note: Supply lines based on 100' run.


**Color Selection** 

Colors & Theming Guide.

Stub Detail: F1140 Stub Schedule

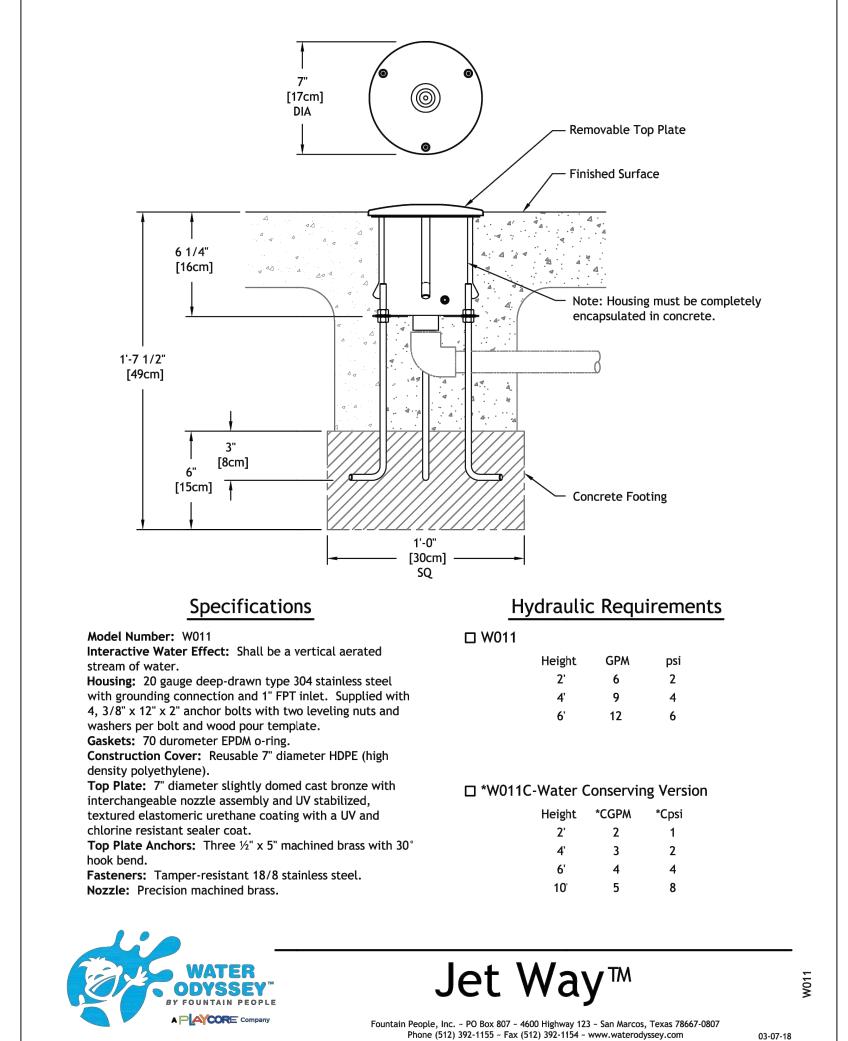

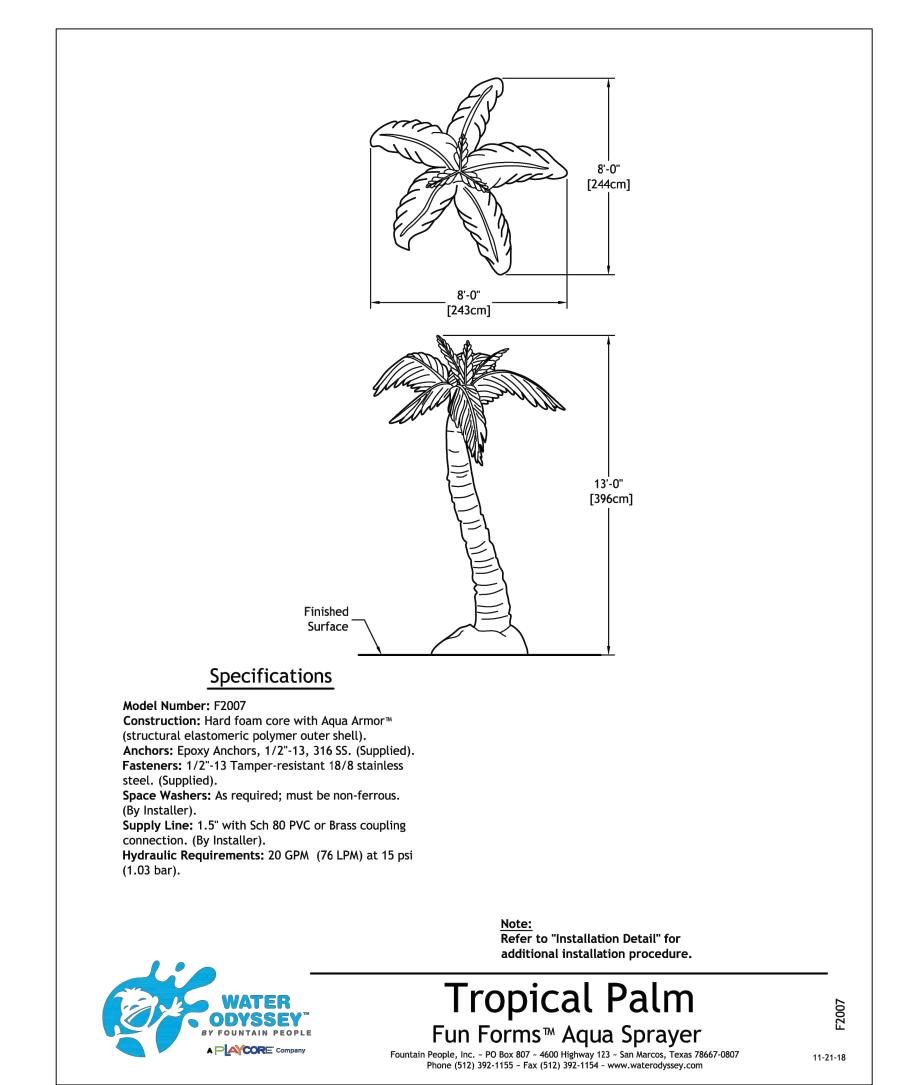

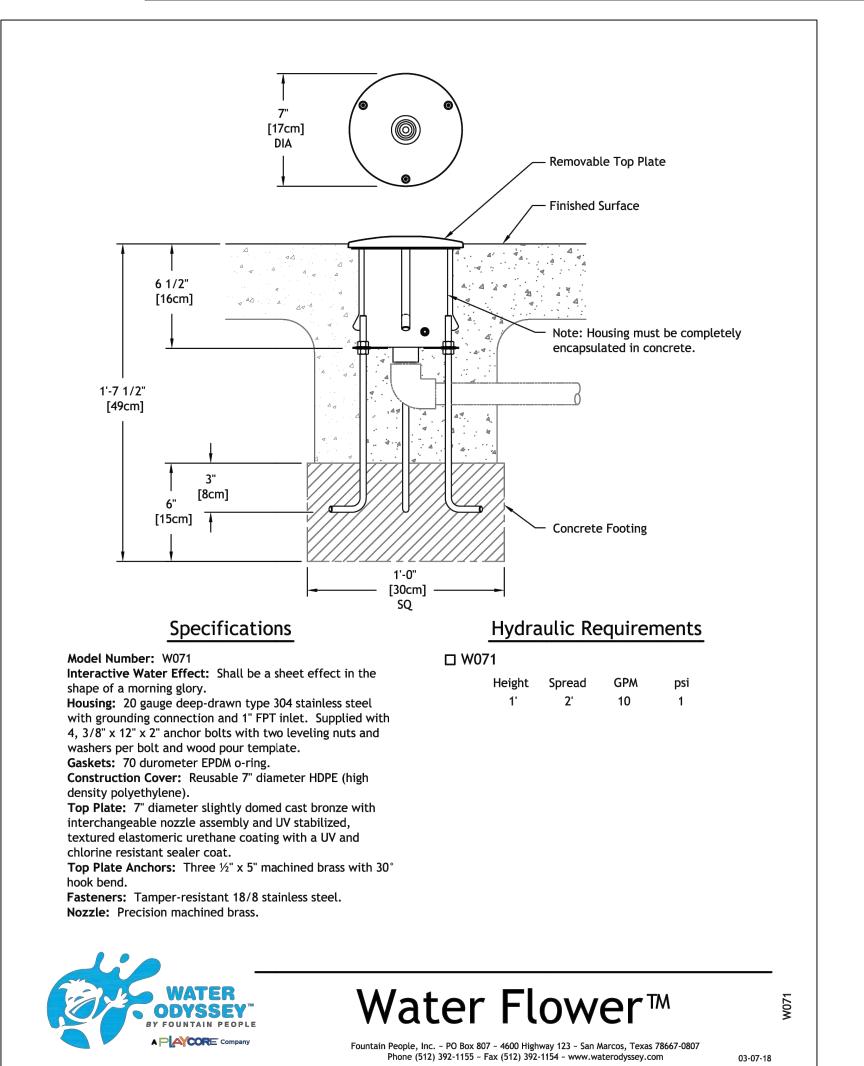



AQUATIC FACILITY CONSULTING 243 Heather Glen Dr. **Boiling Springs, SC 29316** O/C: (864) 386-1498

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HEALTH COMMENTS 05.26.23 TDE ISSUE FOR PERMIT DATE BY REVISION

> 15 WIMBLEDON HILTON HEAD, SC

SPLASH PAD DETAILS

DATE: 03.25.22

DRAWN BY: TJL CHECKED BY: TDE

PROJECT NO: 0857

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RK

# **Wimbledon Hilton Head Splash Pad**

Hilton Head Island, SC

Creating Compelling Aquatic Play Experiences





RK

## **Wimbledon Hilton Head Splash Pad**

Hilton Head Island, SC







# **Wimbledon Hilton Head Splash Pad**

Hilton Head Island, SC





Amenity Center Height: 15'-0"

Mounting Height: noted at luminaire location, to bottom of luminaire

Reflectance: Building: 50%, Pool Deck: 20% Calculation Height: 0'-0"

Luminaire Schedule								
Symbol	Qty	Label	Tag	Arrangement	LLF	Lum Lumens	Description	Total Watts
<u></u>	4	EMM-E03-SL3	PA2	SINGLE	0.920	7929	EMM-E03-LED-E1-SL3-7030	300.8
$\overline{}$	6	EMM-E04-T4	PB	SINGLE	0.920	10506	EMM-E04-LED-E1-T4-7030	583.2
$\overline{}$	3	EMM-E03-SL4	PC1	SINGLE	0.920	7736	EMM-E03-LED-E1-SL4-7030	225.6
$\bigcirc$	7	EMM-E04-5WQ-2	PD1	Back-Back	0.920	10914	EMM-E04-LED-E1-5WQ-7030-b2b	1360.8
$\overline{-}$	2	EMM-E03-SL2	PF1	SINGLE	0.920	7886	EMM-E03-LED-E1-SL2-7030	150.4
$\overline{}$	4	EMM-E02-SL2	PF2	SINGLE	0.920	5257	EMM-E02-LED-E1-SL2-7030	208.4
<u> </u>	1	EMM-E03-T2	SA	SINGLE	0.920	8078	EMM-E03-LED-E1-T2-7030	75.2
$\overline{-}$	1	EMM-E03-T3	SB	SINGLE	0.920	8046	EMM-E03-LED-E1-T3-7030	75.2
$\overline{-}$	21	EMM-E02-T3	SB1	SINGLE	0.920	5364	EMM-E02-LED-E1-T3-7030	1094.1
$\overline{-}$	3	EMM-E03- SL4	SB2	SINGLE	0.920	7736	EMM-E03-LED-E1-SL4-7030	225.6

Calculation Summary									
Label	CalcType	Units	Avg	Max	Min	Avg/Min	Max/Min	PtSpcLr	PtSpcTb
Drive_Grade	Illuminance	Fc	1.6	4.9	0.2	8.15	24.50	10	10
Spill Light_Grade	Illuminance	Fc	0.0	2.1	0.0	N.A.	N.A.	10	10
Surface Parking Lot	Illuminance	Fc	1.4	2.6	0.2	7.00	13.00	10	10
Pool Deck	Illuminance	Fc	14.5	19.9	10.1	1.44	1.97		

#### Notes:


- 1. Calculations based on all pool deck and parking luminaires on.
- 2. Calculations do not include landscape lighting.


The calculations provided in this report are predicted lighting levels based on the above described input data and characteristics. All information should be reviewed for accuracy, understanding and agreement with all information. Any discrepancies should be noted and the preparer of this report immediately advised to clarify or change as required.

Actual lighting levels may vary from this report due to a variety of circumstances, such as: reflectances, voltage variations, objects blocking or redirecting light, different mounting heights, installation, lamp and ballast tolerances, etc. Room is considered completely empty unless noted otherwise above. Unless specifically stated otherwise, predicted foot candles are not a recommendation of lighting levels.

Ardd & Winter, Inc. assumes no responsibility for any such variances and will not be held responsible for lighting levels different from predicted levels in this report. Recipient of this report, or someone designated by recipient, must verify that lighting fixtures will physically fit within the specified location(s). Catalog numbers of lighting fixtures may not be complete as all conditions may not be known.

Where backgrounds are shown, these are typically used for reference purposes only, unless noted otherwise. Additional details available upon request.

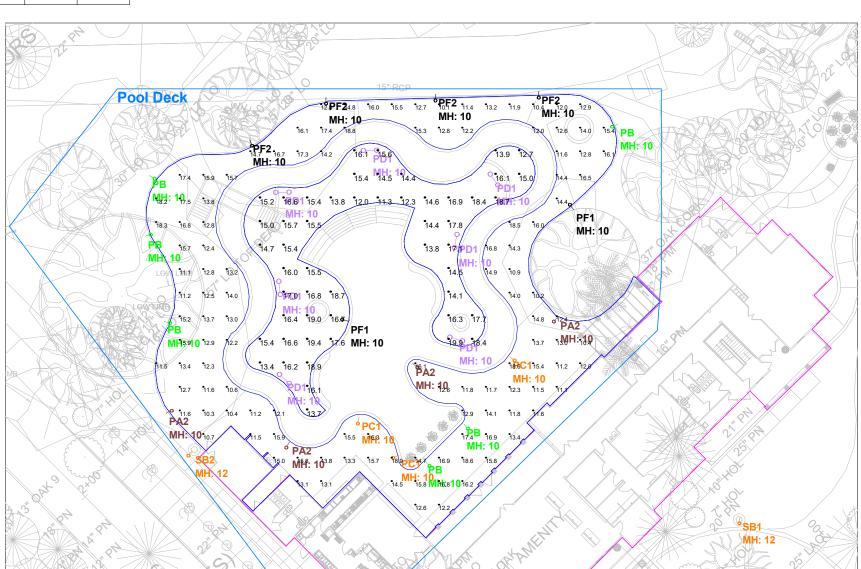

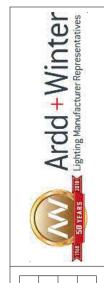

Calculations By: WES	Revised By:	Date:9/2/2022	Scale: Not to Scale
Project Name: 26807.000_15 Wimbledon Drive- Pool Deck		Revision: P6	

Page 1 of 4

#### DESCRIPTION

The EPIC Collection delivers custom luminaire flexibility with high quality, yet availability expectations of standard specification grade product. The EPIC Collection can be dressed to suit any application. Recognizing evolving environmental and legislative trends, the EPIC Collection delivers world class LED optical and performance solutions to the decorative luminaire marketplace.

Catalog #	Туре
Project	
Comments	Date
Prepared by	

#### **SPECIFICATION FEATURES**

#### Construction

TOP: Cast aluminum top housing attaches to cast aluminum mounting arm hub with four stainless steel fasteners. One-piece silicone gasket between mounting hub and top casting seals out moisture and contaminants. (See the mounting accessories section for a full selection of mounting arms. (Only these arms are compatible with the Epic luminaire). MIDSECTION: Continuous silicone gaskets seal lens to top casting and shade. The mid section features cast aluminum construction and stainless steel assembly. SHADES: Heavy gauge precision spun aluminum shades offer superior surface finish and consistency in form. DOORFRAME: Die-cast aluminum 1/8" thick door and doorframe seal to underside of shade with a thick wall continuous silicone gasket. Mounting hub ships attached to mounting arm.

#### Optics

**DIMENSIONS** 

Choice of twelve patented, highefficiency AccuLED Optic™ technology manufactured from

injection-molded acrylic. Optics are precisely designed to shape the optics, maximizing efficiency and application spacing. AccuLED Optic technology, creates consistent distributions with the scalability to meet customized application requirements. Offered Standard in 4000K (+/- 275K) CCT and nominal 70 CRI. Optional 3000K CCT and 5000K CC. For the ultimate level of spill light control, an optional house-side shield accessory can be field or factory installed. The house-side shield is designed to seamlessly integrate with the SL2, SL3 or SL4 optics.

#### **Electrical**

LED drivers mount to die-cast aluminum back housing for optimal heat sinking, operation efficacy, and prolonged life. Standard drivers feature electronic universal voltage (120-277V 50/60Hz), 347V 60Hz or 480V 60Hz operation, greater than 0.9 power factor, less that 20% harmonic distortion, and is suitable for operation in -40°C to 40°C ambient environments. All fixtures are shipped standard

with 10kV/10kA common and differential - mode surge protection. LightBARs feature and IP66 enclosure rating and maintain greater than 95% lumen maintenance at 60,000 hours per IESNA TM-21. Occupancy sensor and dimming options available.

#### Finish

Housing is finished in five-stage super TGIC polyester powder coat paint, 2.5 mil nominal thickness for superior protection against fade and wear. LightBAR™ cover plates are standard white and may be specified to match finish of luminaire housing. Standard colors include black, bronze, grey, white, dark platinum and graphite metallic. RAL and custom color matches available. Consult Outdoor Architectural Colors brochure for a complete selection.

#### Warranty

Five-year warranty.



nvue



#### **ECM/EMM EPIC MEDIUM LED**

1 - 4 LightBARs Solid State LED

**DECORATIVE AREA LUMINAIRE** 





#### **CERTIFICATION DATA**

UL/cUL Listed DesignLights Consortium® Qualified\* IP66 LlahtBARs LM79 / LM80 Compliant 2G Vibration Tested ISO 9001

#### **ENERGY DATA**

Electronic LED Driver


>0.9 Power Factor <20% Total Harmonic Distortion 120-277V 50/60Hz, 347V/60Hz, 480V/60Hz


-40°C Minimum Temperature 40°C Ambient Temperature Rating

Effective Projected Area: (Sq. Ft.) 0.94

**Approximate Net Weight:** 45 lbs. [20 kgs.]

> TD500028EN July 31, 2020 1:14 PM

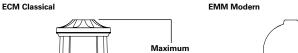

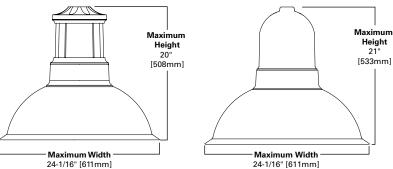


See configurations for more detailed information.





page 2 ECM/EMM EPIC MEDIUM LED

#### CONFIGURATIONS

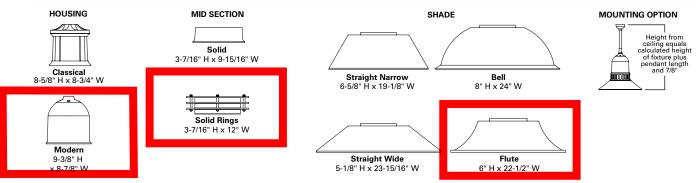

#### POWER AND LUMENS BY BAR COUNT (21 LED LIGHTBARS)

POWER AND	LIIMENS	RV RAR	COLINT (	7 I FD	LIGHTBARS)


Number of	LightBARs	E01	E02	E03	E04	
Drive Curre	ent	350mA Drive Current				
Power (Wa	tts)	25W	52W	75W	97W	
Current @	<b>120V</b> (A)	0.22	0.44	0.63	0.82	
Current @	<b>277V</b> (A)	0.10	0.20	0.28	0.36	
Power (Wa	tts)	31W	58W	82W	99W	
Current @	<b>347V</b> (A)	0.11	0.19	0.28	0.29	
Current @	480V (A)	0.09	0.15	0.20	0.21	
	Lumens	2,948	5,896	8,844	11,792	
T2	BUG Rating	B1-U0-G1	B2-U0-G2	B3-U0-G3	B3-U0-G3	
	Lumens	2,936	5,873	8,809	11,745	
Т3	BUG Rating	B1-U0-G1	B2-U0-G2	B3-U0-G3	B3-U0-G3	
T.	Lumens	2,876	5,752	8,627	11,503	
T4	BUG Rating	B1-U0-G1	B1-U0-G2	B1-U0-G2	B2-U0-G3	
5MQ	Lumens	3,054	6,108	9,161	12,215	
	BUG Rating	B2-U0-G1	B3-U0-G1	B3-U0-G2	B4-U0-G2	
FIMO	Lumens	2,987	5,975	8,962	11,949	
5WQ	BUG Rating	B2-U0-G1	B3-U0-G1	B3-U0-G2	B4-U0-G2	
5ΧΩ	Lumens	2,982	5,963	8,945	11,926	
53.0	BUG Rating	B2-U0-G1	B3-U0-G2	B3-U0-G3	B4-U0-G3	
01.0	Lumens	2,878	5,756	8,634	11,512	
SL2	BUG Rating	B1-U0-G1	B1-U0-G2	B2-U0-G2	B2-U0-G2	
01.0	Lumens	2,894	5,788	8,682	11,576	
SL3	BUG Rating	B1-U0-G1	B1-U0-G2	B2-U0-G2	B2-U0-G2	
CI 4	Lumens	2,823	5,647	8,470	11,294	
SL4	BUG Rating	B1-U0-G1	B1-U0-G2	B2-U0-G2	B2-U0-G2	
RW	Lumens	2,957	5,915	8,872	11,829	
	BUG Rating	B2-U0-G2	B3-U0-G3	B3-U0-G3	B3-U0-G3	
SLL/SLR	Lumens	2,616	5,231	7,847	10,462	
SLL/SLK	BUG Rating	B1-U0-G2	B1-U0-G2	B1-U0-G3	B2-U0-G3	

Number of LightBARs		F01	F02	F03	F04
Drive Curre	nt		1A Drive	Current	•
Power (Wat	tts)	26W	55W	78W	102W
Current @ '	120V (A)	0.22	0.46	0.66	0.86
Current @ 2	277V (A)	0.10	0.21	0.29	0.37
Power (Wat	tts)	32W	60W	85W	105W
Current @ 3	<b>347V</b> (A)	0.11	0.19	0.28	0.30
Current @ 4	180V (A)	0.09	0.15	0.21	0.22
T2	Lumens	2,434	4,867	7,301	9,735
12	BUG Rating	B1-U0-G1	B2-U0-G2	B2-U0-G2	B3-U0-G3
Т3	Lumens	2,424	4,848	7,272	9,696
13	BUG Rating	B1-U0-G1	B2-U0-G2	B2-U0-G2	B3-U0-G3
T4	Lumens	2,374	4,748	7,122	9,496
14	BUG Rating	B1-U0-G1	B1-U0-G2	B1-U0-G2	B2-U0-G2
5MQ	Lumens	2,521	5,042	7,563	10,084
SIVICE	BUG Rating	B2-U0-G1	B3-U0-G1	B3-U0-G1	B3-U0-G2
5WΩ	Lumens	2,466	4,932	7,398	9,864
5WQ	BUG Rating	B2-U0-G1	B3-U0-G1	B3-U0-G2	B4-U0-G2
5ΧΩ	Lumens	2,461	4,923	7,384	9,845
57.0	BUG Rating	B2-U0-G1	B3-U0-G2	B3-U0-G2	B4-U0-G3
SL2	Lumens	2,376	4,752	7,127	9,503
SLZ	BUG Rating	B1-U0-G1	B1-U0-G1	B2-U0-G2	B2-U0-G2
SL3	Lumens	2,389	4,778	7,167	9,556
SLS	BUG Rating	B1-U0-G1	B1-U0-G1	B1-U0-G2	B2-U0-G2
SIA	Lumens	2,331	4,662	6,993	9,323
SL4	BUG Rating	B1-U0-G1	B1-U0-G2	B1-U0-G2	B2-U0-G2
RW	Lumens	2,441	4,883	7,324	9,765
n#V	BUG Rating	B1-U0-G1	B2-U0-G2	B3-U0-G3	B3-U0-G3
SLL/SLR	Lumens	2,159	4,318	6,478	8,637
JLL/JLN	BUG Rating	B1-U0-G1	B1-U0-G2	B1-U0-G3	B1-U0-G3

#### LUMEN MAINTENANCE

Ambient Temperature	25,000 Hours*	50,000 Hours*	60,000 Hours*	100,000 Hours	Theoretical L70 (Hours)
25°C	> 99%	> 97%	> 96%	> 93%	> 450,000
40°C	> 98%	> 97%	> 96%	> 92%	> 425,000
50°C	> 97%	> 96%	> 95%	> 91%	> 400,000

<sup>\*</sup> Per IESNA TM-21 data.

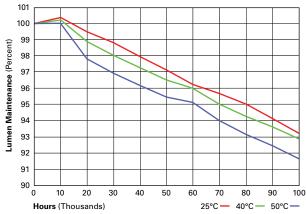

# Ambient Temperature Lumen Multiplier 10°C 1.02 15°C 1.01 25°C 1.00 40°C 0.99 50°C 0.96

**LUMEN MULTIPLIER** 



page 3 ECM/EMM EPIC MEDIUM LED

#### **CONTROL OPTIONS**

#### 0-10V (DIM)

The DIM option provides 0-10V dimming wire leads for use with a lighting control panel or other control method.

#### Photocontrol (PC, PER and PER7)


Optional button-type photocontrol (PC) and photocontrol receptacles (PER and PER7) provide a flexible solution to enable "dusk-to-dawn" lighting by sensing light levels. Advanced control systems compatible with NEMA 7-pin standards can be utilized with the PER7 receptacle.


#### **Dimming Occupancy Sensor** (MS/DIM-LXX, MS/X-LXX and MS-LXX)


These sensors are factory installed in the luminaire housing. When the MS/DIM-LXX sensor option is selected, the occupancy sensor is connected to a dimming driver and the entire luminaire dims when there is no activity detected. When activity is detected, the luminaire returns to full light output. The MS/DIM sensor is factory preset to dim down to approximately 50 percent power with a time delay of five minutes. The MS-LXX sensor is factory preset to turn the luminaire off after five minutes of no activity. The MS/X-LXX is also preset for five minutes and only controls the specified number of light engines to maintain steady output from the remaining light engines.


These occupancy sensors includes an integral photocell that can be activated with the FSIR-100 accessory for "dusk-to-dawn" control or daylight harvesting - the factory preset is OFF. The FSIR-100 is a wireless tool utilized for changing the dimming level, time delay, sensitivity and other parameters.

A variety of sensor lens are available to optimize the coverage pattern for mounting heights from 8'-40'.

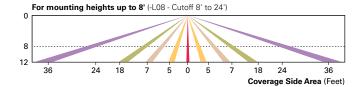

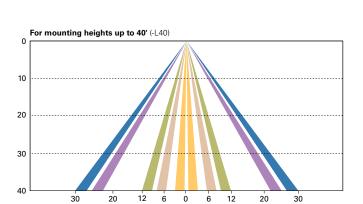

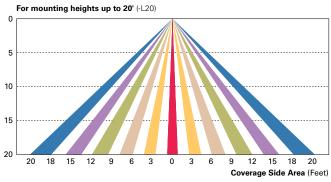

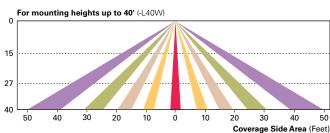



#### LumaWatt Pro Wireless Control and Monitoring System (LWR-LW and LWR-LN)

Coverage Side Area (Feet)

The LumaWatt Pro system is a peer-to-peer wireless network of luminaire-integral sensors for any sized project. Each sensor is capable of motion and photo sensing, metering power consumption and wireless communication. The end-user can securely create and manage sensor profiles with browser-based management software. The software will automatically broadcast to the sensors via wireless gateways for zone-based and individual luminaire control. The LumaWatt Pro software provides smart building solutions by utilizing the sensor to provide easy-to-use dashboard and analytic capabilities such as improved energy savings, traffic flow analysis, building management software integration and more.

For additional details, refer to the LumaWatt Pro product guides.

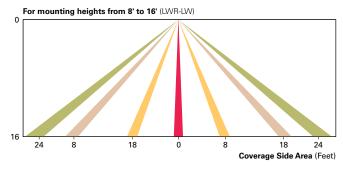

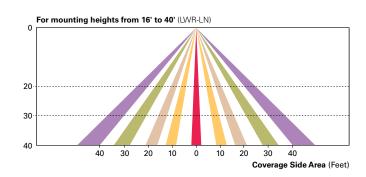

ECM/EMM FPIC MEDIUM LED

#### ORDERING INFORMATION

Sample Number: ECM-E04-LED-E1-T2-FL-GM

Product Family <sup>1</sup>	Number of LightBARs 2,3	Lamp Type	Voltage	Distribution	Mid Section Type	Shade Type	Color 5
ECM=Epic Classical Medium EMM=Epic Modern Medium	E01=(1) 21 LED LightBAR E02=(2) 21 LED LightBARS E03=(3) 21 LED LightBARS E04=(4) 21 LED LightBARS F01=(1) 7 LED LightBARS F02=(2) 7 LED LightBARS F03=(3) 7 LED LightBARS F04=(4) 7 LED LightBARS	LED=Solid State Light Emitting Diodes	E1=Electronic (120-277V) 347=347V 480=480V <sup>4</sup>	T2=Type II T3=Type III T4=Type IV SL2=Type II w/Spill Control SL3=Type II w/Spill Control SL4=Type IV w/Spill Control SMQ=Type V Square Medium SWQ=Type V Square Wide SXQ=Type V Square Extra Wide RW=Rectangular Wide SLL=90° Spill Light Eliminator Left SLR=90° Spill Light Eliminator Right	SO=Solid SR=Solid Rings	SN=Straight Narrow SW=Straight Wide BL=Bell FL=Flute	AP=Grey BZ=Bronze BK=Black DP=Dark Platinum GM=Graphite Metallic WH=White
Options (Add as Suffix)		Accessories (Or	der Separately) 13				

2L=Two Circuits 6

7030=70 CRI / 3000K CCT 7 7050=70 CRI / 5000K CCT 7 8030=80 CRI / 3000K CCT 7

LCF=LightBAR Cover Plate Matches Housing

MS-LXX=Motion Sensor for ON/OFF Operation 8 MS/X-LXX=Motion Sensor for Bi-Level Switching 9

PMXX=Pendant Mount (XX=Pendant Length in Inches, 9.5" min - 48.0" max) <sup>10</sup>
HSS=Factory Installed House Side Shield <sup>11</sup>
DIM=0-10V Dimming Driver <sup>12</sup>

OA/RA1016=NEMA Twistlock Photocontrol - Multi-Tap

OA/RA1027=NEMA Twistlock Photocontrol - 480V OA/RA1201=NEMA Twistlock Photocontrol - 347V

OA/RA1013=Photocontrol Shorting Cap LB/HSS-21=Field Installed House Side Shield for "E" LightBARs 11, 15

LB/HSS-07=Field Installed House Side Shield for "F" LightBARs 11, 15

Mounting Accessories (Order Separately)

VA6150-XX=Bishop Wall Mount Arm

VA6151-XX=Bishop Wall Mount Arm with Cross Rod

VA6152-XX=Traditional Wall Mount Arm

VA6153-XX=Traditional Wall Mount Arm with 45° Strap VA6154-XX=Bishop Single Pole Mount Arm

VA6155-XX=Bishop Single Pole Mount Arm with Cross Rod

VA6156-XX=Bishop Twin Pole Mount Arm
VA6157-XX=Bishop Twin Pole Mount Arm with Cross Rods
VA6158-XX=Traditional Single Pole Mount Arm

VA6159-XX=Traditional Single Pole Mount Arm with Rounded Upper Bar

VA6160-XX=Traditional Single Pole Mount Arm with Rounded Lower Bar <sup>14</sup>
VA6161-XX=Traditional Single Pole Mount Arm with 45° Upper Bar
VA6162-XX=Traditional Single Pole Mount Arm with 45° Lower Bar <sup>14</sup>

VA6163-XX=Traditional Single Pole Mount Arm with 45° Upper Strap
VA6165-XX=Traditional Twin Pole Mount Arm
VA6166-XX=Traditional Twin Pole Mount Arm
VA6166-XX=Traditional Twin Pole Mount Arm with Rounded Upper Bars
VA6167-XX=Traditional Twin Pole Mount Arm with Rounded Lower Bars

14 VA6168-XX=Traditional Twin Pole Mount Arm with 45° Upper Bars VA6169-XX=Traditional Twin Pole Mount Arm with 45° Lower Bars <sup>1</sup>

VA6170-XX=Traditional Twin Pole Mount Arm with 45° Upper Straps

VA6171-XX=Mast Arm Adapter

Modern

VA6101-XX=Bishop Wall Mount Arm

VA6102-XX=Bishop Wall Mount Arm with Cross Rod

VA6103-XX=Traditional Wall Mount Arm

VA6104-XX=Traditional Wall Mount Arm with 45° Strap VA6105-XX=Bishop Single Pole Mount Arm

VA6106-XX=Bishop Single Pole Mount Arm with Cross Rod

VA6107-XX=Bishop Twin Pole Mount Arm
VA6108-XX=Bishop Twin Pole Mount Arm with Cross Rods

VA6109-XX=Traditional Single Pole Mount Arm

VA6110-XX=Traditional Single Pole Mount Arm with Rounded Upper Bar

VA6111-XX=Traditional Single Pole Mount Arm with Rounded Lower Bar <sup>14</sup> VA6112-XX=Traditional Single Pole Mount Arm with 45° Upper Bar VA6113-XX=Traditional Single Pole Mount Arm with 45° Lower Bar <sup>14</sup>

VA6114-XX=Traditional Single Pole Mount Arm with 45° Upper Strap

VA6116-XX=Traditional Twin Pole Mount Arm VA6117-XX=Traditional Twin Pole Mount Arm with Rounded Upper Bars VA6118-XX=Traditional Twin Pole Mount Arm with Rounded Lower Bars 14

VA6119-XX=Traditional Twin Pole Mount Arm with 45° Upper Bars VA6120-XX=Traditional Twin Pole Mount Arm with 45° Lower Bars <sup>14</sup> VA6121-XX=Traditional Twin Pole Mount Arm with 45° Upper Straps

VA6122-XX=Mast Arm Adapter

Accessory Options 16 V=Victorian Finial 17

M=Modern Finial 17

A=Architectural Finial 17

N=Nostalgic Finial 17

R=NEMA Twistlock Photocontrol Receptacle 18



Bronze (BZ)

#### NOTES

- 1. Arm not included. Order separately. See accessories
- 2. Standard 4000K CCT and greater than 70 RI.
  3. 21 LED LightBAR powered by 350mA and 7 LED LightBAR powered by 1A.
  4. Only for use with 480V Wye systems. Per NEC, not for use with ungrounded systems, impedance grounded systems or corner grounded systems (commonly known as Three Phase Three Wire Delta, Three Phase High Leg Delta and Three Phase Corner Grounded Delta systems). Delta and Three Phase Corner Grounded Delta systems).

  5. Custom and RAL color matching available upon request. Consult your lighting representative at Cooper Lighting Solutions for more information.

  6. Low-level output varies by bar count. Consult factory. Requires quantity of two or more LightBARs.

  7. Consult customer service for lead times and multiplier.

  8. Sensor mounted to the luminaire. Available in E01-E04 and F01-F04 configurations. Replace "XX" with mounting height in feet for proper lens selection, (e.g., MS-L25). Consult factory for additional information.

  9. Sensor mounted to the luminaire. Available in E02-E04 and F02-F04 configurations. Replace "X" with number of LightBARs operating in low output mode and replace XX with mounting height in feet for proper lens selection, (e.g., MS/3-L25). Maximum four bars in low output mode. Consult factory for additional information.

  10. Pendant mount option "PMXX" must be used with Invue Pendant mount kit only. Includes pendant pipe, swivel hangar and canopy cover. Other pendant lengths can be specified in inches (XX). Minimum pendant length is 9-172". For lengths above 48", consult your lighting representative at Cooper Lighting Solutions for more information.

  11. Only for use with SL2, SL3 and SL4 distributions.

  12. Dimming leads provide for external 0-10V control system (by others).

  13. Replace XX with color suffix.

  14. Only available with traditional arms.

  15. One required for each LightBAR.

  16. Add as suffix to mounting accessory. Example: VA6106-BK-R.

  17. Not available with finials, pendant mount "PMA8" or bishop wall mounts.

  18. Requires use of 4" O.D. round straight pole.


- 18. Requires use of 4" O.D. round straight pole.




ECM/EMM EPIC MEDIUM LED page 5

#### **MOUNTING ACCESSORIES**

Pole mount arms are designed to fit both medium ECM/EMM housings. (Only these arms are compatible with the Epic luminaire). Arms feature a precision welded cast aluminum mounting hub for attachment of fixture head to arm with four stainless steel fasteners. Wall mount arms compliment pole mount luminaires and attractively transition fixture scale in lower mounting height pedestrian environments. Wall mount arms are designed to fit both medium ECM/EMM housings. Arms feature a precision welded cast aluminum mounting hub for attachment of fixture head to arm with four stainless steel fasteners.

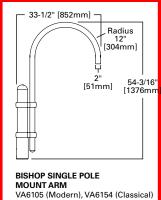


Slipfits over 4" round straight pole, or 4" O.D. by 6" tall round tenon. Weight: 24 lbs. E.P.A: 0.92

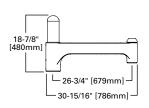


#### TRADITIONAL SINGLE POLE MOUNT ARM

VA6109 (Modern), VA6158 (Classical) Slipfits over 4" round straight pole, or 4" O.D. by 6" tall round tenon. Weight: 20 lbs. E.P.A: 0.86

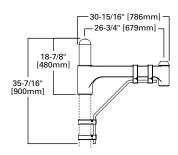


#### TRADITIONAL SINGLE POLE MOUNT ARM WITH 45° LOWER BAR VA6113 (Modern), VA6162 (Classical) Slipfits over 4" round straight pole, or 4" O.D. by 6" tall round tenon. Weight: 24 lbs. E.P.A: 1.17

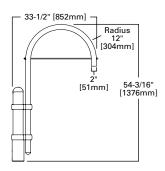


#### **BISHOP SINGLE POLE MOUNT ARM** WITH CROSS ROD

VA6106 (Modern), VA6155 (Classical) Slipfits over 4" round straight pole, or 4" O.D. by 6" tall round tenon. Weight: 25 lbs. E.P.A: 0.98

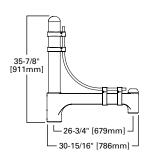


#### TRADITIONAL SINGLE POLE MOUNT ARM WITH ROUNDED UPPER BAR

VA6110 (Modern), VA6159 (Classical) Slipfits over 4" round straight pole, or 4" O.D. by 6" tall round tenon. Weight: 28 lbs. E.P.A: 1.4

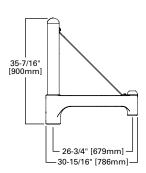


#### TRADITIONAL SINGLE POLE MOUNT ARM WITH 45° UPPER STRAP VA6114 (Modern), VA6163 (Classical)

Slipfits over 4" round straight pole, or 4" O.D. by 6" tall round tenon. Weight: 24 lbs. E.P.A: 1.17

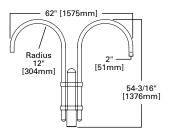


BISHOP TWIN POLE MOUNT ARM VA6107 (Modern), VA6156 (Classical) Slipfits over 4" round straight pole, or 4" O.D. by 6" tall round tenon. Weight: 37 lbs. E.P.A: 1.43

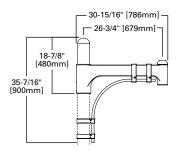


#### TRADITIONAL SINGLE POLE MOUNT ARM WITH ROUNDED LOWER BAR

VA6111 (Modern), VA6160 (Classical) Slipfits over 4" round straight pole, or 4" O.D. by 6" tall round tenon. Weight: 25 lbs. E.P.A: 1.16

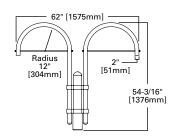


#### BISHOPTWIN POLE MOUNT ARM WITH CROSS RODS

VA6108 (Modern), VA6157 (Classical) Slipfits over 4" round straight pole, or 4" O.D. by 6" tall round tenon. Weight: 39 lbs. E.P.A: 1.55

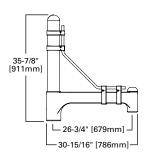

#### TRADITIONAL SINGLE POLE MOUNT ARM WITH 45° UPPER BAR

VA6112 (Modern), VA6161 (Classical) Slipfits over 4" round straight pole, or 4" O.D. by 6" round tenon. Weight: 28 lbs. E.P.A: 1.38

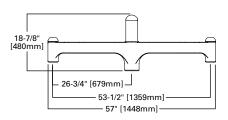

#### TRADITIONAL TWIN POLE MOUNT ARM

VA6116 (Modern), VA6165 (Classical) Slipfits over 4" round straight pole, or 4" O.D. by 6" tall round tenon. Weight: 30 lbs. E.P.A: 1.44



Bronze (BZ)



#### **Outdoor**



Туре
Date

# DECORATIVE ALUMINUM POLES


#### DESIGN CONSIDERATIONS - VIBRATIONS AND NON-GROUND MOUNTED INSTALLATIONS

The information contained herein is for general guidance only and is not a replacement for professional judgment. Design considerations for wind-induced vibrations and non-ground mounted installations (e.g., installations on bridges or buildings) are not included in this document. Consult with a professional, and local and federal standards, before ordering to ensure product is appropriate for the intended purpose and installation location. Refer to the Cooper Lighting Solutions Light Pole White Paper for risk factors and design considerations. Learn more.


NOTE: The Limited Warranty for this product specifically excludes fatigue failure or similar damage resulting from vibration, harmonic oscillation or resonance.

Specifications and dimensions subject to change without notice. Consult your lighting representative at Cooper Lighting Solutinos or visit www.cooperlighting.com for available options, accessories and ordering information.

#### **BASE HEIGHT DIMENSIONS**

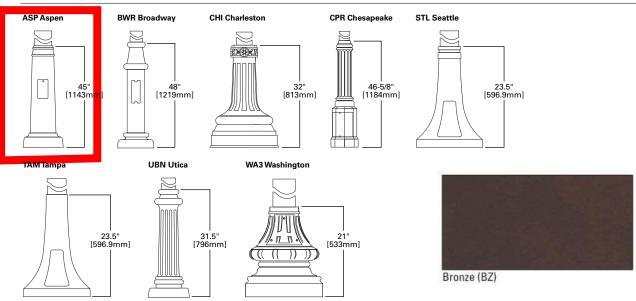

#### ANCHORAGE DATA

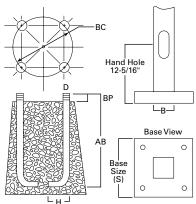

See	technical	information.	

Pole	Anchor Bolt and Template Package	Shaft Diameter (inches)	Bolt Circle (inches)	Number of Bolts	Bolt Size (inches)	Template Only
Aspen (ASP)	317AVE40S	10 x 4	14.19 + - 0.81	4	3/4 x 17	406541D
Broadway (BWR) 1	317RB408	8 x 4	12	4	3/4 x 17	405592D
Broadway (BWR) <sup>2</sup>	436RB408	8 x 4	12	4	1 x 36	227878D
Charleston (CHI)	317RB4HN	4, 5, 6	11.5 + - 1.50	4	3/4 x 17	227095D
Cheasapeake (CPR)	317RB4WI	4, 5	13.25	4	3/4 x 17	227116D
Seattle (STL)	317AVE10	4	9	4	3/4 x 17	407040D
Tampa (TAM)	317AVE30	5 x 4	16	4	3/4 x 17	407040D
Utica (UBN)	317RB4SC	4, 5	12.5	4	3/4 x 17	227314D
Washington (WA3)	317RB4WA	4, 5, 6	11.5 + - 1.50	4	3/4 x 17	227077D

**NOTES: 1.** Anchor bolt set should be for up to 16' mounting height. **2.** Anchor bolt set should be for up to 17' and over mounting height.



#### **DESIGN TEAM/DRB COMMENT SHEET**

The comments below are staff recommendations to the Design Review Board (DRB) and do NOT constitute DRB approval or denial.

PROJECT NAME: Fifteen Wimbledon	DRB#:	DRB-002231-2021			
DATE: 8/22/2023					
RECOMMENDATION: Approval	ions Denial				
MISC COMMENTS & CONDITIONS					
1. The project received Conceptual approval on July 27, 2021.					
2. The project received Final approval with conditions on October 12, 2021					
3. Confirm that all conditions from Final approval have been addressed on current plan.					

#### Final NOA (October 12, 2021) Conditional Comments:

- Add path lights to eastern pedestrian access on sheet L6.2. 2.
- Add 3" Live Oak at the entrance on sheet L4.1. 3.
- Revise the trellis detail on sheet L3.3 to specify concealed electrical conduit.
- Revise the lighting plan to be compliant with the LMO requirements. 5
- Provide an installation detail or plan for the tree and well lights that will not impact tree roots
- An Osprey nest has been confirmed on site. Construction will need to be scheduled around nest activity per DHEC requirements.



#### Town of Hilton Head Island

#### Community Development Department

One Town Center Court Hilton Head Island, SC 29928 Phone: 843-341-4757 Fax: 843-842-8908

www.hiltonheadislandsc.gov

1563-2023
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FOR OFFIC	CIAL USE ONLY
Date Received:	
Accepted by: _	
DRB #:	
Meeting Date:	

Applicant/Agent Name: Beach House Owner Lee Com	npany:
Mailing Address: City:	y: State: Zip:
Telephone: Fax: E-m	nail:
Telephone: Fax: E-m  Project Name: Beach House Renovation Project Ad	ddress: 1 S. Forest Beach
Parcel Number [PIN]: R	
Zoning District: Overlay Di	histrict(s):
Zonnig District.	1301101(3).
CORRIDOR REVIEW	V. MAJOR
DESIGN REVIEW BOARD (DRB) SUB	WIII IAL REQUIREMENTS
D: 1101 1 1 1 1 1 1 1 1 1 1 1 1 1 1 1 1 1	241 4757
Digital Submissions may be accepted via e-mail by calling 843-3	<u>341-4/3/.</u>
Project Category:	
Concept Approval – Proposed Development	Alteration/Addition
Final Approval – Proposed Development (ALL PHASES)	Sign
Submittal Requirements for All projects:	
Private Architectural Review Board (ARB) Notice of Actio jurisdiction of an ARB, the applicant shall submit such AR 2-103.I.4.b.iii.01. Submitting an application to the ARB to applicant.	RB's written notice of action per LMO Section 16-
Filing Fee: Concept Approval-Proposed Development \$175 Alterations/Additions \$100, Signs \$25; cash or check made	
Additional Submittal Requirements:	and the state of t
Concept Approval – Proposed Development	
A survey (1"=30' minimum scale) of property lines, existing	
tree protection regulations of Sec. 16-6-104.C.2, and if app	plicable, location of bordering streets, marshes and
beaches.	":C
A site analysis study to include specimen trees, access, sign views, orientation and other site features that may influence	
A draft written narrative describing the design intent of the	
reflects the site analysis results.	
Context photographs of neighboring uses and architectural	
Conceptual site plan (to scale) showing proposed location of Conceptual sketches of primary exterior elevations showing development, materials, colors, shadow lines and landscapi	g architectural character of the proposed

Additional Submittal Requirements:	
Final Approval – Proposed Development  A final written narrative describing how the project conforms with the conceptual approval and design	
review guidelines of Sec. 16-3-106.F.3.	
Final site development plan meeting the requirements of Appendix D: D-6.F.	
Final site lighting and landscaping plans meeting the requirements of Appendix D: D-6.H and D-6.I.	
Final floor plans and elevation drawings (1/8"=1'-0" minimum scale) showing exterior building materials and	
colors with architectural sections and details to adequately describe the project.	
A color board (11"x17" maximum) containing actual color samples of all exterior finishes, keyed to the elevations, and indicating the manufacturer's name and color designation.	
Any additional information requested by the Design Review Board at the time of concept approval, such as	
scale model or color renderings, that the Board finds necessary in order to act on a final application.	
	ľ
Additional Submittal Requirements: Alterations/Additions	
All of the materials required for final approval of proposed development as listed above, plus the following	ĺ
additional materials.	
A survey (1"=30' minimum scale) of property lines, existing topography and the location of trees meeting the	
tree protection regulations of Sec. 16-6-104.C.2, and if applicable, location of bordering streets, marshes and	
beaches.	
Photographs of existing structure.	
Additional Submittal Requirements:	
Signs	
Accurate color rendering of sign showing dimensions, type of lettering, materials and actual color samples.	
For freestanding signs:	
Site plan (1"=30' minimum scale) showing location of sign in relation to buildings, parking, existing signs,	
and property lines.	
Proposed landscaping plan.	
For wall signs:  Photograph or drawing of the building depicting the proposed location of the sign.	
Location, fixture type, and wattage of any proposed lighting.	
Note: All application items must be received by the deadline date in order to be reviewed by the DRB per LMO Appendix D: D-23.	
A representative for each agenda item is strongly encouraged to attend the meeting.	
Are there recorded private covenants and/or restrictions that are contrary to, conflict with, or prohibit	
the proposed request? If yes, a copy of the private covenants and/or restrictions must be submitted with this application.   YES  NO	
this application. TES	
To the best of my knowledge, the information on this application and all additional documentation is true	٥.
factual, and complete. I hereby agree to abide by all conditions of any approvals granted by the Town of Hilto	
Head Island. I understand that such conditions shall apply to the subject property only and are a right of	ì
obligation transferable by sale.	
I further understand that in the event of a State of Emergency due to a Disaster, the review and approval time	S
set forth in the Land Management Ordinance may be suspended.	
C	
Dartinh LUM DIDIA	
SIGNATURE DATE	

Last Revised 01/21/15



Date: 15 August 2023

To: Town of Hilton Head Island

**Community Development Department** 

One Town Center Court Hilton Head, Island, SC 29928

From: WATG

1730 Flight Way Suite 150 Tustin, CA 92782

Re: Beach House | Hilton Head Island

1 South Forest Beach Drive Hilton Head, SC 29928

#### PROJECT NARRATIVE

**THE HILTON HEAD BEACH HOUSE** property is planning a renovation of the existing pool area, Tiki bar and addition of the event pavilion. The limit of work for the renovation is indicated on the Overall Site Plan and is generally from the facade of the existing hotel and extends to the current DHEC-ORCM setback and baseline as well as the Town of Hilton Head setback and baseline. In addition, the relocation of the restroom, pool equipment room and grill to a location within the Town of HHI setback and baseline to a location no closer to the ocean and is structurally connected to the existing hotel building. The stage will be relocated to the beach side of the Tiki Bar. Improvements include a refresh and update to the spaces, FFE, materials and finishes, and overall quality.

#### **SCOPE OF WORK:**

- New Stage Structure Pavilion
- Expanded Tiki Bar/Structure + Wood Deck
- Gas Tables/Rings
- New Swimming Pool, Spa and Deck
- Pool Cabana Structures (FFE), Service Stations + Pool Furnishings
- New Kitchen + Restroom Building (Structurally connected to the hotel)
- New Restroom Building + Pool Equipment Room + Mech. Space
- New Resort Hardscape & Planting + Irrigation
- Dune Walkover Path
- New Exterior Lighting (Sea Turtle Protection + Code Compliant)
- Additional (3) ADA Compliant Rooms to bring up to current code (Interior Renovation ONLY
- New Event Pavilion with new fencing + maintaining existing fencing
- Demolition as required



#### SPECIFIC RESPONSES TO DRB REVIEW COMMENTS FROM 8-8-23 MEETING:

For Architectural sheets see PDF pages 38 thru 61.

For Landscape sheets see PDF pages 5 thru 37

- 1. Comment: No white trims for lighting.
  - Response: The proposed project light trims and fixture finishes are specified to be 'bronze'. No white or black trims or fixture colors will be used or specified.
- 2. Comment: Extend all overhangs on all buildings to a minimum of 2'.
  - Response: The existing hotel overhangs extend 30" and consist of a flat plaster soffit and angled wood painted facia.
  - a. The proposed kitchen/restroom building has been revised to have 30" overhangs matching the existing building configuration with wood fascia, but using a stained wood soffit material.
  - b. The proposed restroom/pool equipment building has been revised to have 30" overhangs matching the existing building configuration with wood fascia and plaster soffit matching the existing conditions it connects to.
  - c. For the Event Pavilion, the upper roof overhang has been increased to 32", and the lower roof eaves have been increased to 45".
  - d. For the Tiki bar addition and Tiki Stage, the design and overhangs will match the existing structure.
- 3. Comment: Consider tabby or shell instead of concrete at base of pavilion columns and any other concrete features along buildings.
  - Response: The base for the Pavilion columns has been studied and the previous detail concept adjusted in width...see revised elevations and details. A tan/earth toned Tabby-Shell finish has been specified for the base, with a natural matching Limestone cap.
- 4. Comment: Provide detailed landscape plans.
  - Response: See updated Landscape Plans indicating hardscape, irrigation, and planting layouts.
- 5. Comment: Provide hardscape details, materials, and colors for new fences, gates, cabanas, etc. Response: See updated details in the Landscape Plans for built landscape structures. Please refer to the material schedule for selections and hardscape color and finish reference sheet. The black fence has been replaced with a matt bronze finish. See sheet A9.05 for typical stair detail.
- 6. Comment: Elaborate on palm lighting, quantity, lumens, etc. Elaborate on height of lights. Lights should not be higher than 15' above ground.
  - Response: All landscape lighting is specified at 12' above grade and below 15'. See revised lighting plans provided and comments/notes shown in the landscape plans. We have reduced the tree rings as requested but have kept them in locations where we need downlights in lieu of pole mounted fixtures. The specified palm tree ring is one that we have used on many projects in commercial resort environments with success.
- 7. Comment: Update detail on pavilions gables and louvers. Recommended to have a more Low country feel.
  - Response: The gable ends of the pavilion were studied. To further the low-country aesthetic identified as inspiration, additional vertical trim was added to break up the horizontal louvers to achieve a more traditional style. See revised elevations.





- 8. Comment: Update column plates to either match Celebration Park or to not allow for trash/debris in center of columns.
  - Response: We studied the base detail. The S.S. base detail was refined to be "lighter" in feel with more finesse on the strapping and mounting. Additionally, a block added to the center of the (4) posts at the base to advert any trash build-up.
- 9. Comment: Consider gutters or provide notes for drip line and drainage in pavilion area. Response: We have detailed a gutter along the pedestrian path (south side) of the pavilion. The gutter profile is shown on the detail section with notes.
- 10. Comment: Add call outs in pavilion for lighting, fans, string lights, etc. and ensure close discrete conduits.

Response: See the submitted RCP's for each project component for clear references to the proposed lighting. Each fixture is identified with a symbol and reference number and called out as "typical". An image of the fixture has been added to the sheets accordingly for reference (full lighting plans are provided as well, but for ease, see the architects RCP's for each component). We have selected up to (4) internal columns to "box" out the center to bring up necessary conduits from below grade. Refer to the enlarged base details for reference. This will allow conduits to be concealed up to the lower roof. Once to the lower roof, most conduits can run on top of the beams. Where not possible, they will be located in the inside corners of beams to ceiling material and painted to match the wood color. The sconces will back up to round shallow depth 'j' boxes, which are painted to match the fixture, and set to blocking. The conduits are nearly all concealed.

Conduits will be concealed as much a feasible, and where exposed, painted to match the adjacent material.

#### ADDITIONAL RESPONSES AND CLARIFICATIONS FOR THE DRB:

- 1. Note: All exposed wood for the Event Pavilion is specified to be Southern Yellow Pine-S4S-select grade with a penetrating sealer/stain. Cedar will not be utilized in any component of the structure.
- 2. Note: All exposed wood for the Tiki Bar Structure (except the structural round columns) are specified to be Southern Yellow Pine-rough sawn-select grade with a penetrating clear sealer. These are not pressure treated.
  - The round structural columns receive a penetrating wood sealer/preservative.
- 3. Note: The pavilion roof details have been cleaned up to clearly indicate ½" ext. grade plywood over exposed 2x6 T&G ceiling material. The fasteners of the standing seam roof will not penetrate through and will not be exposed.
- 4. Note: The architectural plans/elevations include detailed keynotes. The keynotes reference the finish materials and colors.
- 5. Note: A materials board will be brought to the DRB meeting for review.

Respectfully,





Lance Kalani Walker, ASLA

**Gregory Villegas, AIA** 

Vice President + Director of Landscape Architecture

Wimberly Allison Tong + Goo NA Inc.

Respectfully,

Vice President + Director of Construction & Full Services

Wimberly Allison Tong + Goo NA Inc.



# Beach House

# HILTON HEAD ISLAND

# HILTON HEAD BEACH HOUSE RENOVATION

1 SOUTH FOREST BEACH DRIVE, SC 29928 ADA GUESTROOMS, POOL, POOL BAR & AMENITY DECK TENANT IMPROVEMENT

DRB RESUBMISSION SET | 08.15.2023 | NOT FOR CONSTRUCTION



WATG

strategy planning architecture landscape interi



consultant

no. date issue

Beach House
HILTON HEAD ISLAND

1 SOUTH FOREST BEACH DRI' HILTON HEAD, SC 29928 project logo

COVER SHEET sheet title

project no. 212041 da checked by: LKW / JHC

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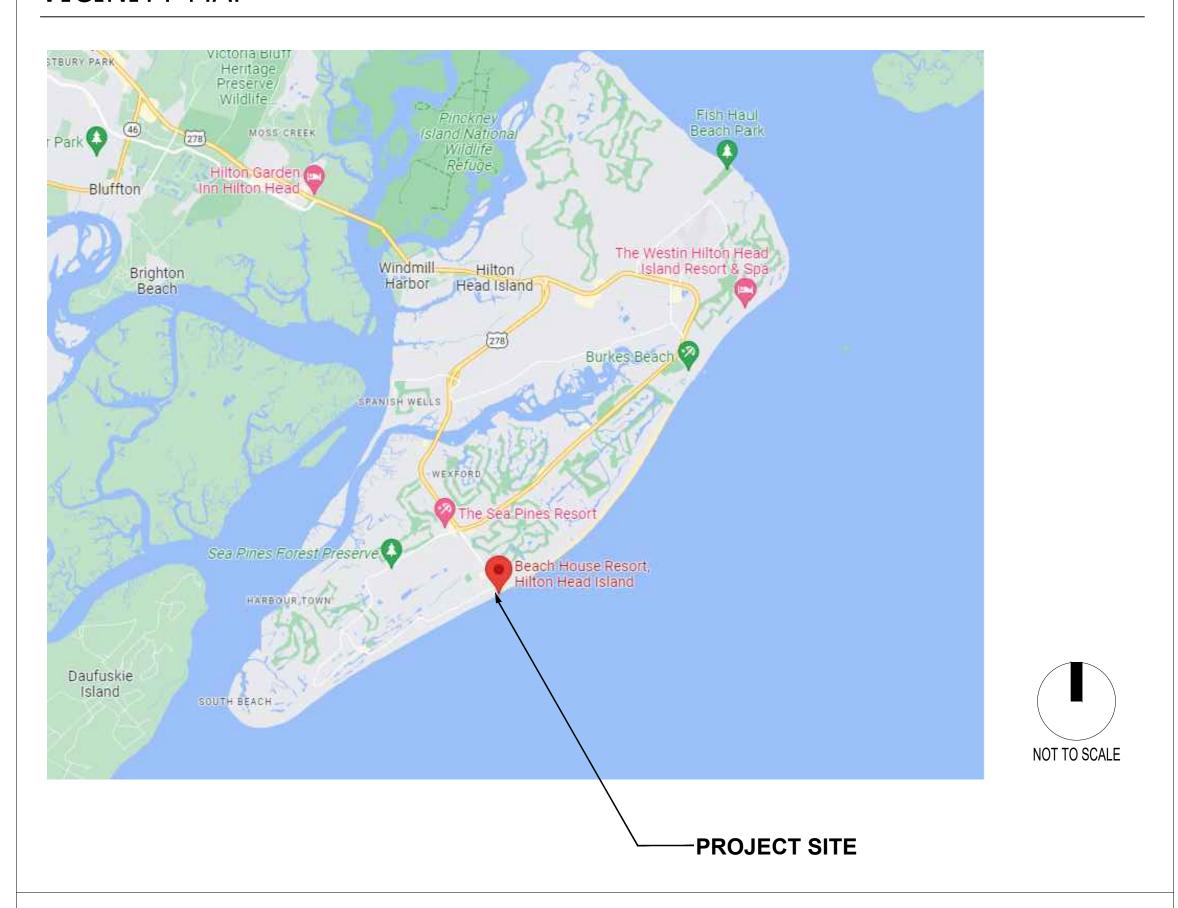
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VEHICULAR

VERIFY IN FIELD

VEH.

#### VICINITY MAP



#### KEY MAP



#### PROJECT DIRECTORY

**CLIENT** LANDSCAPE ARCHITECT RED HOSPITALITY NEW YORK, NY 32801 1730 FLIGHT WAY, SUITE 150 JILL LEKSTUTIS TUSTIN, CA 92782 516.459.4694 LANCE KALANI WALKER JLEKSTUTIS@REDHOSPITALITY.COM 949.574.8500

**ARCHITECT** 

WWW.REDHOSPITALITY.COM

**CIVIL ENGINEER** ROBERTS CIVIL ENGINEERING 1730 FLIGHT WAY, SUITE 150 1043 E MONTAGUE AVENUE, SUITE 102 **TUSTIN, CA 92782** NORTH CHARLESTON, SC 29405 **GREG VILLEGAS** JESSICA VICK , PE 912.298.7006 949.574.8500 GVILLEGAS@WATG.COM JVICK@ROBERTSCIVILENGINEERING.COM

**INTERIOR DESIGN** WIMBERLY INTERIORS 75 SPRING STREET, SUITE 700 NEW YORK, NY 10012 USA JOSH HELD 212.274.2626 JHELD@WATG.COM

**IRRIGATION** ACI IRRIGATION 1217 ALTA VISTA DRIVE VISTA, CA 92084 SCOTT LINDER 760.505.3552 SCOTT@ACI-IRRIGATION.COM

LWALKER@WATG.COM

**LIGHTING DESIGN** FIRST CIRCLE DESIGN 3187 AIRWAY AVE | BLDG. C, COSTA MESA, CA 92626 MATT LEVESQUE 949.681.0500 MATT@FIRSTCIRCLEDESIGN.COM

**POOL & SPA** HOLDENWATER ARCHITECTURE P.O. BOX 7080, FULLERTON, CA 92834 MARK HOLDEN / RICHARD CEJA 714.626.0333 MARK@WATERARCHITECTURE.COM RICHARD@WATERARCHITECTURE.COM

#### MECHANICAL / ELECTRICAL / PLUMBING ENGINEER

241 NORTH BROADWAY, SUITE 203 MILWAUKEE, WI 53202 TYLER MALZAHN 414.517.2577 TYLER.MALZAHN@EXP.COM

#### STRUCTURAL ENGINEER

JOHN A. MARTIN & ASSOCIATES, INC. 950 SOUTH GRAND AV. SUITE 400 LOS ANGELES, CA 90015 GREG OROZCO 213.785.3187 GOROZCO@JOHNMARTIN.COM

#### **ARBORIST**

JONES BROTHERS TREE SURGEONS 374 SPANISH WELLS RD #L HILTON HEAD ISLAND, SC 29926 JAMES ELLIS, ISA CERTIFIED ARBORIST 843.842.4686

#### **FOOD SERVICE** SAM TELL COMPANIES

36 E 31ST STREET, 6TH FLOOR NEW YORK, NY, 10016 JERRY KOUVERAS 917.642.9379 JKOUVERAS@SAMTELL.COM

#### **GENERAL CONTRACTOR**

NIX CONSTRUCTION 2 CORPUS CHRISTIE PLACE, SUITE 203 HILTON HEAD ISLAND, SC 29928 JOE NIX, PRESIDENT 843.683.3344 JOENIX@NIXCONSTRUCTION.COM

#### GEOTECHNICAL ENGINEER POOL CONTRACTOR

379 BROWN COVE ROAD, SUITE C RIDGELAND, SC 29936 KYLE NICHOLSON, E.I.T. 843.258.7070 KYLE.NICHOLSON@TERRACON.COM

YEAR ROUND POOL 29 MATHEWS DRIVE HILTON HEAD ISLAND, SC 29926 FRANK X. FOTIA III 843.837.7665 ext. 104 FRANK.FOTIA@YEARROUNDPOOL.COM

#### SHEET INDEX

SHEET NO. SHEET NAME

L0-000 L0-001 L0-002	
L3-001 L3-002 L3-003	HARDSCAPE SCHEDULE AND NOTES HARDSCAPE IMAGERY MATERIALS & FINISHES HARDSCAPE IMAGERY MATERIALS & FINISHES
L3-101	OVERALL HARDSCAPE PLAN
L3-201 L3-202 L3-203 L3-204	HARDSCAPE ENLARGEMENT PLAN - POOL DECK HARDSCAPE ENLARGEMENT PLAN - TIKI BAR AREA FURNITURE LAYOUT ENLARGEMENT PLAN - POOL DECK FURNITURE LAYOUT ENLARGEMENT PLAN - TIKI BAR AREA
L3-401 L3-402 L3-403 L3-404 L3-405	HARDSCAPE DETAILS HARDSCAPE DETAILS HARDSCAPE DETAILS HARDSCAPE DETAILS HARDSCAPE DETAILS
L4-001	IRRIGATION SCHEDULE NOTES
L4-101	IRRIGATION PLAN
L4-401 L4-402	IRRIGATION DETAILS IRRIGATION DETAILS
L5-001 L5-002 L5-003	PLANTING SCHEDULE & NOTES PLANTING IMAGERY PLANTING IMAGERY
L5-101 L5-102	OVERALL TREE PLAN OVERALL SHRUB PLAN
L5-201 L5-202 L5-203 L5-204	TREE ENLARGEMENT PLANTING PLAN - POOL DECK TREE ENLARGEMENT PLANTING PLAN - TIKI BAR AREA TREE ENLARGEMENT PLANTING PLAN - PARKING AREA TREE ENLARGEMENT PLANTING PLAN - PORTE COCHERE
L5-205 L5-206 L5-207	SHRUB ENLARGEMENT PLANTING PLAN - POOL DECK SHRUB ENLARGEMENT PLANTING PLAN - TIKI BAR AREA SHRUB ENLARGEMENT PLANTING PLAN - PARKING AREA

PLANTING DETAILS

L5-401


## WATG

strategy planning architecture landscape interiors

- CONSULTING -

consultant

stamp | approval

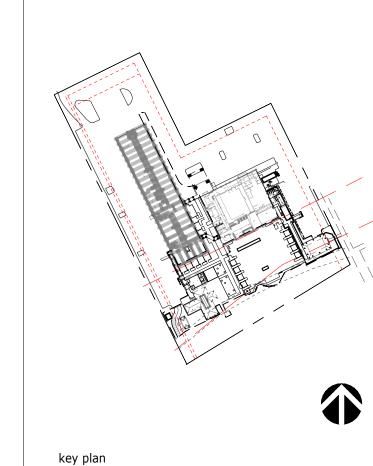

no. date issues | revisions

# HILTON HEAD ISLAND

1 SOUTH FOREST BEACH DRIVE HILTON HEAD, SC 29928 project logo

PROJECT INFORMATION

& SHEET INDEX sheet title project no. 212041 date 08/15/23

checked by:

drawn by: FCVA

ADDITIONAL ABBREVIATIONS

ASPHALT CONCRETE AIR CONDENSER AREA DRAIN AMERICAN WITH DISABILITES ACT **ALIGN** ALIGNMENT **APPROX** APPROXIMATE ARCHITECT(URAL) BEGINNING CURVE RADIUS BOTTOM OF FENCE BASE LINE BENCHMARK BACK OF CURB BOTTOM OF PIPE **BOTTOM OF RAMP** BOTTOM OF SLOPE BOTTOM BOTTOM OF STEP BEGINNING OF VERTICAL CURVE **BOTTOM OF WALL** CRUSHED AGGREGATE BASE CATCH BASIN CUBIC FEET PER SECOND CFS

CAST-IN-PLACE

CLEARANCE

CONTRACTION JOINT

CRUSHED MISCELLANEOUS BASE

CORRUGATED METAL PIPE

CJ

CMU CONCRETE MASONRY UNIT CO CLEANOUT CONC CONCRETE **CONT** CONTINUOUS DOWELED CONSTRUCTION JOINT

**DET** DETAIL

FG FINISH GRADE

**FH** FIRE HYDRANT

**DI** DRAIN INLET

**DIAG** DIAGONAL **DIM** DIMENSION **DWG** DRAWING EXISTING **EA** EACH **ECR** END CURVE RADIUS **EIFS** EXTERIOR INSULATION AND FINISH SYSTEM **EL** ELEVATION **ELEC** ELECTRICAL

**ENCL** ENCLOSURE **EVC** END VERTICAL CURVE **EW** EACH WAY **EWWM** ELECTRICALLY WELDED WIRE MESH **EX** EXISTING **FD** FLOOR DRAIN FDN FOUNDATION **FF** FINISH FLOOR **FFE** FINISH FLOOR ELEVATION

MFG MANUFACTURER MH MANHOLE MISC MISCELLANEOUS **FOB** FACE OF BUILDING **FOC** FACE OF CURB FACE OF FINISH NOT IN CONTRACT NUMBER FINISH SURFACE NOM NOMINAL

FLOW LINE

**FOW** FACE OF WALL

GAUGE

GRADE

**HC** HANDICAP

HDR HEADER

**INV** INVERT

**LF** LINEAR FEET

**LP** LOW POINT

MED MEDIUM

MET METAL

MECH MECHANICAL

**JT** JOINT

HORIZ HORIZONTAL

**HP** HIGH POINT

GV

GALVANIZED

**GRID ORIGIN** 

GATE VALVE

INSIDE DIAMETER

ISOLATION JOINT

GRADE BRAKE

GENERAL CONTRACTOR

FACE OF STEP

**OCEW** ON CENTER EACH WAY **OD** OUTSIDE DIAMETER OE OR EQUAL **OPG** OPENING **OPP** OPPOSITE POINT OF INTERSECTION PROTECT IN PLACE **POC** POINT OF CONNECTION

**REV** REVISION

**RP** RADIUS POINT

PREP PREPARATION **PVC** POLY VINYL CHLORIDE **PVMT** PAVEMENT R RADIUS RCP REINFORCED CONCRETE PIPE **RD** ROOF DRAIN **RE** RIM ELEVATION **RECPT** RECEPTACLE **REF** REFERENCE **REINF** REINFORCED **REQ** REQUIRED

TC TOP OF CURB **TOB** TOP OF BEAM **TOC** TOP OF CAP **TOS** TOP OF SLOPE **TD** TOP OF DRAIN **TF** TOP OF FENCE **TOR** TOP OF RAMP **TS** TOP OF STEP **UNO** UNLESS NOTED OTHERWISE V VERTICAL **VERT** VERTICAL **W** WEST **W**/ WITH W/O WITHOUT **WP** WATERPROOF WS WATER SURFACE

SCH SCHEDULE

SHEET

**SPEC** SPECIFICATION

SIM SIMILAR

**SQ** SQUARE

**STA** STATION

STL STEEL

**STD** STANDARD

STRUC STRUCTURAL

SQUARE FEET

SCO SEWER CLEAN OUT

SS STAINLESS STEEL

INDICATES SECTION LETTER INDICATES SECTION SHEET NUMBER INDICATES ELEVATION LETTER INDICATES ELEVATION SHEET NUMBER INDICATES ENLARGEMENT NUMBER ENLARGEMENT NAME/DESCRIPTION

NOT TO SCALE

—-—- ⇔ CENTER LINE —--— ⊶ PROPERTY LINE PLANTING AREA ---- ISOLATION JOINT CONTRACTION JOINT - - - - LIMIT OF WORK LINE **MATCHLINE** ALIGN POINT OF BEGINNING/ORIGIN POINT OF LAYOUT

SYMBOL LEGEND


INDICATES ENLARGEMENT SHEET NUMBER

SHEET LEGEND

0 - GENERAL 1 - DEMOLITION 2 - GRADING 3 - HARDSCAPE 4 - IRRIGATION 5 - PLANTING 6 - SITE LIGHTING 7 - SITE FURNISHINGS SHEET SEQUENCE NUMBER THIRD CHARACTER GROUP 0 - GENERAL 1 - PLANS 2 - ENLARGEMENTS 3 - PAVING ENLARGEMENTS 4 - DETAILS 5 - DIAGRAMS 6 - 3D REPRESENTATIONS

DISCIPLINE PREFIX

SECOND CHARACTER GROUP

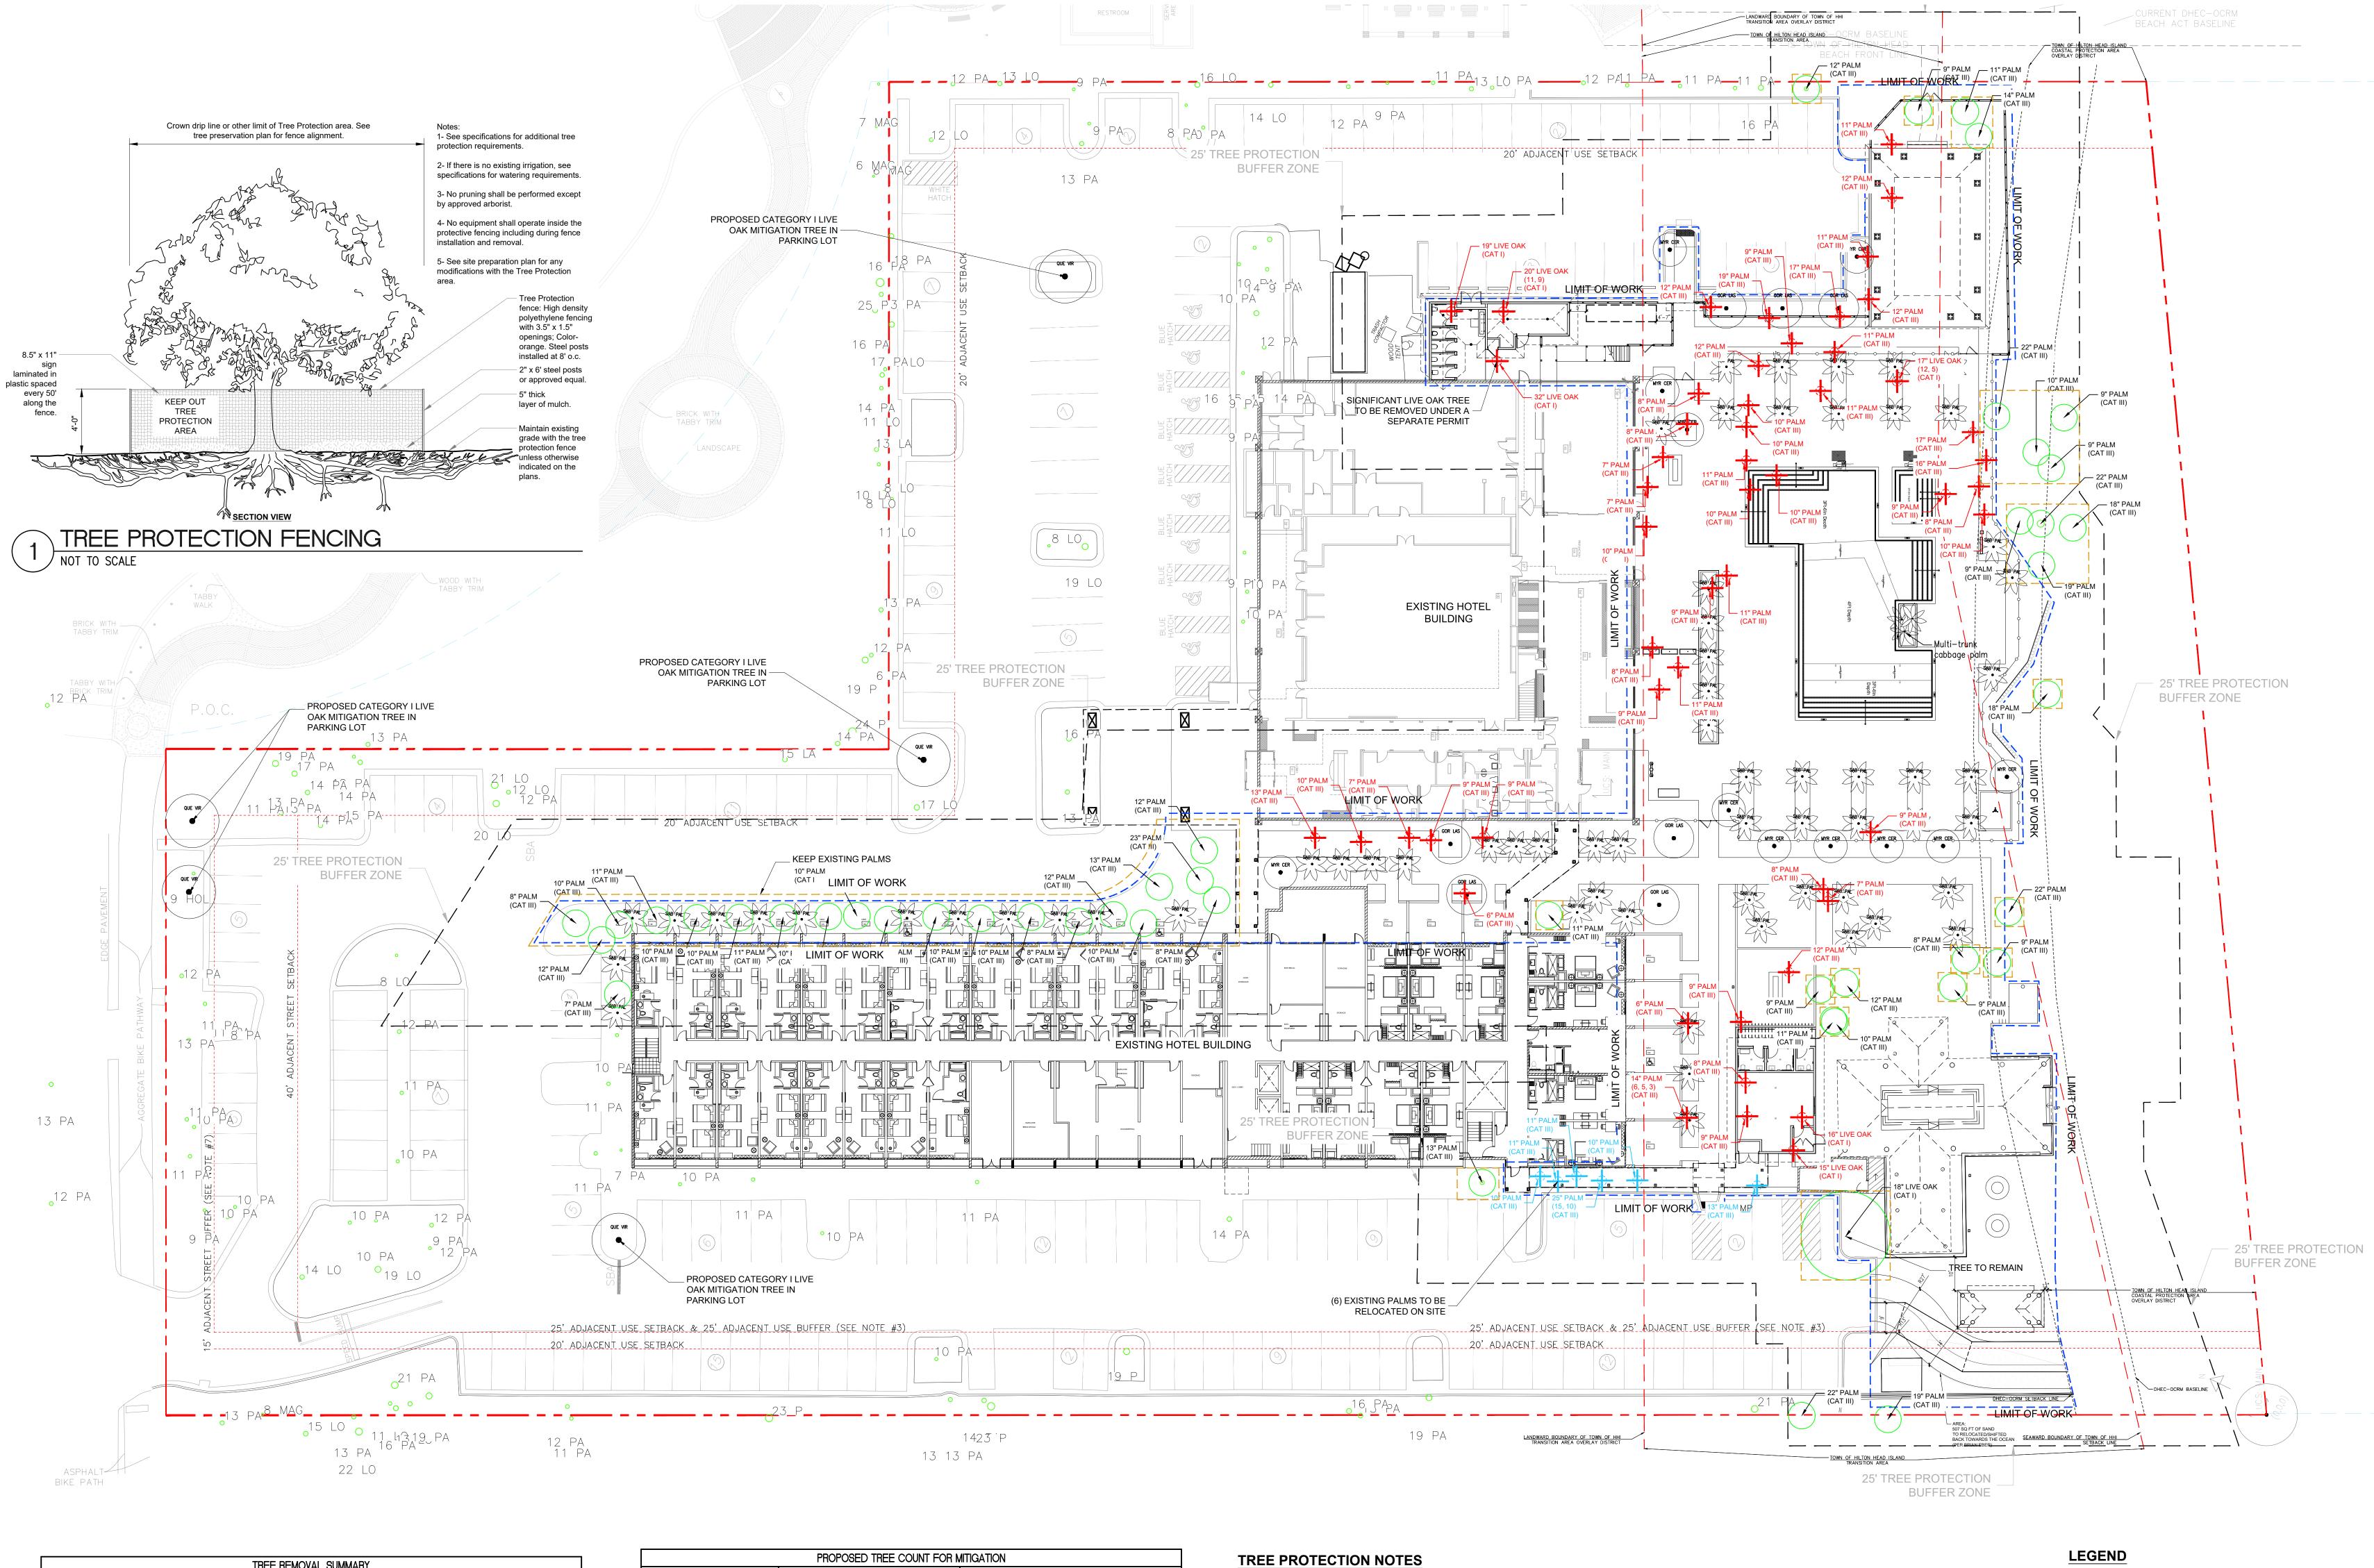

		THEE HEIMOVAL SUMIN	IANI	
CATEGORY	TREE SPECIES QUANTITY TOTAL D		TOTAL DBH (IN)	# OF REPLACEMENT TREE REQUIRED
I	LIVE OAK	6	119	12
III	PALM	45	472	48
	DETAILED TREE REMO	VAL TALLY		
LIVE OAK TREES T	O BE REMOVED:	ALM TREES TO BE F	REMOVED:	

DETAILED TREE REMOVAL TALLY									
TO BE REMOVED:	PALM TREES TO BE REMOVED								
COUNT	DBH OF TREE	COUNT							
1	6" PALM:	2							
1	7" PALM:	4							
1	8" PALM:	6							
1	9" PALM:	8							
1	10" PALM:	7							
1	11" PALM:	7							
	12" PALM:	5							
	13" PALM:	1							
	14" PALM:	1							
	16" PALM:	1							
	17" PALM:	2							
	19" PALM:	1							
6	TOTAL:	45							
	COUNT  1  1  1  1  1  1  1	TO BE REMOVED: PALM TREES TO  COUNT DBH OF TREE  1 6" PALM: 1 7" PALM: 1 8" PALM: 1 9" PALM: 1 10" PALM: 1 12" PALM: 12" PALM: 13" PALM: 14" PALM: 16" PALM: 17" PALM:							


PROPOSED TREE COUNT FOR MITIGATION									
CATEGORY	TREE SPECIES	# OF TREE PROPOSED							
I	LIVE OAK								
I	LOBLOLLY BAY								
TOTAL NUMB	ER OF CATEGORY I REPLACEMENT TREE:	1							
III	PALM	(							
TOTAL NUMBE	R OF CATEGORY III REPLACEMENT TREE:								


#### TREE MITIGATION NOTES:

- 1. TREES THAT ARE REMOVED SHALL BE REPLACED AT THE RATE OF ONE TREE FOR EVERY TEN
- TREE INCHES REMOVED PER TREE CATEGORY. 2. SUPPLEMENTAL AND REPLACEMENT TREES SHALL BE WITHIN THE SAME OR LOWER-NUMBERED TREE CATEGORY AS THE TREES BEING REPLACED.
- 3. CATEGORY I REPLACEMENT TREE SHOULD HAVE A MINIMUM TRUNK DIAMETER OF 2 INCHES AND A MINIMUM HEIGHT OF 10 FT. CATEGORY III REPLACEMENT TREE SHOULD HAVE A MINIMUM TRUNK DIAMETER OF 1 INCH AND A MINIMUM HEIGHT OF 6FT.
- 4. REFER TO PLANTING SCHEDULE AND TREE PLAN FOR COMPREHENSIVE PROPOSED TREE PLANTING.

#### TREE PROTECTION NOTES

- TREE PROTECTION FENCING & EROSION CONTROL MEASURES SHALL REMAIN IN PLACE THROUGHOUT THE DURATION OF
- CONSTRUCTION. 2. REFER TO CIVIL PLANS FOR EROSION CONTROL MEASURES
- 3. EROSION CONTROL AND TREE FENCING ARE TO BE IN PLACE AND APPROVED BY THE TOWN OF HILTON HEAD PRIOR TO ANY TREE CLEARING OR SITE DEMOLITION / CONSTRUCTION.
- 4. BEFORE ANY DEMOLITION, UNDERBURSHING, CLEARING, TREE REMOVAL, SOIL REMOVIAL OR ANY OTHER SITE WORK BEGINS, TOWN
- STAFF MUST INSPECT THE SITE TO ENSURE ALL REQUIRED EROSION CONTROL / TREE PROTECTION MEASURES ARE INSTALLED.
- 5. CONTACT THE TOWN'S MANAGER TO SCHEDULE PRE-CLEAR INSPECTION.
- 6. WARNING SIGNS SHALL BE INSTALLED ALONG ANY REQUIRED TREE PROTECTIVE FENCING AT POINTS NO MORE THAN 150 FEET APART. THE SIGNS SHALL BE CLEARLY VISIBLE FROM ALL SIDES OF THE OUTSIDE OF THE FENCED-IN AREA. THE SIZE OF EACH SIGN MUST BE A MINIMUM OF TWO FEET BY TWO FEET. THE SIGN MESSAGE SHALL IDENTIFY THE FENCED OR MARKED AREA AS A TREE PROTECTION ZONE AND DIRECT CONSTRUCTION WORKERS NOT TO ENCROACH INTO THE AREA (E.G., "TREE PROTECTION ZONE: DO NOT ENTER"). SEE FIGURE 16-6-104.J.2: TREE PROTECTIVE FENCING AND SIGNAGE.

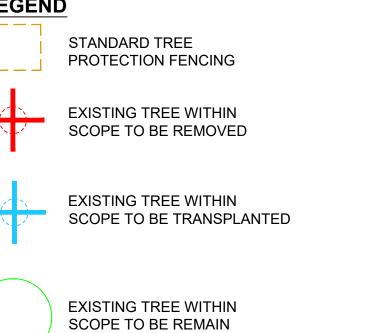

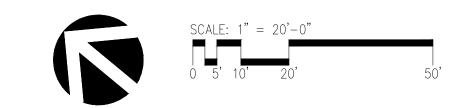


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HILTON HEAD ISLAND 1 SOUTH FOREST BEACH DRIVE

TREE REMOVAL &

HILTON HEAD, SC 29928

PROTECTION PLAN

#### GENERAL HARDSCAPE NOTES

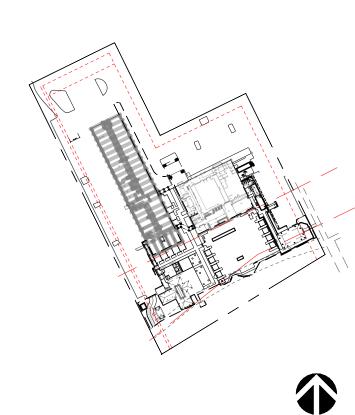- 1. Conform work to requirements of latest adopted edition of uniform building code and applicable local and state codes, plans, specifications, ordinances and regulations.
- 2. Prior to beginning work, become familiar with existing site conditions, including underground utilities, and above grade features such as grading, walls, fences, structures, etc. Contractor will be held responsible for his own damage.
- 3. Upon being awarded contract, make necessary arrangements to insure that materials, supplies, and manpower will be available when needed to construct this project in an orderly and timely fashion.
- 4. Do not begin work until contractor's "construction set" drawings are current and have required pubic agency approvals.
- 5. Verify property lines, easements, flood zone lines, coastal setbacks and baselines, buffer zones, and limits of work prior to commencing work.
- 6. Refer to project specifications for additional information.
- 7. Obtain necessary permits and pay for related inspection fees required to install work.
- 8. Written dimensions take precedence over scaling of drawings.
- Where conflicts occur between drawings and actual field conditions, notify owner's authorized representative immediately for clarification. Failure to provide notification may hold contractor liable for costs incurred to rectify problem, if required.
- 10. Prior to installing paving, refer to the project's geotechnical report. Provide notification of any discrepancies between the geotechnical report's recommendations and information noted in the hardscape schedules.
- 11. Do not willfully proceed with construction operations when it is obvious that unknown obstructions and grade differences exist that may not have been known during the design process. Immediately bring these conditions to the attention of owner's authorized representative for resolution. Assume full responsibility for costs incurred and required modifications due to lack of providing such notification.
- 12. Be responsible for coordinating work with owner, owner's authorized representative, general contractor and his sub-contractors, public agencies, and project design consultants.
- 13. Ensure that rough grade has been accepted by owner prior to beginning work.
- 14. Ensure that fine grades have been established correctly and approved by owner's authorized representative prior to beginning hardscape work.
- 15. Provide the following grade drops from paving finish surface: turf areas 1 inch, ground cover and shrub areas 2 inches.
- 16. Ensure that contractor-installed underground elements such as drain lines, irrigation main lines and laterals, electrical conduit, sleeves, etc. Are in place, operational, and approved by public agency inspection prior to installation of hardscape work.
- 17. Paving mock-ups are required on this project refer to paving schedule and specifications for additional information.
- Ensure that curved edges such as walkways, headerboard, and mowstrips have smooth and continuous curves.
- 19. Notify owner's authorized representative with proper lead time, as indicated in specifications prior to a contractor-requested site meeting. Failure to provide appropriate lead time may result in contractor being backcharged for owner's authorized representative's time and expenses.
- 20. Refer to Civil Engineer's drawings for precise grading, step quantities, and drainage
- 21. Dimensions are to the face of walls and other finish surfaces, unless otherwise indicated.
- 22. Provide isolation joints where paving abuts vertical edges such as walls, steps,

#### PAVING SCHEDULE

KEY	DESCRIPTION	DETAIL	COLOR	FINISH	PATTERN	MANUF.	REMARKS
P-1	NOT USED	-	-	-	-	-	-
P-2	PERMEABLE CONCRETE PAVER	L3-401 DET.1	M1914	-	PER PLAN	HANOVER CONTACT: TYLER HAGARMAN 1-717-524-6440	STRUCTURAL REINFORCEMENT AND SUBBASE PER REQUIREMEN OF GEOTECHNICAL SOILS REPORT AND STRUCTURAL ENGINEER INSTALL PER MANUFACTURER'S SPECIFICATIONS AND RECOMMENDATIONS.
P-3	WOOD DECK AT POOL DECK (SHOWER & FOOTWASH)	L3-405 DET.2	CLEAR COAT NATURAL	CUMARU WOOD	PER PLAN	ADVANTAGE LUMBER CONTACT: CRAIG MCCALL 1-877-232-3915	5/4 x 6, TO MATCH ARCHITECTURAL WOOD DECK MATERIALS & FINISHES.  SEE STRUCTURAL ENGINEERING DRAWINGS. WATER SEALANT: TBD
P-4	STABILIZED OYSTER SHELLS	L3-401 DET.3	-	-	PER PLAN	SHELL-SCAPES CONTACT: MARK SOIBOIL 1-253-670-9948	CRUSHED OYSTER SHELLS SIZE: 3/4" MINUS. INSTALL PER MANUFACTURER'S SPECIFICATIONS AND RECOMMENDATIONS.
P-5	DETECTABLE WARNING PAVER	L3-401 DET.6	CHARCOAL	-	PER PLAN	HANOVER CONTACT: TYLER HAGARMAN 1-717-524-6440	STRUCTURAL REINFORCEMENT AND SUBBASE PER REQUIREMEN OF GEOTECHNICAL SOILS REPORT AND STRUCTURAL ENGINEER INSTALL PER MANUFACTURER'S SPECIFICATIONS AND RECOMMENDATIONS.
P-6	PIP CONCRETE HEADER WITH INTEGRATED TABBY	L3-401 DET.2	NATURAL	TOPCAST #3	PER PLAN	-	STRUCTURAL REINFORCEMENT AND SUBBASE PER REQUIREMEN OF GEOTECHNICAL SOILS REPORT AND STRUCTURAL ENGINEER
P-7	PRE-CAST CONCRETE CURB	L3-401 DET.5	M1914	-	PER PLAN	HANOVER CONTACT: TYLER HAGARMAN 1-717-524-6440	STRUCTURAL REINFORCEMENT AND SUBBASE PER REQUIREMEN OF GEOTECHNICAL SOILS REPORT AND STRUCTURAL ENGINEER INSTALL PER MANUFACTURER'S SPECIFICATIONS AND RECOMMENDATIONS.
P-8	STEEL EDGING	L3-401 DET.7	BROWN	_	-	JD RUSSEL COMPANY +1 270.826.7008 WWW.JDRUSSELCO.COM	1/4" THICK X 8" DEPTH, INSTALL PER DETAIL AND MANUFACTURE RECOMMENDATIONS.
P-9	SYNTHETIC TURF	PER MANUF.	FIELD GREEN	_	SHAPE: OMEGA	SYNLAWN CONTACT: +1 866.796.5296 WWW.SYNLAWN.COM	"MODEL: SYNLAWN PLAY PLATINUM" ADA COMPLIANT SYNTHETIC TURF. INSTALLATION PER MANUFACTURER

## FENCE/GATE/RAIL SCHEDULE

KEY	DESCRIPTION	DETAIL	COLOR	FINISH	MANUF.	REMARKS
F-1	ALUMINUM POOL ENCLOSURE FENCE	L3-403 DET.2	MATTE BRONZE	POWDER COAT PAINT FINISH AAMA-2604 COMPLIANT	iFENCE USA CONTACT: MITCH +1-517-803-1375	iFENCE USA "SAN MARINO MODEL" COMMERCIAL-1 PREMIER GRADE INSTALL PER DETAIL & MANUFACTURER SPECIFICATIONS. PROVIDE SHOP DRAWING FOR REVIEW AND APPROVAL.
F-2	CABLE RAIL FENCE	L3-402	CLEAR COAT NATURAL ALTERNATIVE: S. YELLOW PINE	CUMARU WOOD ALTERNATIVE: STAINED		MATCH ARCHITECTURAL WOOD RAILING MATERIALS
[   -2	• CABLE	DET.1	STAINLESS STEEL	CLEAR COAT	-	& FINISHES
F-3	GUESTROOM PATIO FENCE  • 6' HIGH  • 3'-4 3/4" HIGH	L3-402 DET.3	TO MATCH ARCHITECTURE	TO MATCH ARCHITECTURE	-	COLOR TO MATCH ARCHITECTURAL SIDINGS AT TIKI BAR.
G-1	ALUMINUM POOL GATE	L3-403 DET.1	MATTE BRONZE	POWDER COAT PAINT FINISH AAMA-2604 COMPLIANT	iFENCE USA CONTACT: MITCH +1-517-803-1375	iFENCE USA "SAN MARINO MODEL" COMMERCIAL-1 PREMIER GRADE INSTALL PER DETAIL & MANUFACTURER SPECIFICATIONS. PROVIDE SHOP DRAWING FOR REVIEW AND APPROVAL.
G-2	WOOD FENCE GATE	L3-402	CLEAR COAT NATURAL	CUMARU WOOD	ADVANTAGE LUMBER CONTACT: CRAIG MCCALL	COLOR TO MATCH ARCHITECTURAL SIDINGS AT
ر کا		DET.2	ALTERNATIVE: SOUTHERN YELLOW PINE	ALTERNATIVE: STAINED	1-877-232-3915	EVENT PAVILION.
G-3	NOT USED	-	-	-	-	-
R-1	NOT USED	-	-	-	-	-
R-2	TUBULAR STAINLESS STEEL POOL HANDRAILS	PER MANUF.	NATURAL	MATTE FINISH	S.R. SMITH ART-1105 ARTISAN SERIES RAIL	INSTALL PER MANUFACTURER'S DETAILS AND SPECIFICATIONS. PROVIDE SHOP DRAWING FOR REVIEW AND APPROVAL.
R-3	DUNE WALL CLADDING	L3-405 DET.4	SOUTHERN YELLOW PINE	TO MATCH EXISTING	-	-

## SITE ELEMENT SCHEDULE

KEY	DESCRIPTION	DETAIL	COLOR	FINISH	MANUF.	MODEL #	REMARKS
S-1	RECTANGULAR CONCRETE FIRE PIT	L3-404 DET. 1	ALABASTER	STANDARD	ERNSDORF SETH ERNSDORF +1 818-805-3825	-	SEE DETAIL. PER MANUFACTURER'S SPECIFICATIONS AND RECOMMENDATIONS. PROVIDE SHOP DRAWINGS FOR REVIEW AND APPROVAL.
S-2	CIRCULAR CONCRETE BOWL FIRE PIT	L3-404 DET. 2	ALABASTER	STANDARD	ERNSDORF SETH ERNSDORF +1 818-805-3825		SEE DETAIL. PER MANUFACTURER'S SPECIFICATIONS AND RECOMMENDATIONS. PROVIDE SHOP DRAWINGS FOR REVIEW AND APPROVAL.
S-5	OUTDOOR SHOWER	1 2 10 1	STAINLESS STEEL CHROME PLATED BRASS		OUTDOOR SHOWER CO. EMILY DAVISON +1 678-363-3939	PS-3300 -3X-ADA	MARINE GRADE STAINLESS STEEL 316 WITH TEAK HANDLE INSTALL PER MANUFACTURER'S DETAIL. PROVIDE SHOP DRAWING FOR REVIEW AND APPROVAL.
S-6	PLANTER BOX	PER MANUF.	DUNE	SANDBLAST	KORNEGAY DESIGN	SS-15	PER MANUFACTURER'S SPECIFICATIONS AND RECOMMENDATIONS. PLEASE PROVIDE SHOP DRAWINGS FOR REVIEW AND APPROVAL.
S-7	POOL CABANA	L3-402 DET. 5	PAVILION L FRAME: SAND DUNE	STANDARD	KETTAL ILLIANNA PONTE +1 786.552.9002	PAVILION L	ALUMINUM CANOPY WITH MINIDOTS - REF KS9701100 ALUMINUM HORIZONTAL SIDE PANELS - REF KS9702800 SHEER CURTAIN SET - REF KS9702400 TV MOUNT - PER INTERIOR DESIGNER.
							PER MANUFACTURER'S SPECIFICATIONS AND RECOMMENDATIONS. PROVIDE SHOP DRAWINGS FOR REVIEW AND APPROVAL.
							SUBMIT FINAL SHOP DRAWINGS FOR REVIEW AND APPROVAL BY THE LANDSCAPE ARCHITECT. ALLOW FOR 14-16 WEEKS LEAD TIME.
S-8	TOWEL DISPLAY STATION	PER MANUF.	-	STAINED	CUSTOM BEACH MARIA ESCOBAR +1 786-219-6038	SSN72TS APPROX. DIM: 74"X 30"X 36"(80")	INSTALL PER DETAIL & MANUFACTURER SPECIFICATIONS. PROVIDE SHOP DRAWING FOR REVIEW AND APPROVAL.
S-9	UMBRELLAS WITH IN-GROUND SLEEVES	L3-401 DET.4	STAINLESS STEEL	BRUSHED	TUUCI/AGENCY 967 LEWIS EGLEY +1 310-228-7031	-	INSTALL PER DETAIL. PROVIDE SHOP DRAWING FOR REVIEW AND APPROVAL.
S-10	FOOT WASH	L3-404 DET.4	STAINLESS STEEL CHROME PLATED BRASS		OUTDOOR SHOWER CO. EMILY DAVISON +1 678-363-3939	FSFSHB-300- ADA	MARINE GRADE STAINLESS STEEL 316 WITH TEAK HANDLE INSTALL PER MANUFACTURER'S DETAIL. PROVIDE SHOP DRAWING FOR REVIEW AND APPROVAL.
S-11	MOBI MAT	PER MANUF.	YELLOW SAND TAN	-	MOBI MAT GREG SCULL +1 973-928-3040	ADA PARKING (MOBIDECK™ RIGID PANEL)	INSTALL PER DETAIL & MANUFACTURER SPECIFICATIONS. PROVIDE SHOP DRAWING FOR REVIEW AND APPROVAL.
S-12	DRINKING FOUNTAIN	PER MANUF.	STAINLESS STEEL WITH MATTE SILVER	POWDER COAT	HAWS CO.	MODEL 3612F	INSTALL PER DETAIL & MANUFACTURER SPECIFICATIONS. PROVIDE SHOP DRAWING FOR REVIEW AND APPROVAL.
S-13	FIREPIT SHUT-OFF VALVE PEDESTAL	L3-405 DET.3	DARK BRONZE	POWDER COAT	-	-	-
S-14	LITTER RECEPTACLE	-	-	STAINED	CUSTOM BEACH MARIA ESCOBAR +1 786-219-6038	RECYCLE WASTE BIN 23X2 (TP)	INSTALL PER DETAIL & MANUFACTURER SPECIFICATIONS. PROVIDE SHOP DRAWING FOR REVIEW AND APPROVAL.

## WATER FEATURE AND POOL SCHEDULE

KEY	DESCRIPTION	DETAIL	COLOR	FINISH	PATTERN	MANUFACTURER	REMARKS			
WF-1	MAIN POOL									
	PRECAST CONCRETE COPING	L3-405 DET.1	M1914	_	PER PLAN	HANOVER CONTACT: TYLER HAGARMAN 1-717-524-6440	REFER TO POOL CONTRACTOR'S DRAWINGS FOR DETAILED LAYOUT, REINFORCEMENT AND OTHER STRUCTURAL REQUIREMENTS. SAMPLE TO BE SUBMITTED TO LANDSCAP ARCHITECT FOR APPROVAL SEALER: AQUALOK (ORDER# 145829)			
	WATERLINE TILES	SOLID, NO PATTERN	EVERGLADE	GLAZED	2"X2" MOSAIC TILE	DALTILE MIRA CLUTTER 714.213.9500	REFER TO POOL CONTRACTOR'S DRAWINGS FOR DETAILED LAYOUT, REINFORCEMENT AND OTHER STRUCTURAL REQUIREMENTS.			
	STEP TRIM	PER MANUF.	EVERGLADE	UNGLAZED	1"X1" MOSAIC TILE	DALTILE MIRA CLUTTER 714.213.9500	REFER TO POOL CONTRACTOR'S DRAWINGS FOR DETAILED LAYOUT, REINFORCEMENT AND OTHER STRUCTURAL REQUIREMENTS.			
	DEPTH MARKER WATERLINE TILES	PER MANUF.	BLACK LETTERS ON WHITE MOSAIC TILES (IMPERIAL MARKINGS)	GLAZED	6" x 6"	DALTILE MIRA CLUTTER 714.213.9500	REFER TO POOL CONTRACTOR'S DRAWINGS FOR DETAILED LAYOUT, REINFORCEMENT AND OTHER STRUCTURAL REQUIREMENTS.			
WF-2	SPA POOL									
	PRECAST CONCRETE COPING	L3-405 DET.1	M1914	_	PER PLAN	HANOVER CONTACT: TYLER HAGARMAN 1-717-524-6440	REFER TO POOL CONTRACTOR'S DRAWINGS FOR DETAILED LAYOUT, REINFORCEMENT AND OTHER STRUCTURAL REQUIREMENTS. SAMPLE TO BE SUBMITTED TO LANDSCAP ARCHITECT FOR APPROVAL SEALER: AQUALOK (ORDER# 145829)			
	WATERLINE TILES	SOLID, NO PATTERN	EVERGLADE	GLAZED	2"X2" MOSAIC TILE	DALTILE MIRA CLUTTER 714.213.9500	REFER TO POOL CONTRACTOR'S DRAWINGS FOR DETAILED LAYOUT, REINFORCEMENT AND OTHER STRUCTURAL REQUIREMENTS.			
	STEP TRIM	PER MANUF.	EVERGLADE	UNGLAZED	1"X1" MOSAIC TILE	DALTILE MIRA CLUTTER 714.213.9500	REFER TO POOL CONTRACTOR'S DRAWINGS FOR DETAILED LAYOUT, REINFORCEMENT AND OTHER STRUCTURAL REQUIREMENTS.			
	DEPTH MARKER WATERLINE TILES	PER MANUF.	BLACK LETTERS ON WHITE MOSAIC TILES (IMPERIAL MARKINGS)	GLAZED	6" x 6"	DALTILE MIRA CLUTTER 714.213.9500	REFER TO POOL CONTRACTOR'S DRAWINGS FOR DETAILED LAYOUT, REINFORCEMENT AND OTHER STRUCTURAL REQUIREMENTS.			

#### **KEYNOTES**

- 1 EVENT PAVILION BY ARCHITECT
- (2) RESTROOM BY ARCHITECT
- 3 LOUNGE SEATING BY INTERIOR DESIGNER.
- 4 POOL DEPTH MARKER BY POOL CONSULTANT.
- 5 ADA POOL LIFT CHAIR BY POOL CONSULTANT.
- (6) OVERHEAD STRUCTURE BY ARCHITECT
- TIKI BAR/DECK RAILING BY ARCHITECT.
   STRUCTURE, DECK, STAIR, AND RAILINGS BY ARCHITECT
- 8 EXISTING SHOWER TO REMAIN & ROTATE TO FIT WOOD DECK CONFIGURATION BY ARCHITECT.
- (9) STAGE BY ARCHITECT.
- (10) POOL EQUIPMENT ROOM BY ARCHITECT.
- 11) EXISTING SIDEWALK & CURB PROTECT IN
- (12) NEW POOL RESTROOM BY ARCHITECT.
- (13) NEW KITCHEN AT TIKI BAR BY ARCHITECT.
- (14) NEW DUNE WALKOVER BY ARCHITECT.
- 15) FF&E BY INTERIOR DESIGNER.
- (16) EXISTING UTILITY ROOM.
- (17) PUMP EQUIPMENT BY POOL CONSULTANT.
- 18 UMBRELLA BY INTERIOR DESIGNER.
- (19) WHEEL STOPS TO BE SELECTED.
- (20) RESORT CONCESSION STAND.


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no. date iss

# Beach House HILTON HEAD ISLAND

1 SOUTH FOREST BEACH DRIVE HILTON HEAD, SC 29928 project logo

HARDSCAPE SCHEDULE AND NOTES

project no. 212041

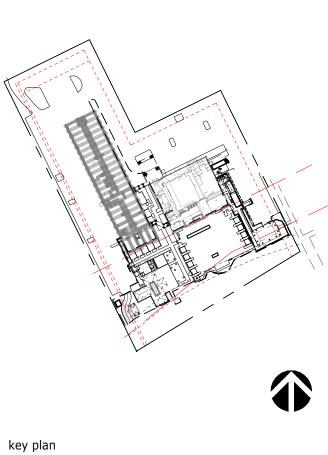
drawn by: FCVA / CL

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P-2 PERMEABLE CONCRETE PAVER COLOR: M1914



P-5 DETECTABLE WARNING PAVER COLOR: CHARCOAL

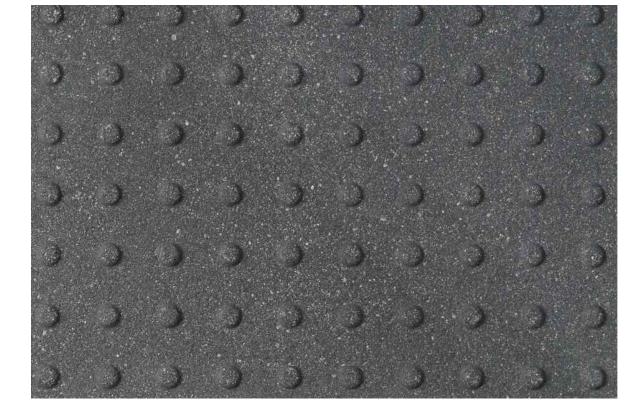


ALUMINUM POOL ENCLOSURE FENCE COLOR: MATTE BRONZE



**CABLE RAIL FENCE** COLOR: DARK BRONZE



P-3 WOOD DECK COLOR: CUMARU BRAZILIAN TEAK

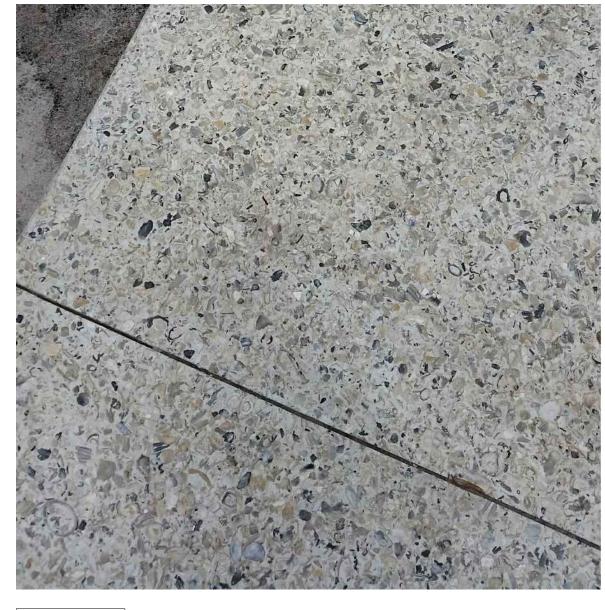

P-6 TABBY COLOR: TAN WITH TABBY PIP CONCRETE WITH INTEGRATED




**WOOD DECK** F-3 COLOR: CUMARU BRAZILIAN TEAK



Matte Bronze



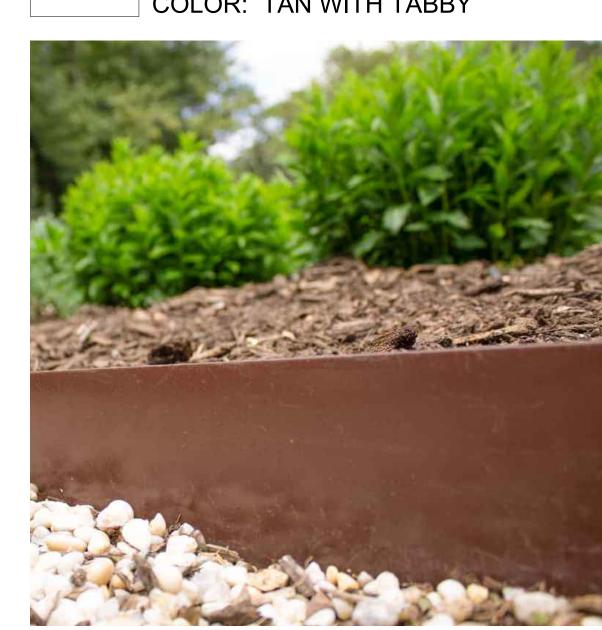

ALT: SOUTHERN YELLOW PINE



**WOOD DECK** F-3 ALT: SOUTHERN YELLOW PINE



R-2 TUBULAR STAINLESS STEEL POOL HANDRAILS COLOR: STAINLESS STEEL | MATTE



P-3 WOOD DECK

P-4 STABILIZED OYSTER SHELLS COLOR: NATURAL



P-9 SYNTHETIC TURF COLOR: FIELD GREEN


P-8 STEEL EDGING COLOR: BROWN



R-3 DUNE WALL CLADDING COLOR: SOUTHERN YELLOW PINE

WATG

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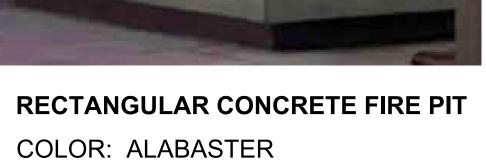


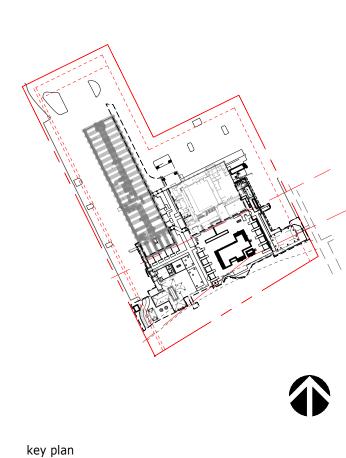HILTON HEAD ISLAND 1 SOUTH FOREST BEACH DRIVE HILTON HEAD, SC 29928

HARDSCAPE IMAGERY MATERIALS & FINISHES

drawn by: FCVA / CL

**S-1** 





CIRCULAR CONCRETE BOWL FIRE PIT COLOR: ALABASTER



S-5 OUTDOOR SHOWER COLOR: STAINLESS STEEL




S-7 POOL CABANA COLOR: SAND DUNE



UMBRELLA WITH IN-GROUND SLEEVES COLOR: STAINLESS STEEL



S-10 FOOT WASH COLOR: STAINLESS STEEL

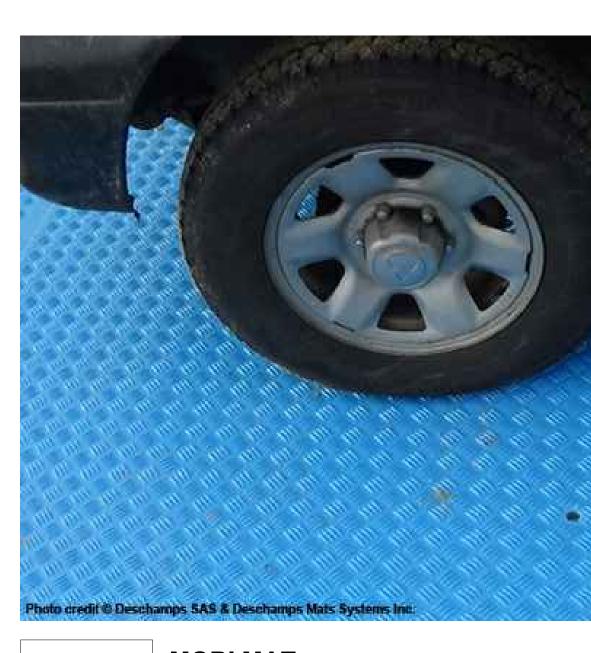

**MOBI MAT** COLOR: YELLOW SAND/TAN




S-12 DRINKING FOUNTAIN COLOR: STAINLESS STEEL



S-14 LITTER RECEPTACLE
COLOR: DARK BRONZE ALUMINUM
COLOR: STAINED WOOD



PRECAST CONCRETE COPING COLOR: M1914

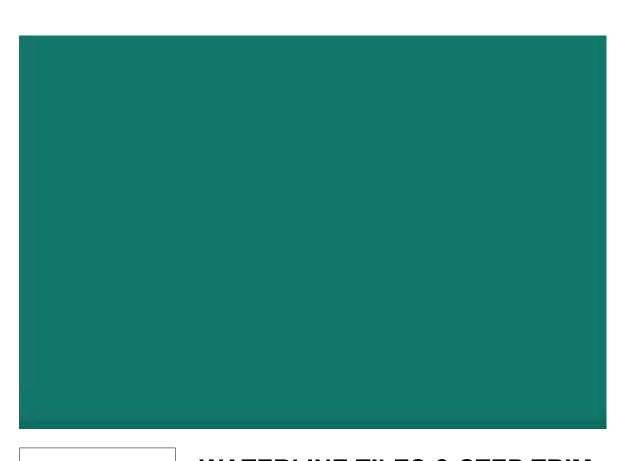

WATERLINE TILES & STEP TRIM COLOR: EVERGLADE






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drawn by: FCVA / CL





S-6 PLANTER BOX

COLOR: DUNE/SANDSTONE

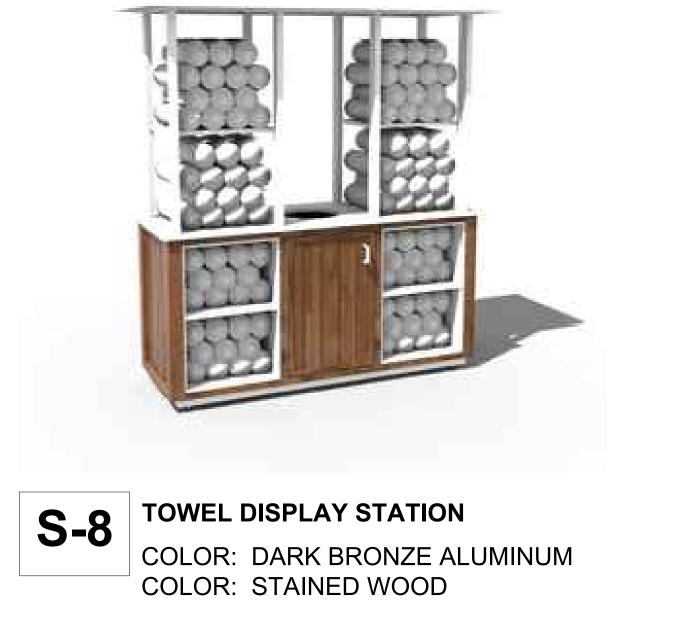COLOR: STAINED WOOD




SITE ELEMENT SCHEDULE



WF-1 WF-2



WF-1 WF-2

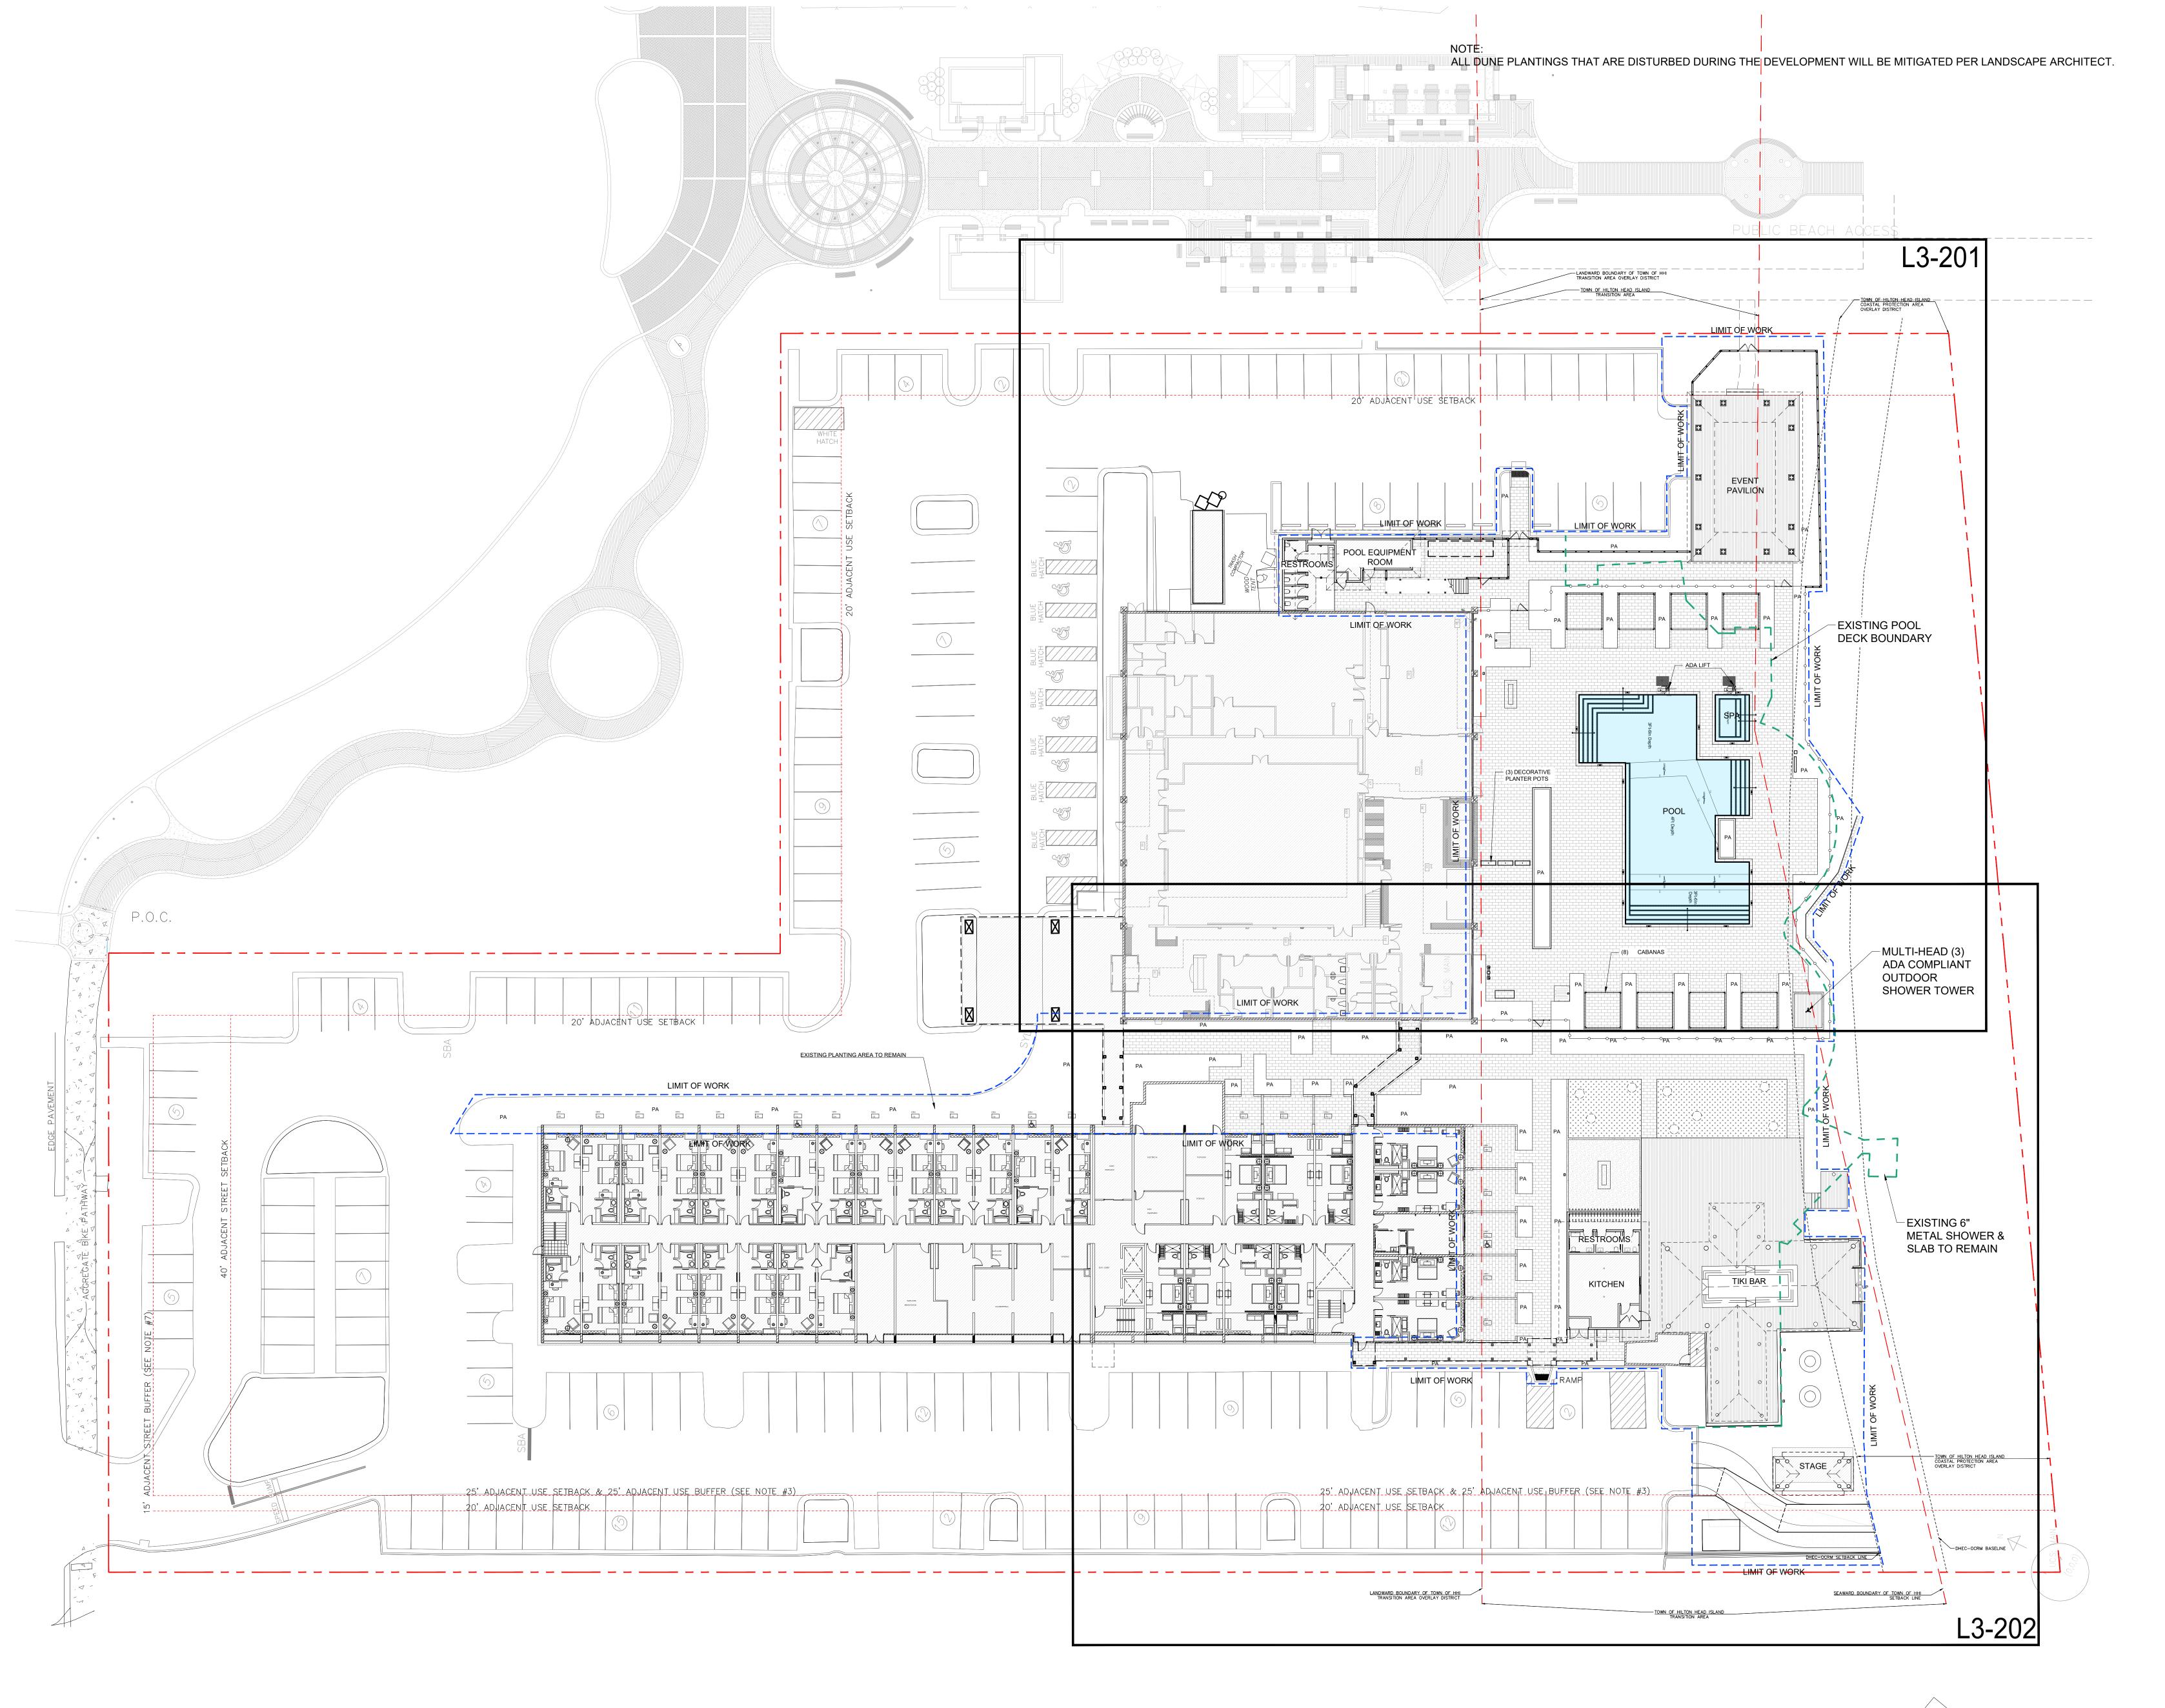

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INVESTORS
REDHOSPITALITY

CONSULTING

client

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no. date issue

Beach House
HILTON HEAD ISLAND

1 SOUTH FOREST BEACH DRIVE HILTON HEAD, SC 29928 project logo

OVERALL
HARDSCAPE PLAN
sheet title


project no. 212041 date

checked by:
drawn by:

L3-101


OVERALL HARDSCAPE PLAN

1" = 20'-0"

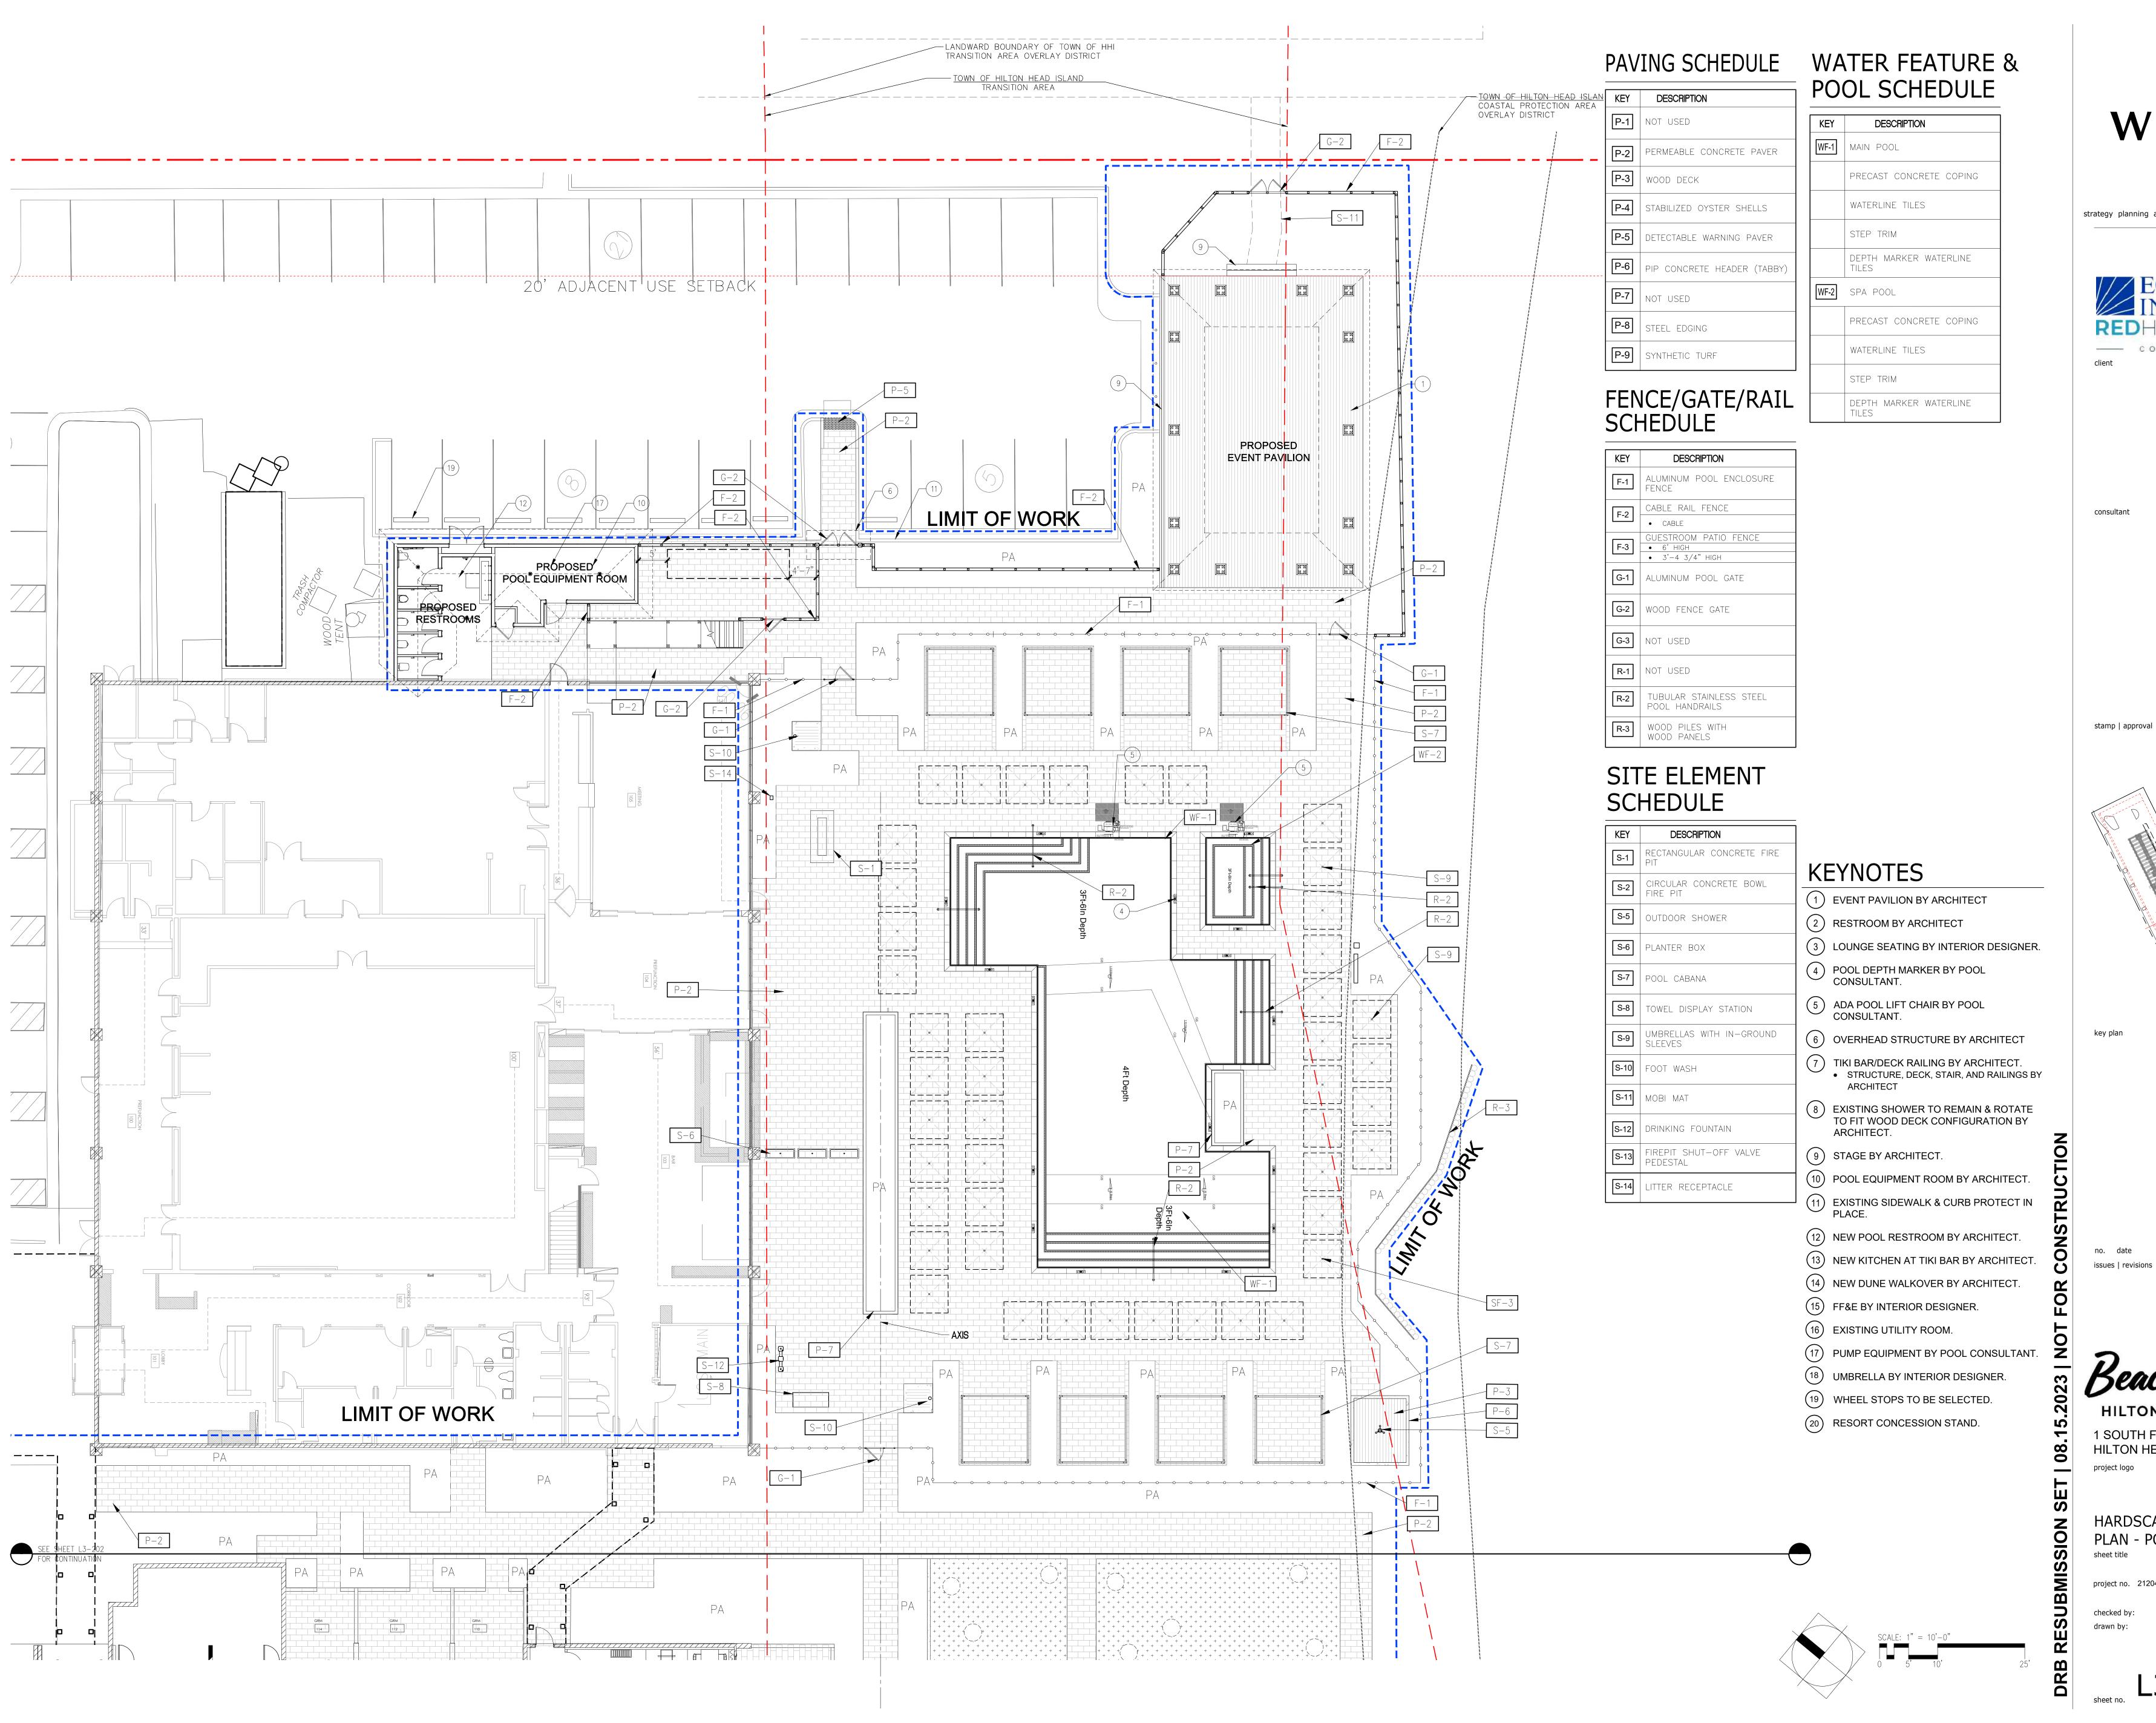


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1 SOUTH FOREST BEACH DRIVE HILTON HEAD, SC 29928


HARDSCAPE ENLARGEMENT PLAN - POOL DECK

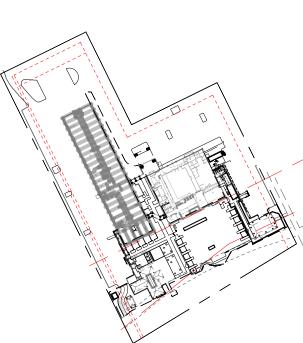

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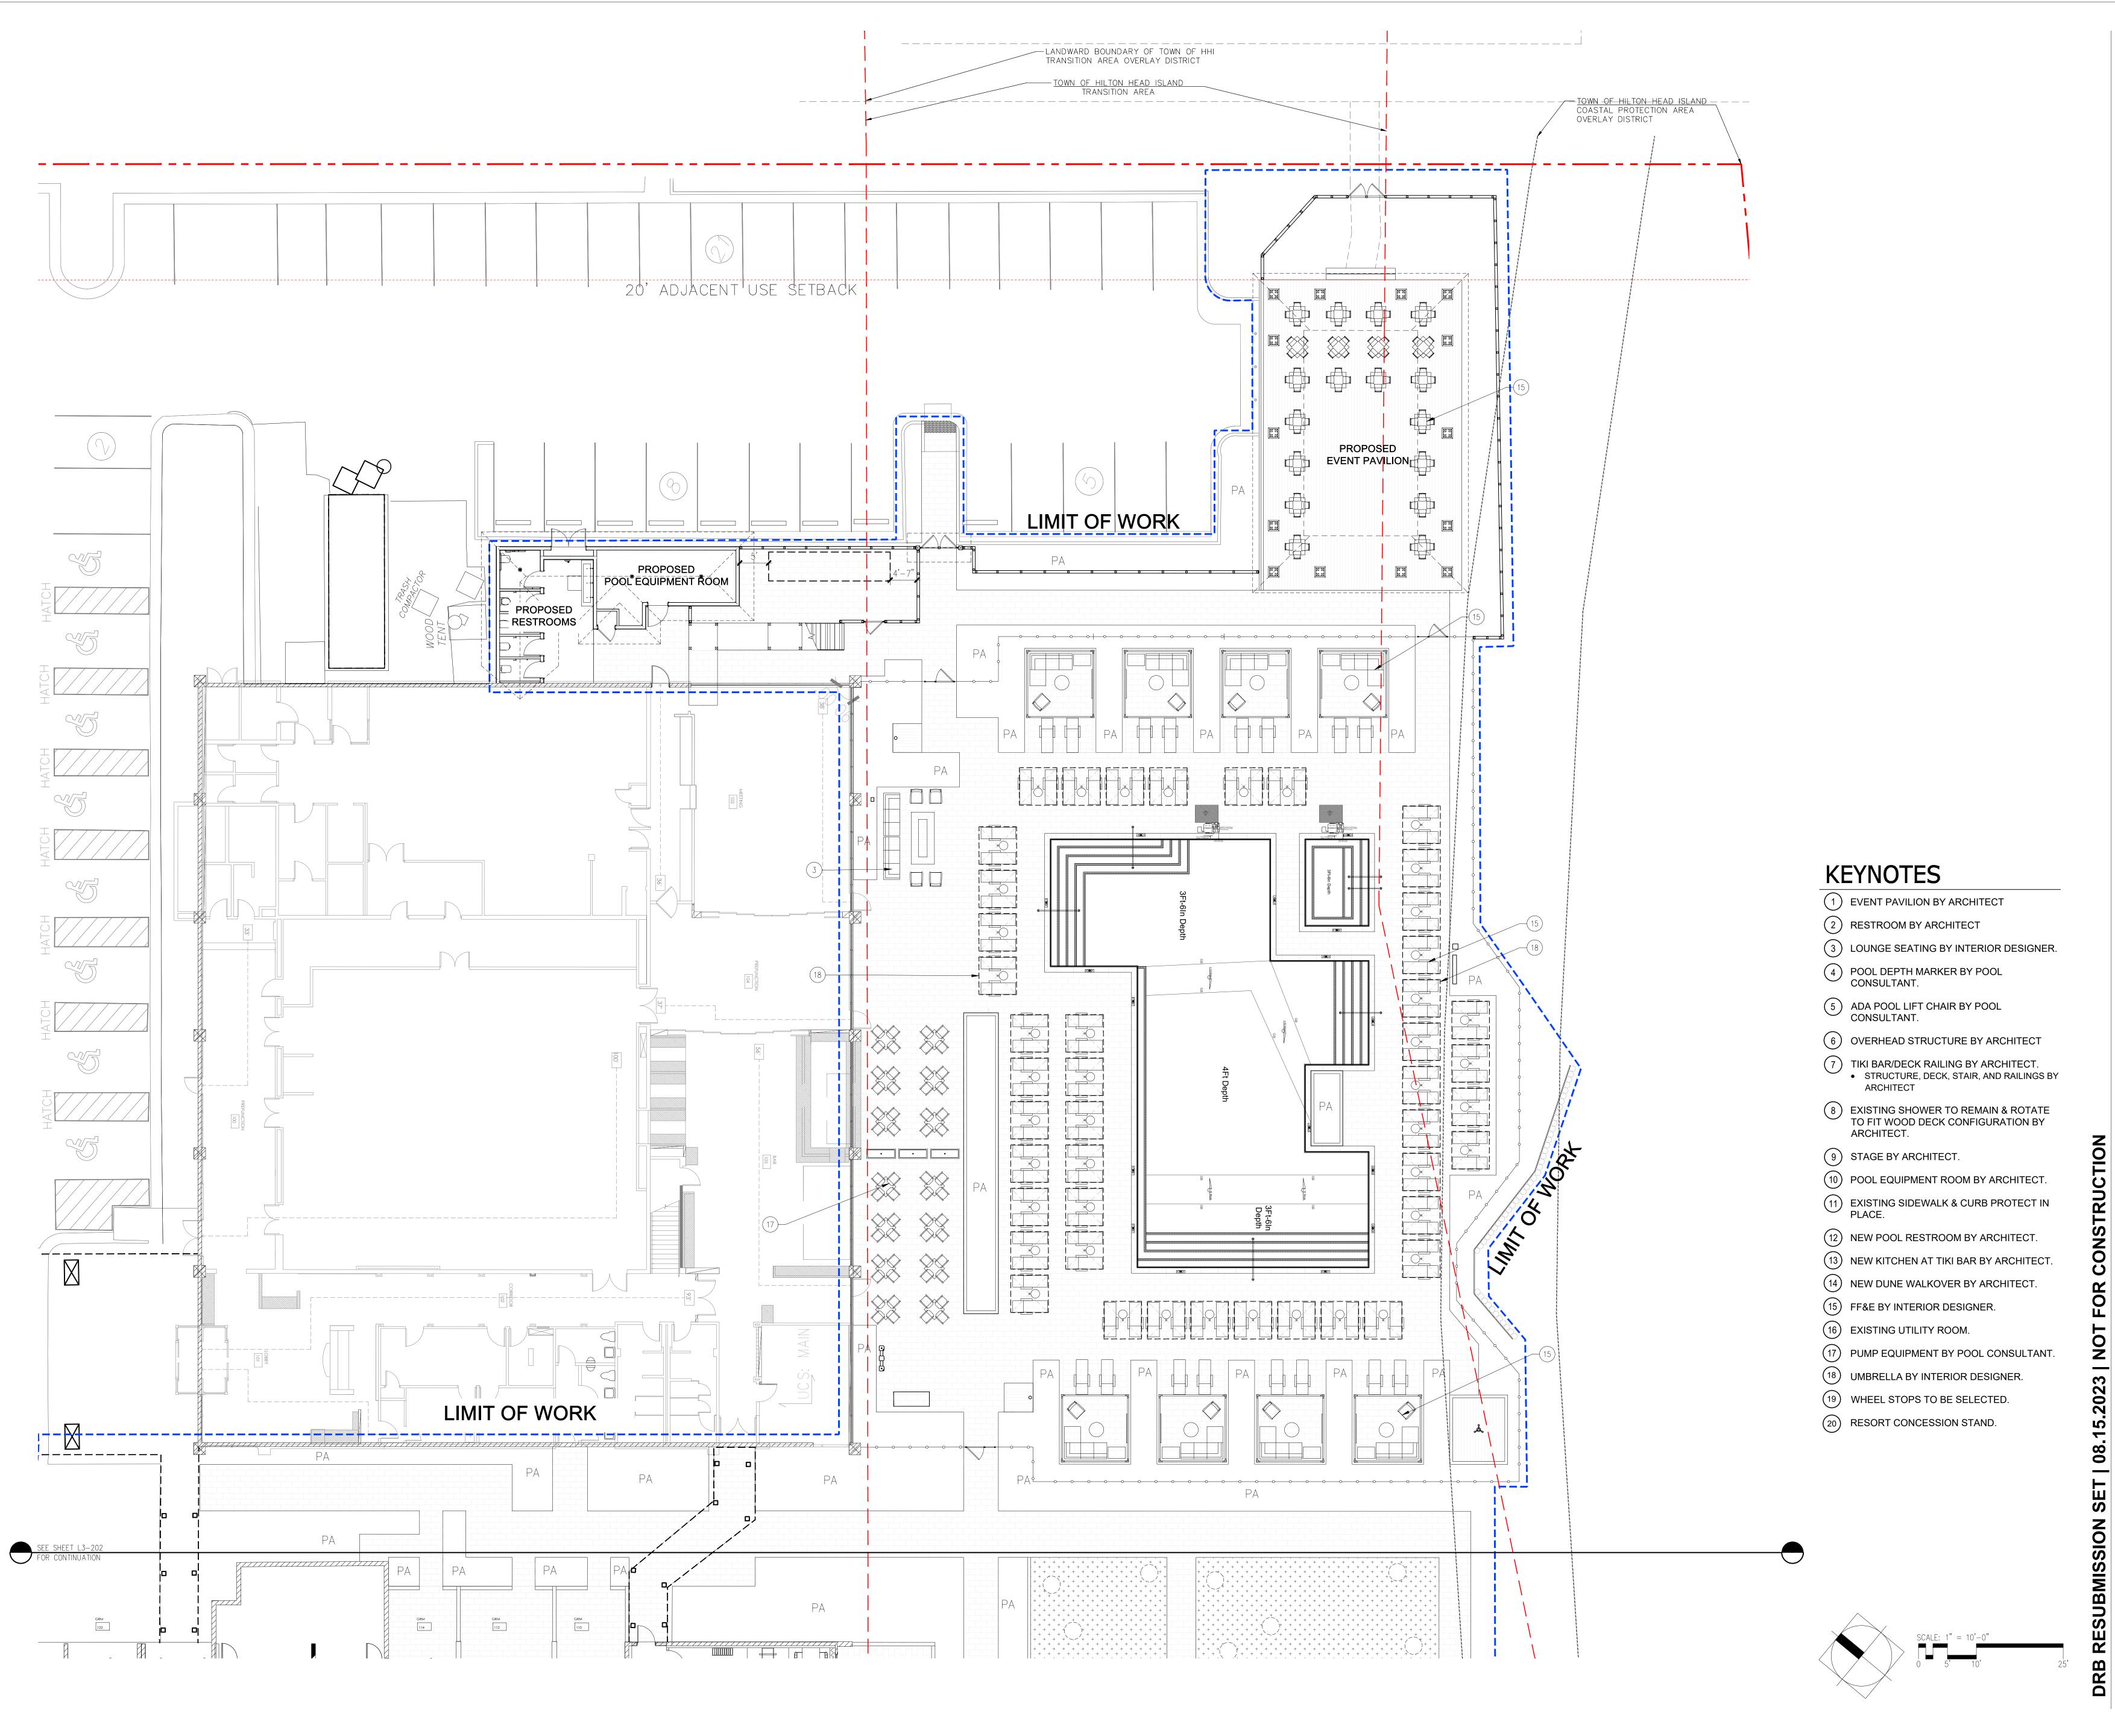


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HARDSCAPE ENLARGMENT

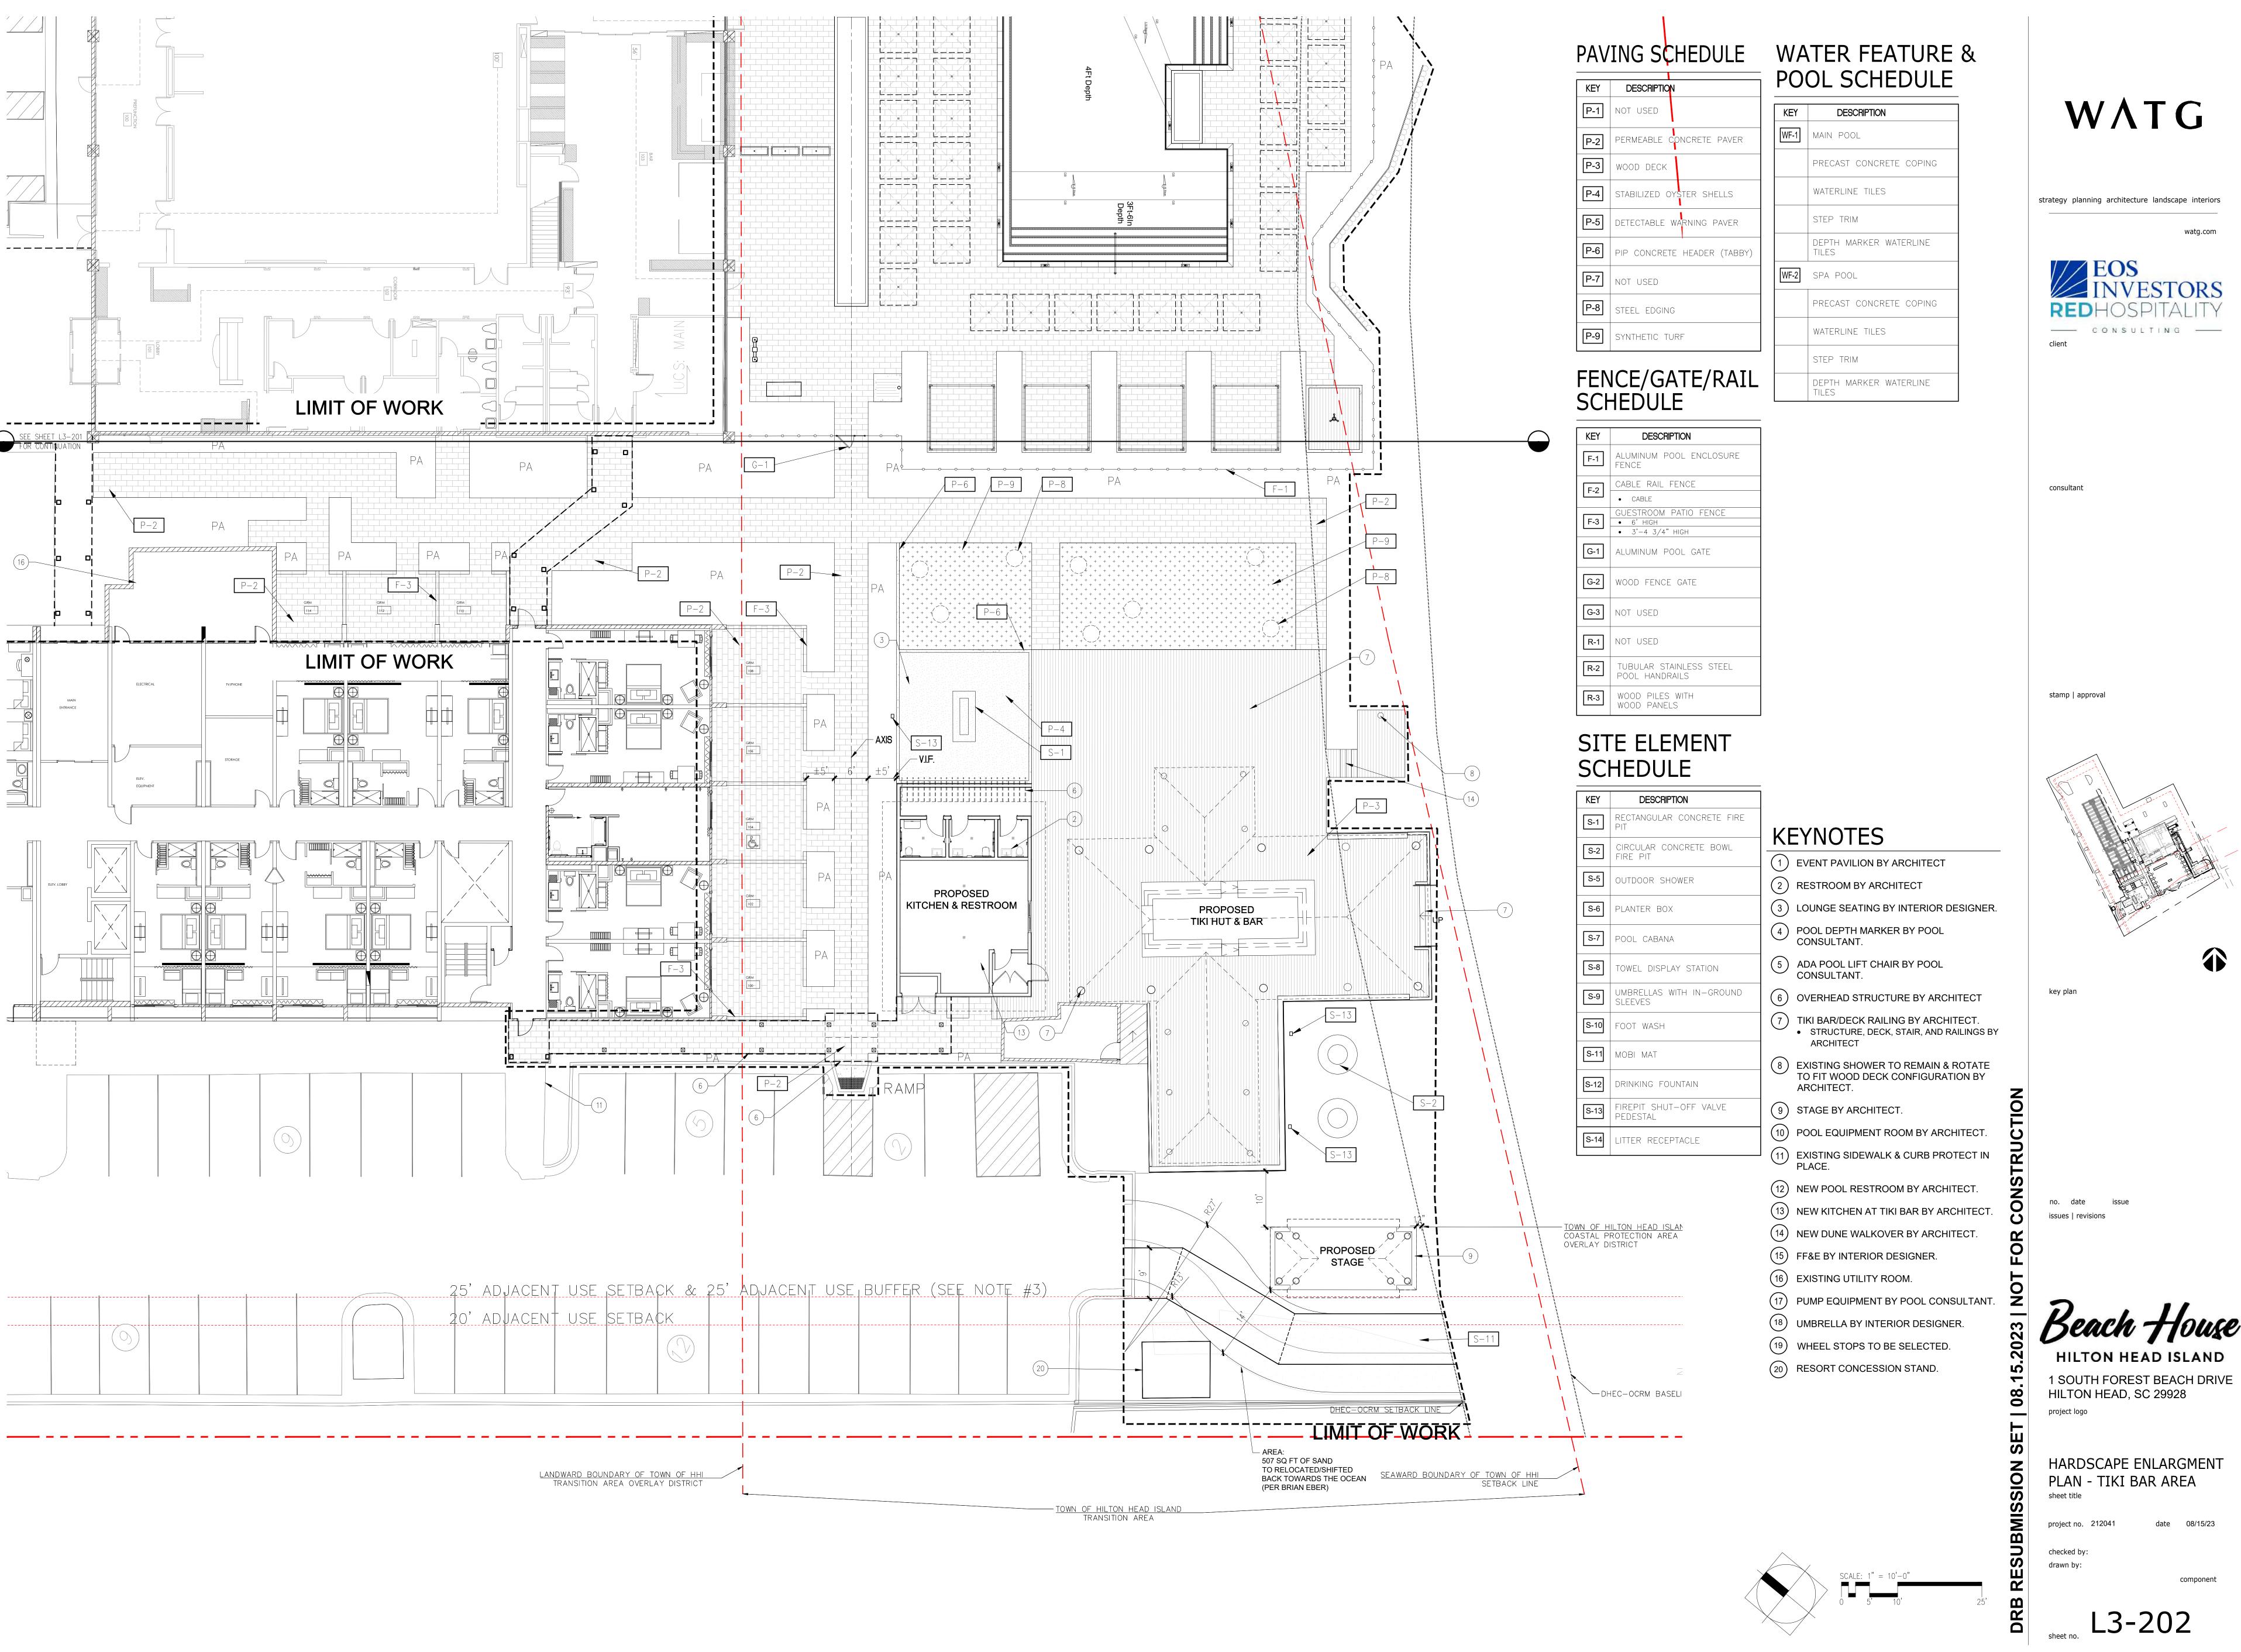PLAN - TIKI BAR AREA

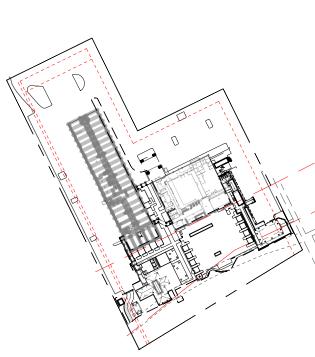


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key plan

no date

issues | revisions

# Beach House HILTON HEAD ISLAND

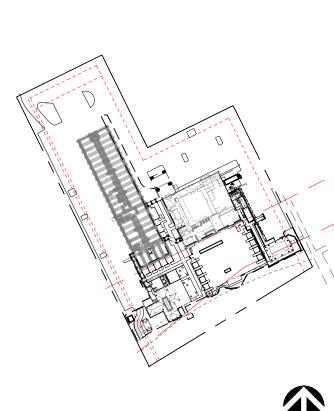
1 SOUTH FOREST BEACH DRIVE HILTON HEAD, SC 29928

FURNITURE LAYOUT

ENLARGEMENT PLAN POOL DECK
sheet title

project no. 212041 date 08/15/23 checked by: drawn by:

L3-203

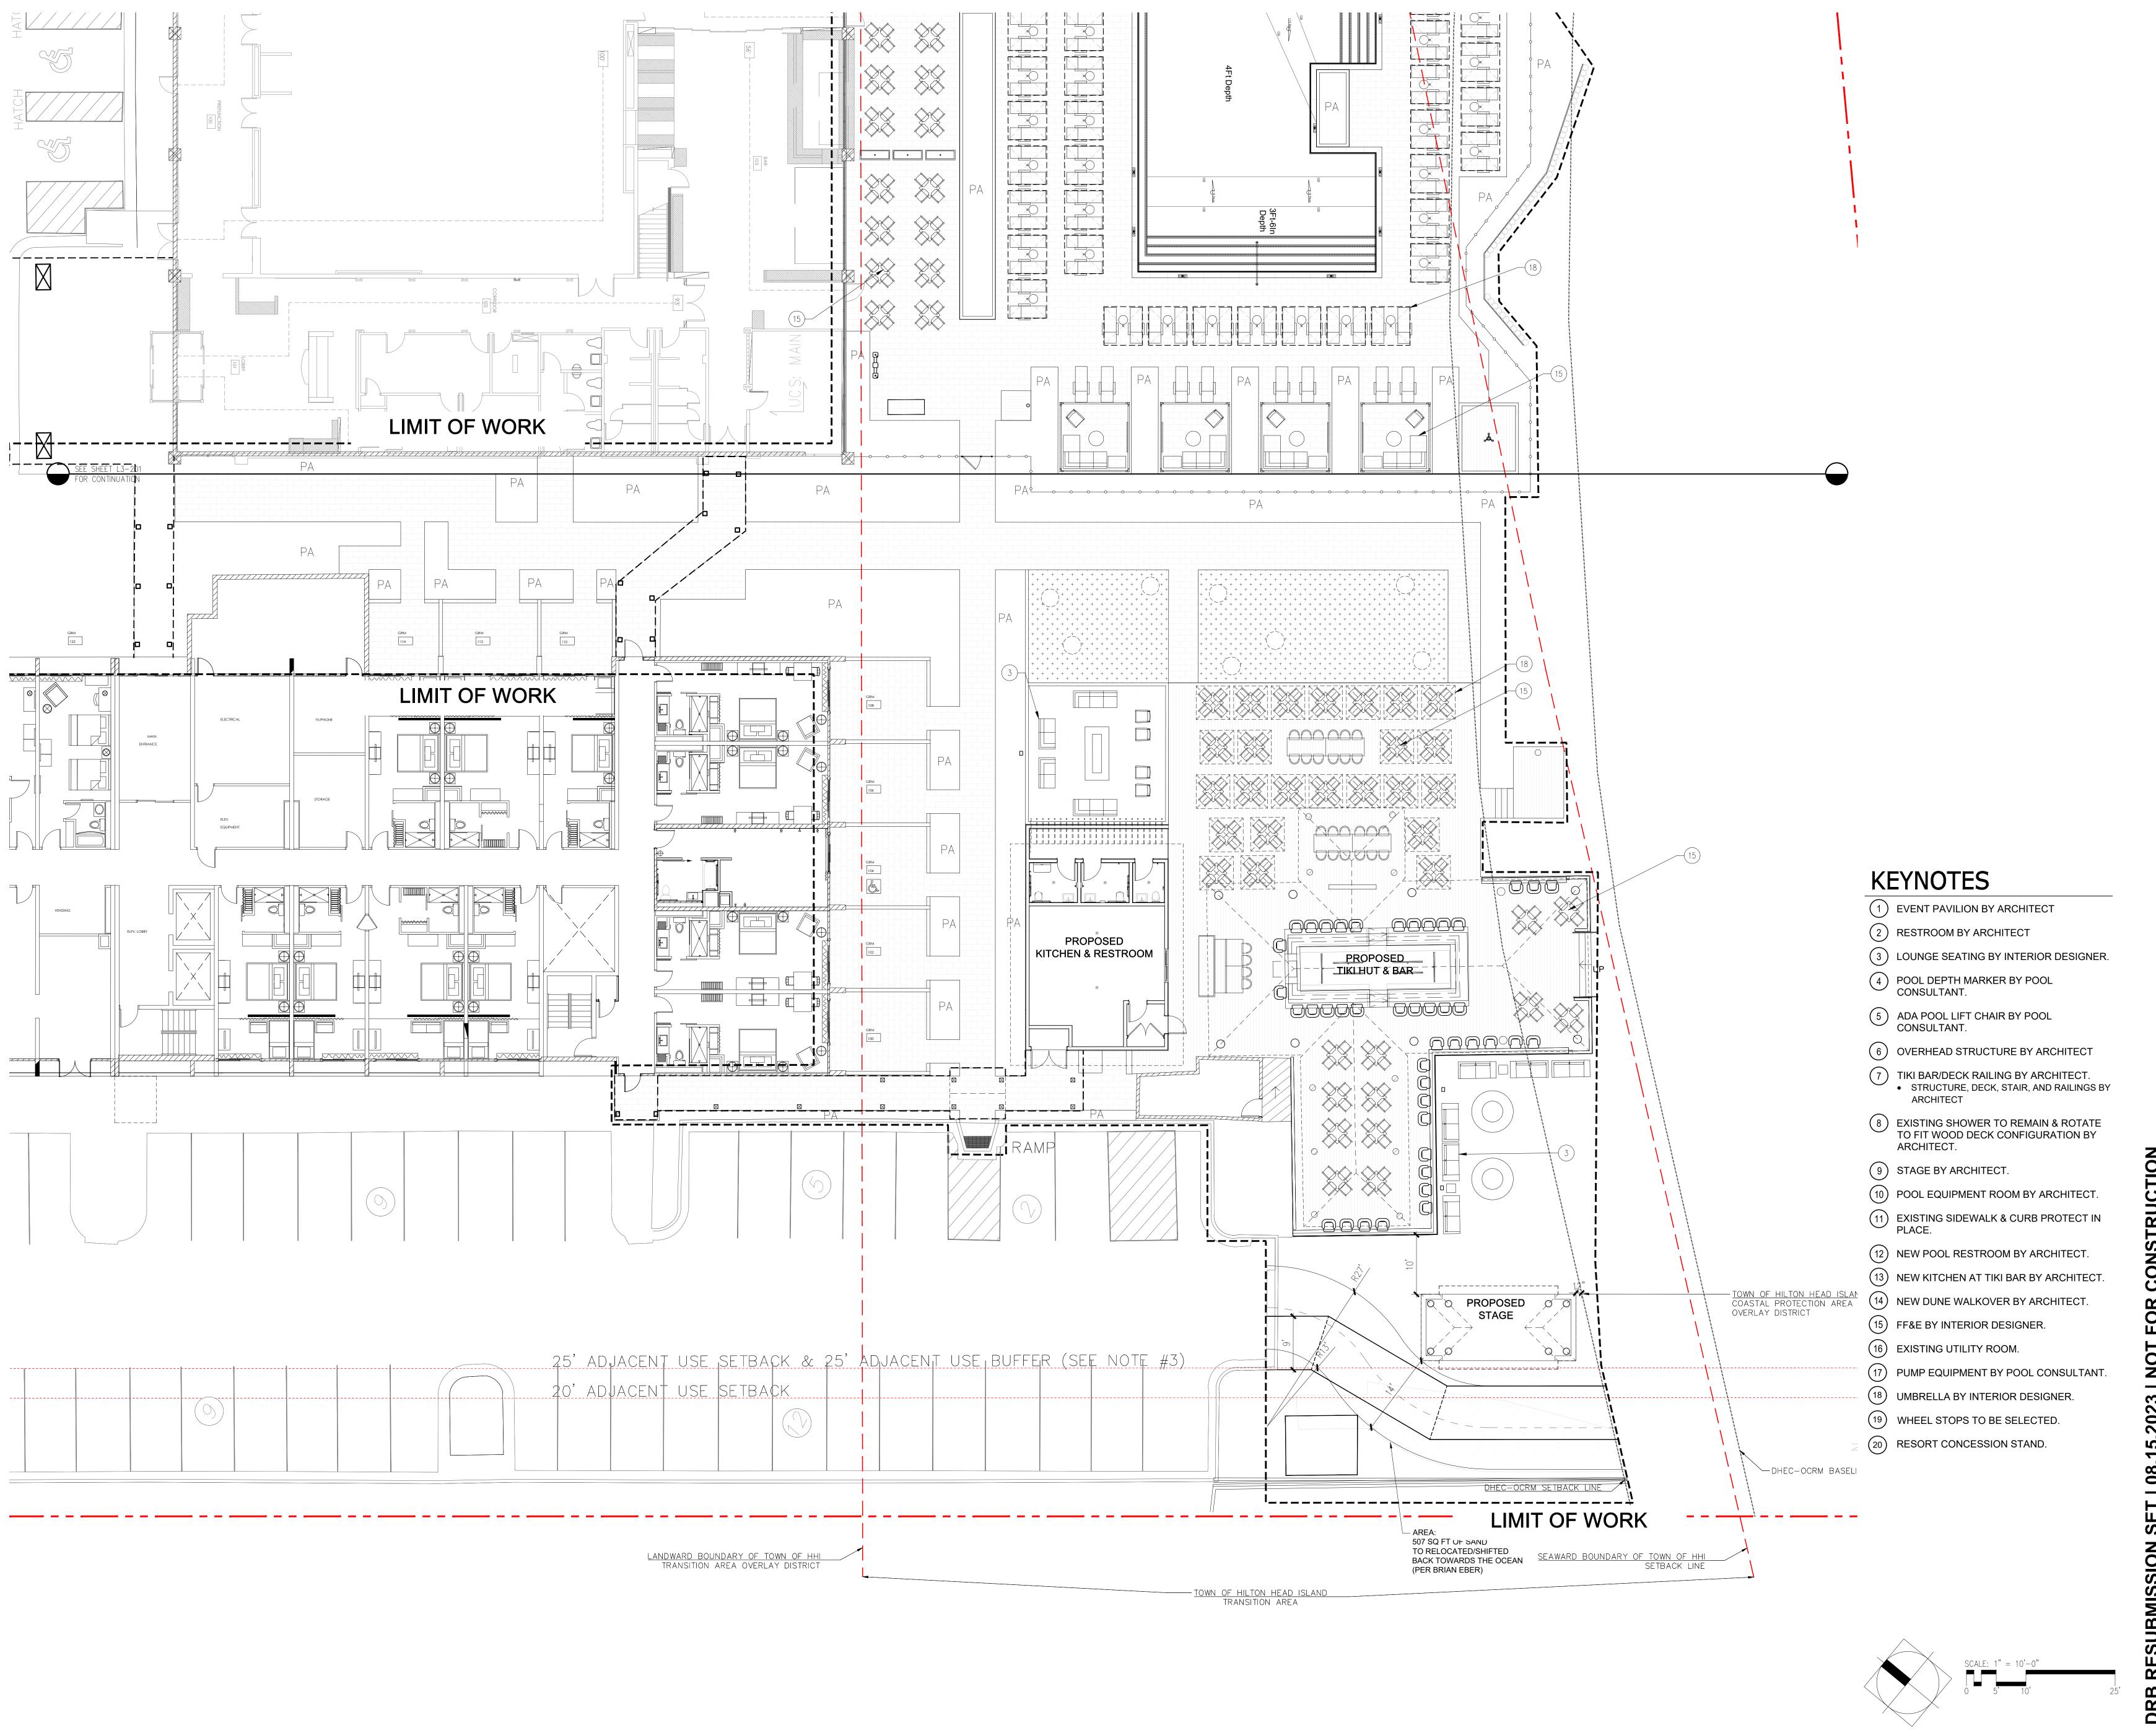


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stamp | approval



key plan

no. date is:
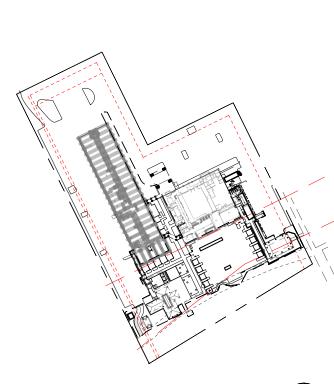
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# Seach Touse HILTON HEAD ISLAND 1 SOUTH FOREST BEACH DRIVE HILTON HEAD, SC 29928


FURNITURE LAYOUT
ENLARGEMENT PLAN

ENLARGEMENT PLAN
- TIKI BAR AREA
sheet title

project no. 212041 date 08/15/23


checked by:

. . . . . .

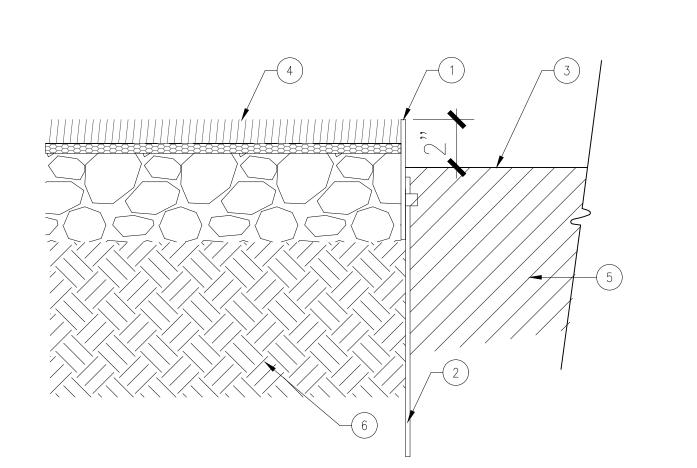

#### **LEGEND**

- 1. STEEL EDGING, REFER TO HARDSCAPE SCHEDULE FOR COLOR, FINISH, AND
- MANUFACTURER. 2. STEEL EDGING STAKE. REFER TO MANUFACTURER'S
- RECOMMENDATION. 3. FINISH GRADE AT PLANTING AREA. 4. SYNTHETIC TURF PER
- MANUFACTURERS' SPECIFICATIONS. 5. AMENDED BACKFILL IN PLANTING AREA PER AGRICULTURAL SOILS TEST AND RECOMMENDATIONS.
- 6. COMPACTED SUBGRADE PER GEOTECHNICAL SOILS REPORT AND RECOMMENDATIONS.

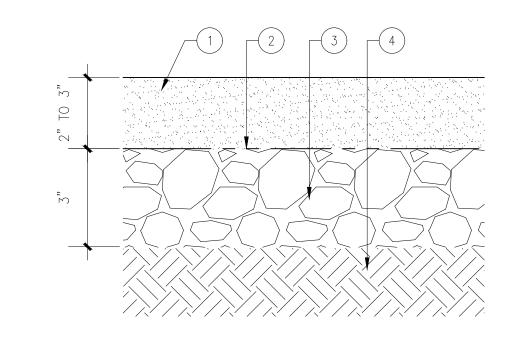

#### <u>LEGEND</u>


- 1. CRUSHED OYSTER SHELL AND CRUSHED GRANITE
- 2. GEOTEXTILE FILTER FABRIC, MIRAFI 140N. 3. COMPACTED 3/4" MINUS CRUSHED GRAVEL PER MANUFACTURERS RECOMMENDATIONS AND
- SPECIFICATIONS. 4. COMPACTED SUBGRADE PER GEOTECHNICAL SOILS REPORT AND MANUFACTURERS RECOMMENDATIONS AND SPECIFICATIONS.

3 STABILIZED OYSTER SHELL
3" = 1'-0"

#### LEGEND

- 1. ADJACENT PAVERS. SEE HARDSCAPE SCHEDULE FOR COLOR, SIZE, FINISH, AND MANUFACTURER. LAYOUT PER PLAN.
- 2. CONCRETE BASE. 3. DETECTABLE WARNING PAVER, SEE HARDSCAPE SCHEDULE FOR MATERIAL, COLOR, FINISH, AND MANUFACTURER.
- 4. MORTAR SETTING BED. 5. CONCRETE CURB, REFER TO CIVIL ENGINEERS DRAWINGS.
- 6. ASPHALT PAVING. REFER TO CIVIL ENGINEERS DRAWINGS. 7. COMPACTED SUBGRADE PER GEO-TECHNICAL REPORT.


- A. REFER TO CIVIL ENGINEERING DRAWINGS FOR DETECTABLE WARNING PAVERS' SLOPE AND FINISH GRADE. B. REFER TO STRUCTURAL ENGINEERING
- DRAWINGS FOR REINFORCEMENT REQUIREMENTS.
- C. REFER TO GEOTECHNICAL REPORT.

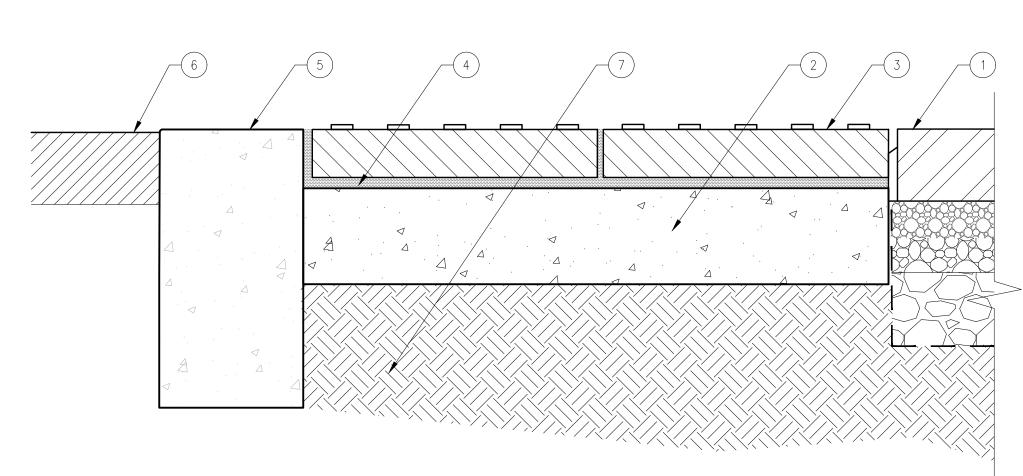


#### **LEGEND**

T STEEL EDGING

- 1. PRE-CAST CONCRETE CURB, REFER TO HARDSCAPE SCHEDULE FOR COLOR, SIZE, FINISH, AND MANUFACTURER. INSTALL PER MANUFACTURERS' RECOMMENDATION.
- 2. PLANTING AREA. 3. ADJACENT PAVING FINISH SURFACE (SEE HARDSCAPE PLANS).

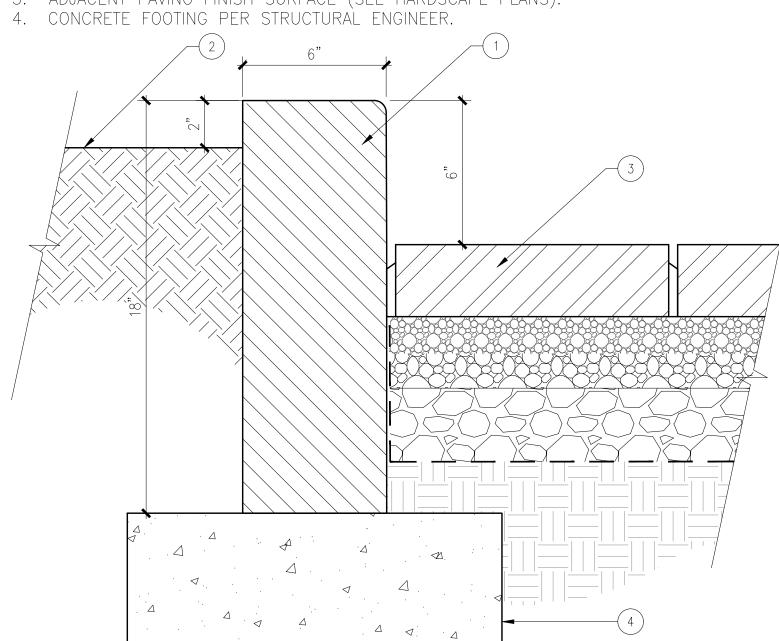

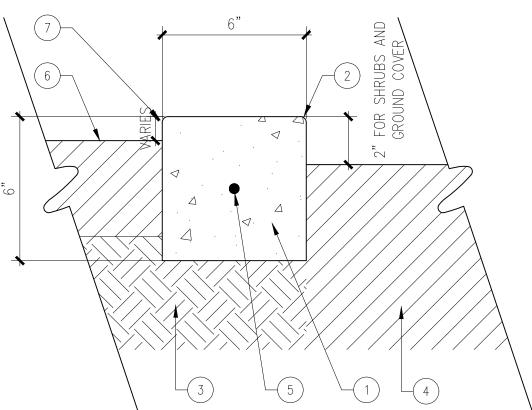

#### LEGEND

- 1. CONCRETE HEADER. REFER TO HARDSCAPE SCHEDULE, SHEET L3-001, FOR COLOR AND FINISH.
- 2. 1/8" RADIUS.

OYSTER SHELLS.

- 3. COMPACTED BASE AND SUBGRADE PER GEOTECHNICAL SOILS REPORT.
- 4. AMENDED BACKFILL IN PLANTING AREAS PER AGRICULTURAL SOILS

A. REFER TO CONSTRUCTION PLAN

FOR ALL COLORS, TYPES FINISHES

AND MANUFACTURES REQUIREMENTS

- SUITABILITY REPORT AND RECOMMENDATIONS. 5. #3 REBAR CONTINUOUS — CENTER IN HEADER
- 6. ADJACENT FINISH SURFACE. 7. 1" DROP FOR SYNTHETIC TURF, 3/8" DROP FOR STABILIZED

6 DETECTABLE WARNING PAVER

3" = 1'-0"

5 PRE-CAST CONCRETE CURB

3" = 1'-0"




# PER STRUC. ENG.

#### PLAN VIEW


#### **LEGEND**

- 1. CONCRETE PAVER, SEE HARDSCAPE PLAN. COMPACTED SUBGRADE PER GEO-TECHNICAL REPORT. 3. CONCRETE FOOTING PER STRUCTURAL ENGINEER.
- 4. MODIFIED CONCRETE FOOTING EXTENSION. 5. IN-GROUND MOUNT, FLUSH WITH PAVING SURFACE.
- 6. PVC PIPE.

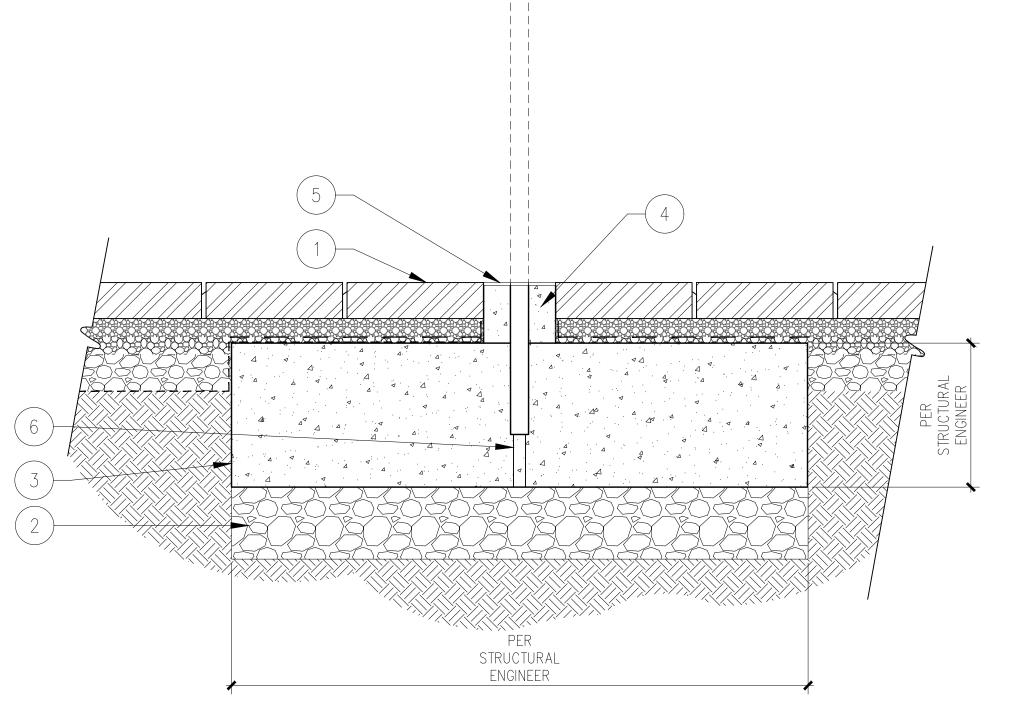

#### PRECAST CONCRETE PAVER CONDITION

- 1. CONCRETE PAVER. SEE HARDSCAPE SCHEDULE FOR COLOR, SIZE, FINISH, AND
- MANUFACTURER. LAYOUT PER PLAN. 2. BUILT-IN SPACERS TO PROVIDE A 3/8" JOINT SPACE, FILLED WITH 1/4" OPEN
- GRADED STONE PER MANUFACTURER'S SPECIFICATIONS AND RECOMMENDATIONS. 3. MORTAR SETTING BED.
- 4. PIP CONCRETE EDGE.
- 5. COMPACTED SUBGRADE. 6. OPEN GRADED STONE AASHTO#8 SETTING BED.
- 7. OPEN GRADED STONE AASHTO#57, OR EQUIVALENT, DEPTH PER STRUCTURAL ENGINEER.
- 8. OPEN GRADED STONE AASHTO#2 BASE COURSE, DEPTH PER STRUCTURAL ENGINEER.
- 9. MIRAFI 140N FILTER FABRIC TO SEPARATE COMPACTED BASE COURSE AND

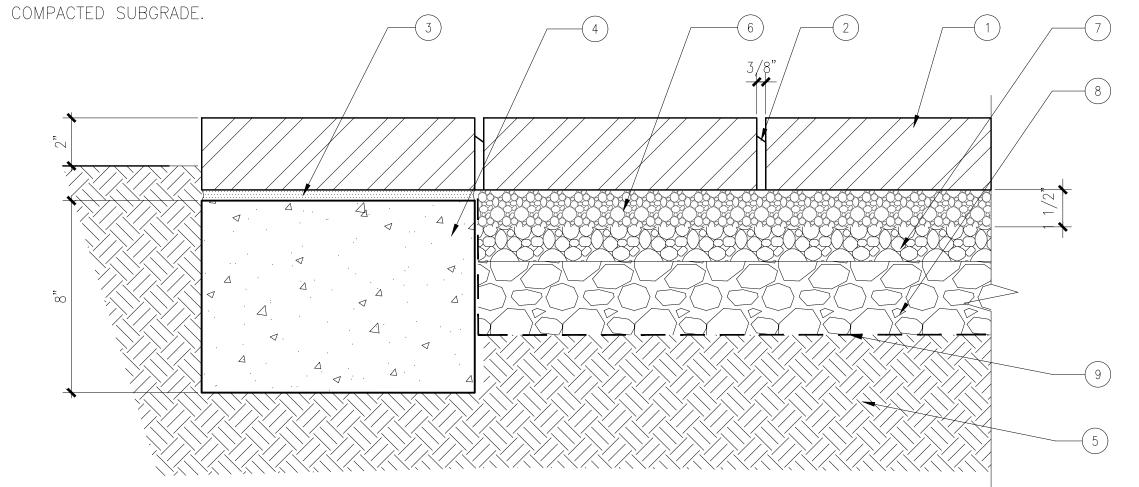

PERMEABLE CONCRETE PAVER

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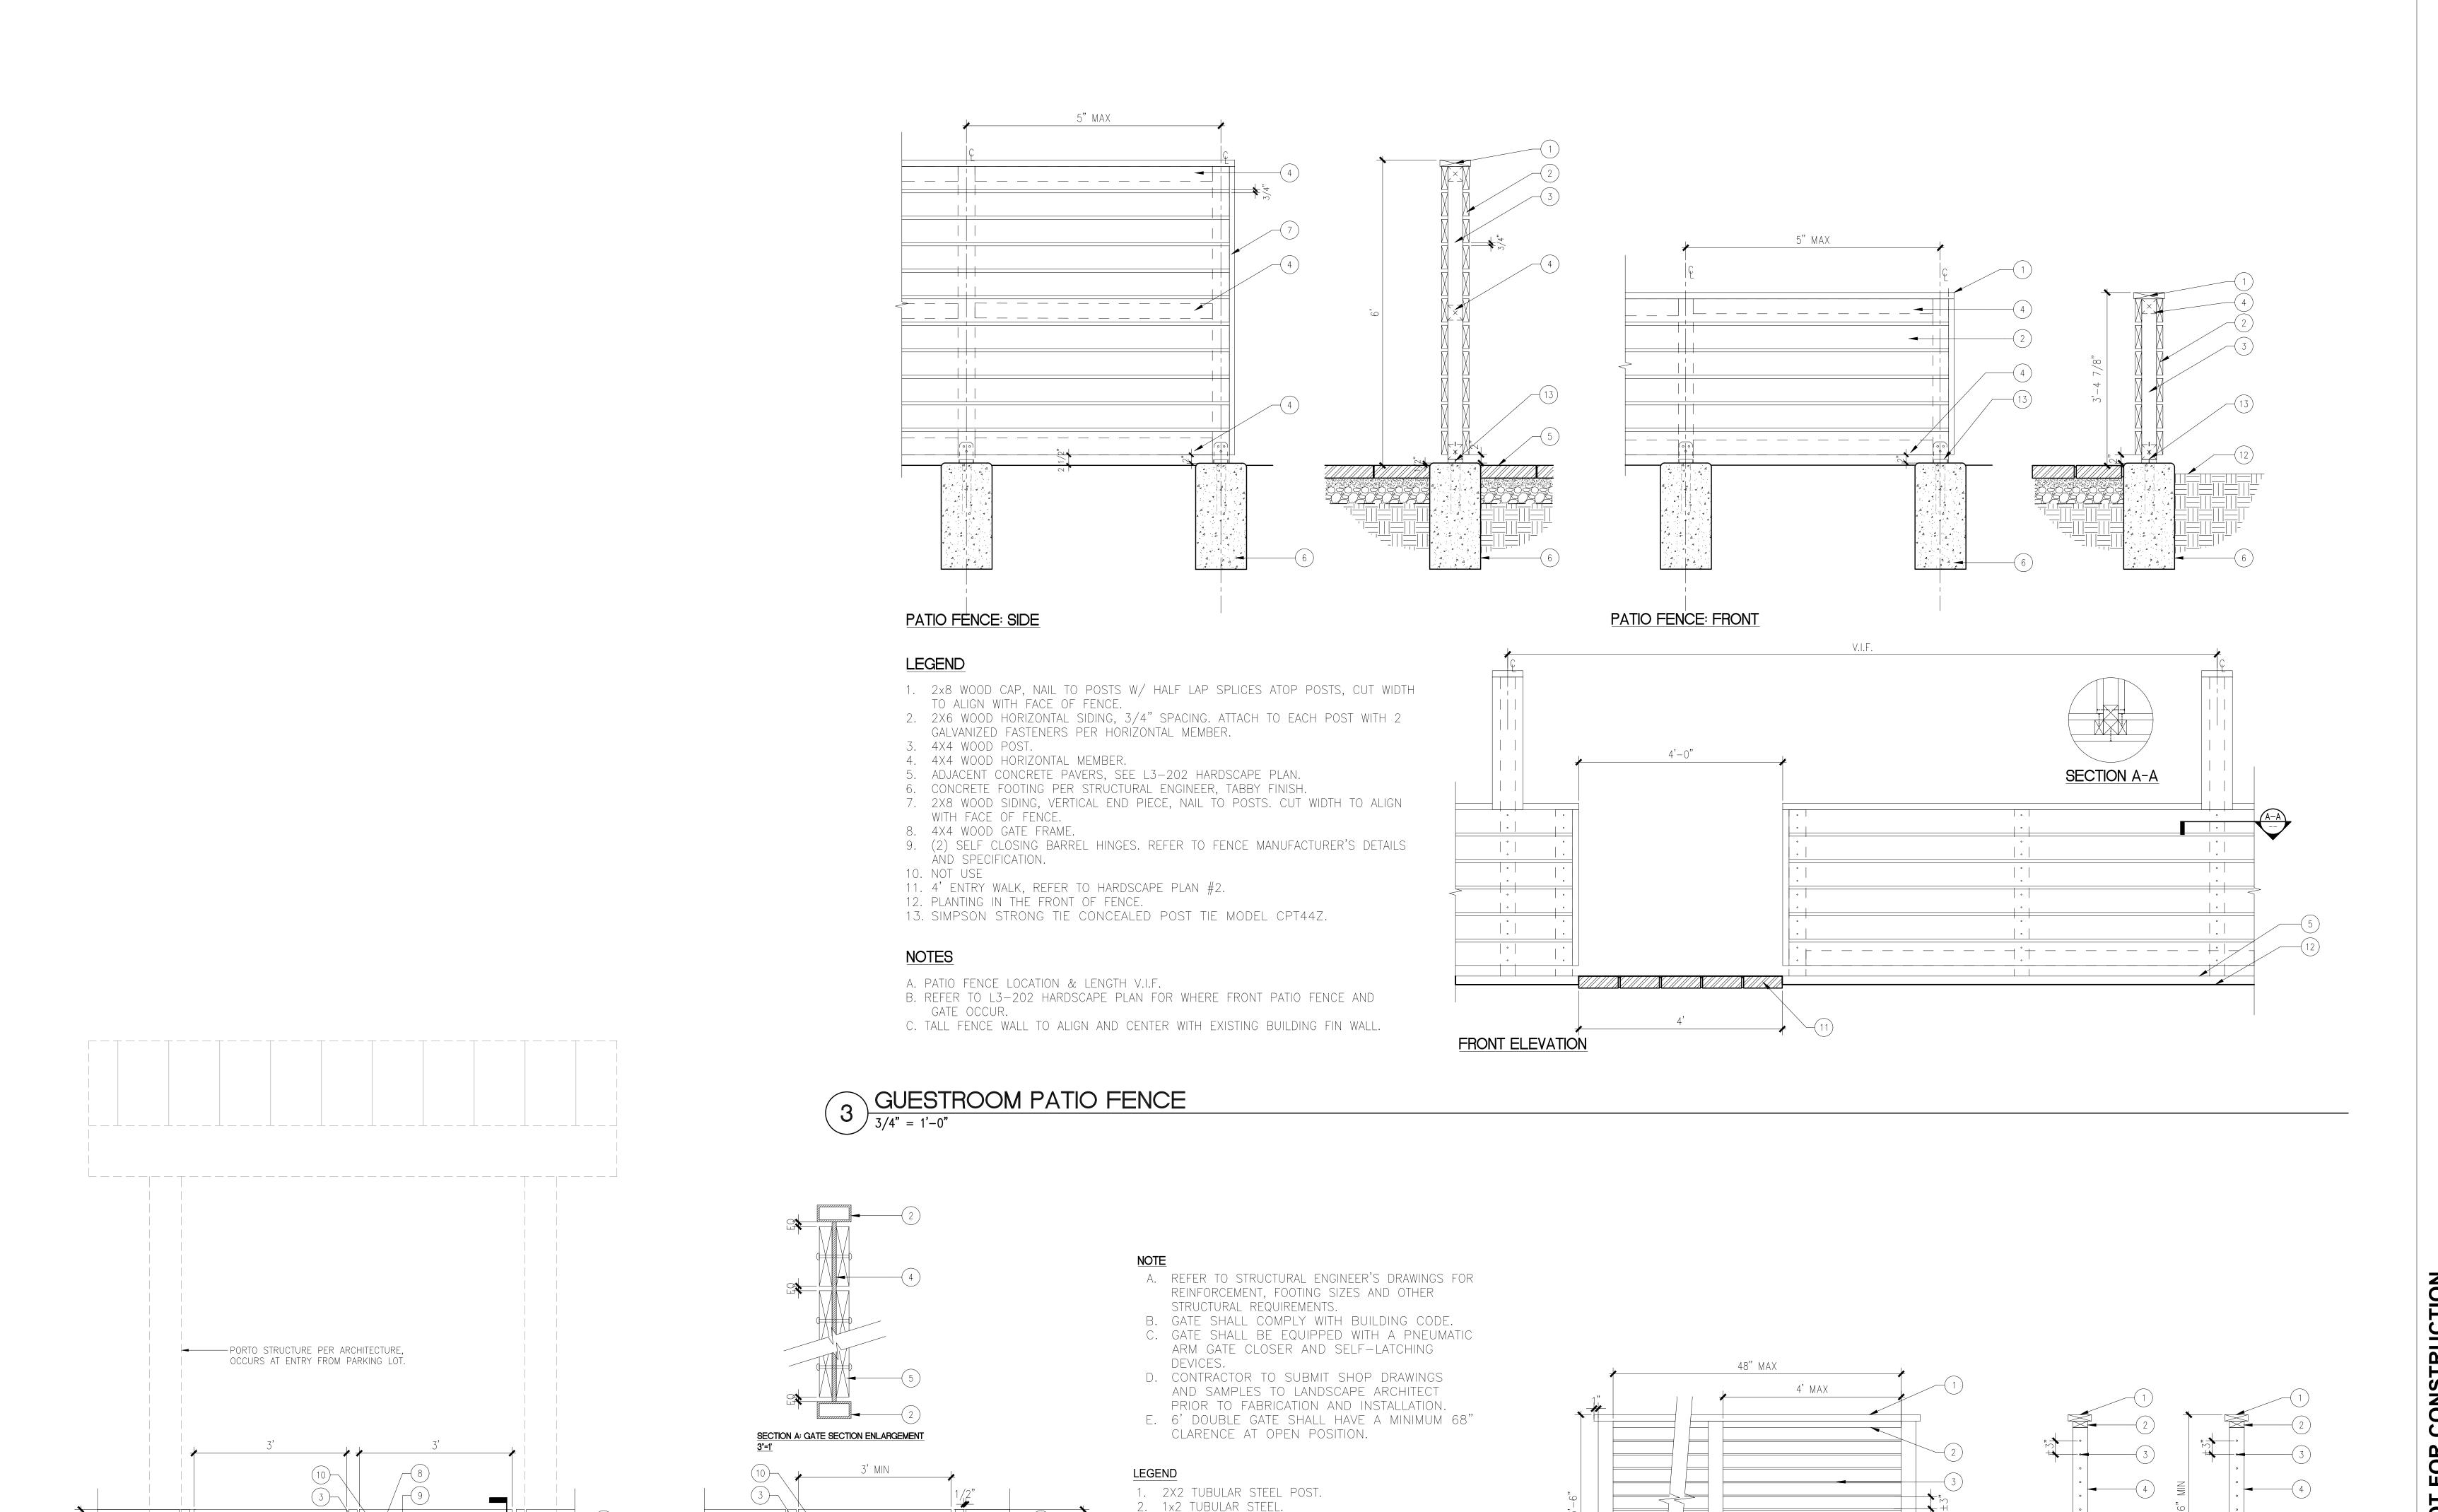


consultant

stamp | approval

HILTON HEAD ISLAND 1 SOUTH FOREST BEACH DRIVE HILTON HEAD, SC 29928

HARDSCAPE DETAILS



3. 2X6 TUBULAR STEEL.

SPECIFICATION.

6

WOOD GATE AT SMOKER

6' DOUBLE WOOD GATE

DOUBLE GATE OCCURS AT ENTRY FROM PARKING LOT & EVENT PAVILION.

WOOD FENCE GATE

3/4" = 1'-0"

4. (2) 1/4" THICK, 1" WIDE CORNER STEEL BAR,

7. (2) SELF CLOSING BARREL HINGES. REFER TO

11. CONCRETE FOOTING PER STRUCTURAL ENGINEER.

13. FINISH SURFACE, REFER TO HARDSCAPE PLAN.

FÉNCE MANUFACTURER'S DETAILS AND

9. PANIC BAR ON PAVILIÒN SIDE OF GATE.

5. 4X1 WOOD BOARD, BOLT ON TO THE STEEL BAR, EQUAL SPACING, CLEAR COAT NATURAL FINISH.

WÉLDÉD ON THE GATE FRAME.

6. ADJACENT WOOD FENCE POST.

8. METAL GATE HANDLE (LOCKABLE).

10. LOCKSET PER HOTEL OWNER.

12. PAVER FINISH SURFACE.


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no. date is:

08

SECTION: IN PLANTER/SAND SECTION: ON CONCRETE PAVER

key plan

Beach House
HILTON HEAD ISLAND
1 SOUTH FOREST BEACH DRIVE

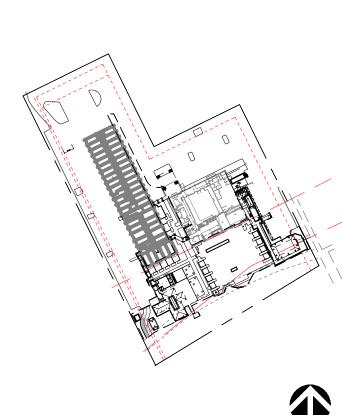project logo

HARDSCAPE DETAILS

sheet title

HILTON HEAD, SC 29928

project no. 212041 date 08/15/23 checked by: drawn by:

13-402

1 LANDSCAPE WOOD FENCE

3/4" = 1'-0"

9. SIMPSON STRONG TIE CONCEALED POST TIE MODEL

5. CONCRETE FOOTING, PER STRUCTURAL ENGINEER.

ADJACENT SAND/PLANTING FINISH GRADE.
 ADJACENT CONCRETE PAVERS FINISH GRADE.
 FINISH SURFACE, REFER TO HARDSCAPE PLAN.

1. CONTINUOUS 2X6 WOOD RAIL CAP, NAIL TO POSTS AND MITER AT

3. 3/8 DIA. STAINLESS STEEL 1X19 WIRE ROPE PER MANUFACTURER

SPECIFICATION & RECOMMENDATIONS. ±3" SPACING, EQUAL

**ELEVATION** 

ALL CORNERS.

SPACING. REJECT 4" SPHERE.

2. 2X4 WOOD RAIL.

4. 4X4 WOOD POST.

CPT44Z.


6' MAX. POOL FENCE ON INDIVIDUAL CONCRETE FOOTING

<u>LEGEND</u>

- 1. ALUMINUM FENCE, REFER TO FENCE SCHEDULE, SHEET L3-001, FOR MANUFACTURER MATERIAL, COLOR,
- AND FINISH. 2. INDIVIDUAL CONCRETE FOOTING PER STRUCTURAL ENGINEER, TABBY
- FINISH. 3. ADJACENT PLANTING AREA FINISH
- GRADE.
- 4. COMPACTED SOIL PER GEOTECHNICAL SOILS REPORT.
- 5. AMENDED SOIL PER AGRICULTURAL SOILS REPORTS.
- 6. STEPED FENCING WHEN ELEVATION CHANGE OCCURS.

- A. REFER TO STRUCTURAL ENGINEER'S DRAWINGS FOR REINFORCEMENT,
- FOOTING SIZES AND OTHER STRUCTURAL REQUIREMENTS. B. POUR CONCRETE FOOTINGS AND CURB AGAINST COMPACTED SOIL PER GEOTECHNICAL SOILS REPORT.


POOL FENCE ON SLOPE

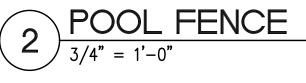

#### **LEGEND**

- 1. ALUMINUM POOL FENCE. REFER TO FENCE SCHEDULE, SHEET L3-001 FOR
- MANUFACTURER. MATERIAL, COLOR AND FINISH. 2. ALUMINUM GATE. REFER TO HARDSCAPE SCHEDULE, SHEET L3-001 FOR MANUFACTURER. MATERIAL, COLOR AND FINISH.
- 3. "TRU-CLOSE" HINGE. REFER TO FENCE MANUFACTURER'S DETAILS AND SPECIFICATION.
- 4. MCNICHOLS PERFORATED METAL, ITEM 1418312041, 1/8" ROUND ON 3/16" STAGGERED CENTERS, 40% OPEN AREA.
- 5. PERMEABLE CONCRETE PAVER. REFER TO HARDSCAPE PLAN, SHEET L3-201. 6. CONCRETE FOOTING PER STRUCTURAL ENGINEER.
- 7. METAL GATE HANDLE (LOCKABLE).
- 8. PANIC BAR ON POOL SIDE OF GATE.
- 9. LOCKSET PER OWNER, CARD KEY SYSTEM. 10. ALUMINUM GATE BOX FOR DOOR HARDWARE HOUSING (CARD READER, PANIC
- HARDWARE, ETC). 11. 4x4 ALUMINUM POST WITH 4X4 CAP WELDED TO TOP OF POST, GROUND SMOOTH TO ALIGN WITH ALL SIDES OF POST.

- A. REFER TO STRUCTURAL ENGINEER'S DRAWINGS FOR REINFORCEMENT, FOOTING SIZES AND OTHER STRUCTURAL REQUIREMENTS.
- B. GATE SHALL COMPLY WITH BUILDING CODE. C. GATE SHALL BE EQUIPPED WITH A PNEUMATIC ARM GATE CLOSER AND
- SELF-LATCHING DEVICES.
- D. CONTRACTOR TO SUBMIT SHOP DRAWINGS AND PRODUCT SAMPLES TO LANDSCAPE ARCHITECT PRIOR TO FABRICATION AND INSTALLATION.
- E. 6' DOUBLE GATE SHALL HAVE A MINIMUM 68" CLARENCE AT OPEN
- POSITION. F. ALL WELDS SHALL BE CONTINUOUS AND GROUND SMOOTH. FOR EACH DOUBLE GATE, BOTH GATES ARE IDENTICAL AND OPERATE UNDEPENDABLY.

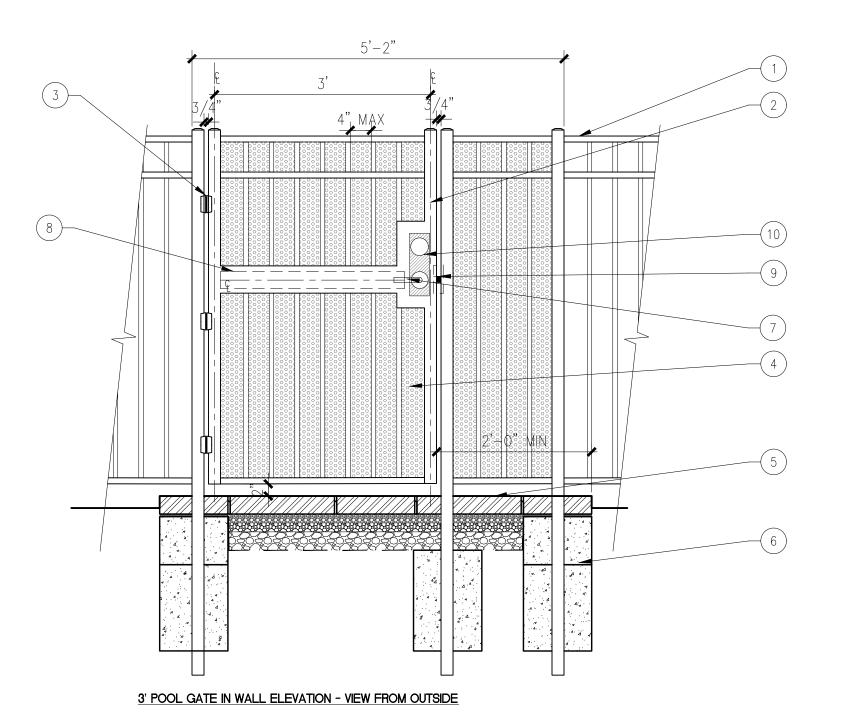

1 POOL GATE

3/4" = 1'-0"


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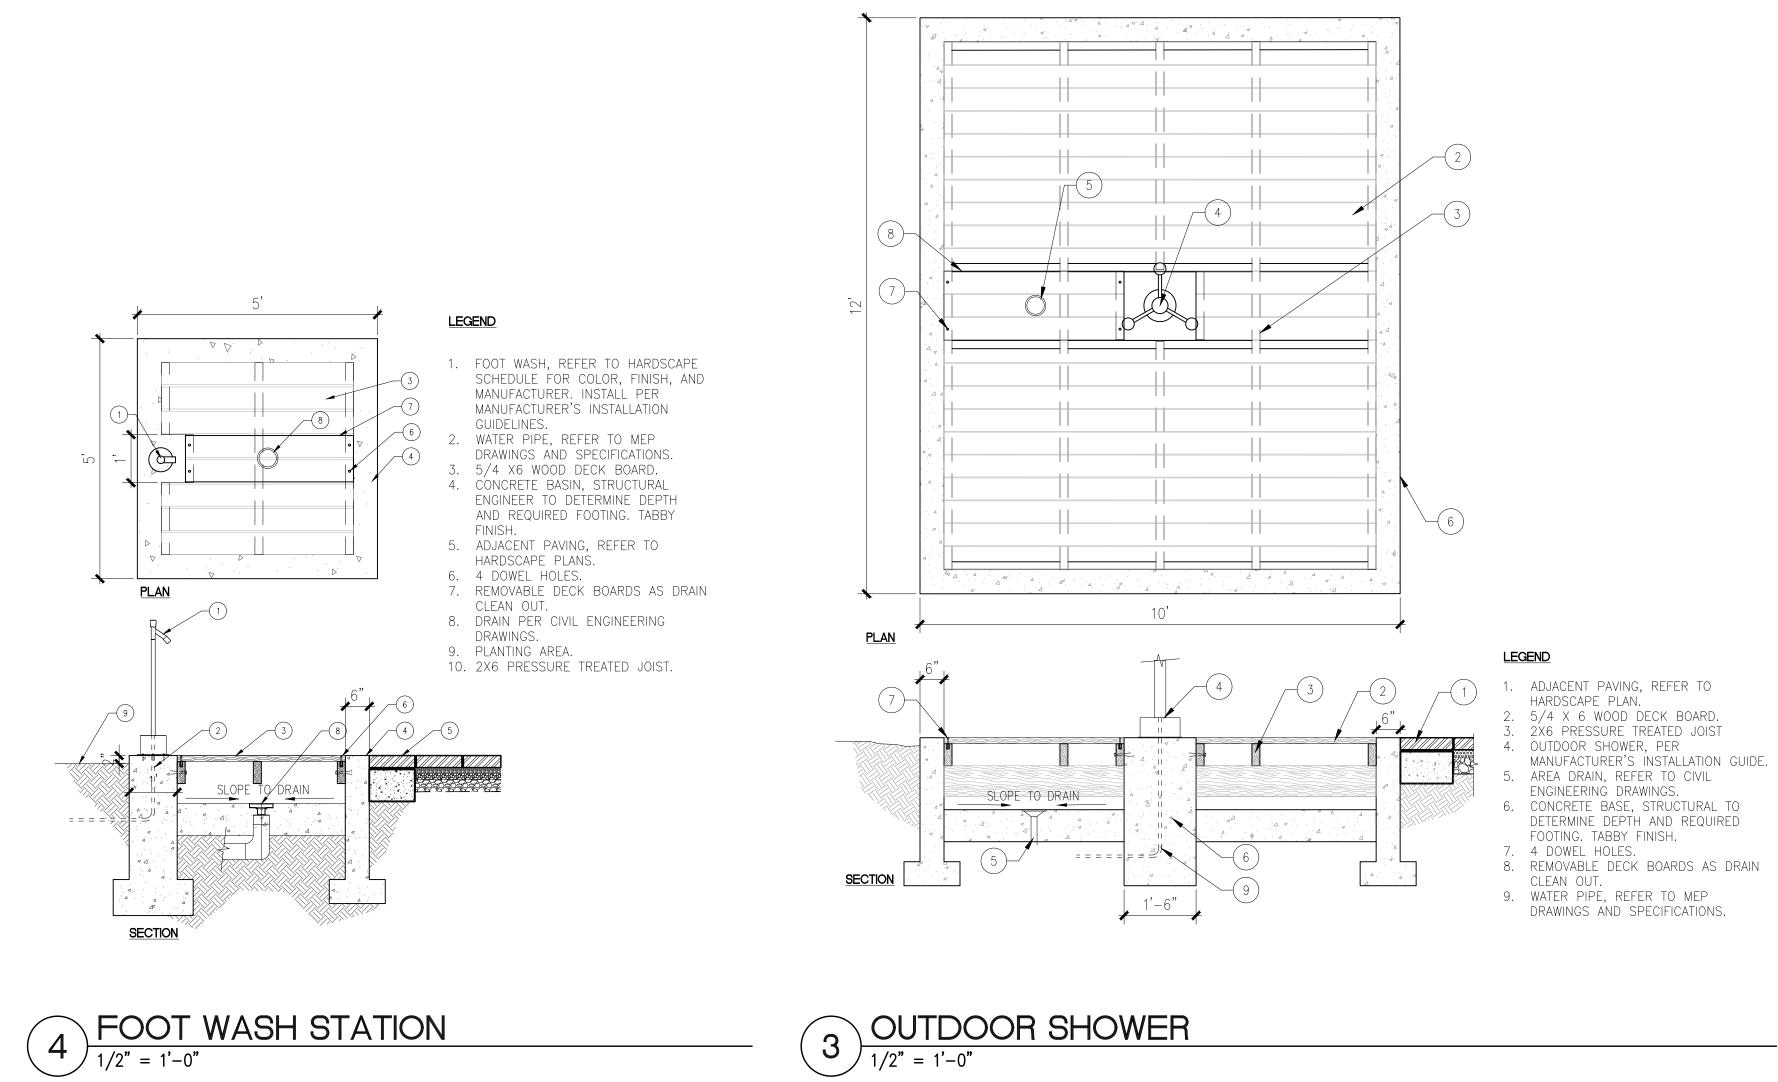
08

HILTON HEAD ISLAND 1 SOUTH FOREST BEACH DRIVE

HILTON HEAD, SC 29928 project logo


HARDSCAPE DETAILS sheet title



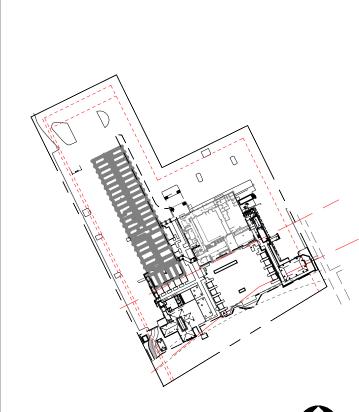


3 OUTDOOR SHOWER

1/2" = 1'-0"

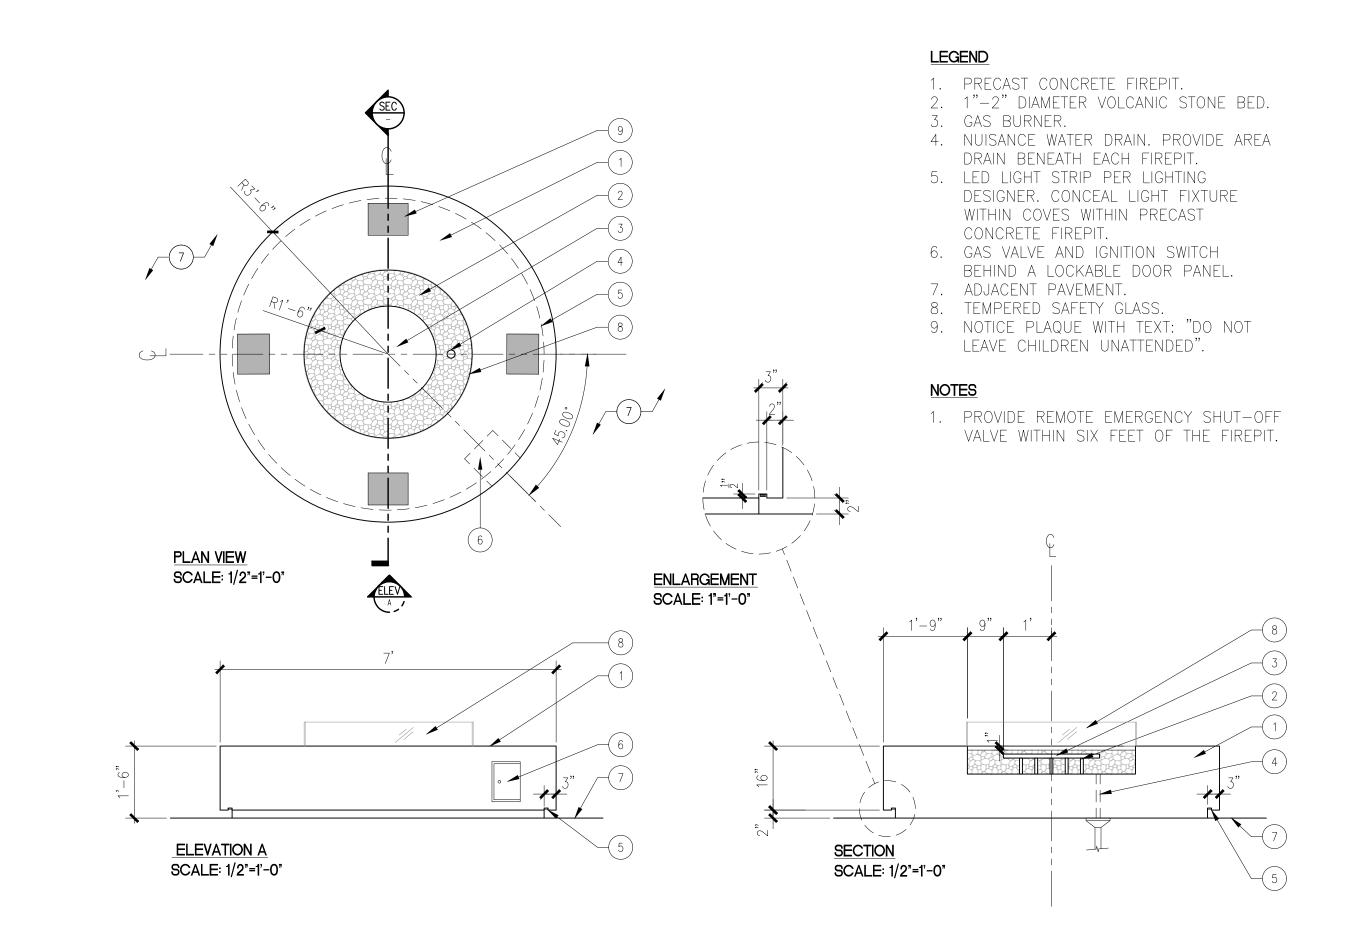

2 CIRCULAR FIRE PIT

1/2" = 1'-0"

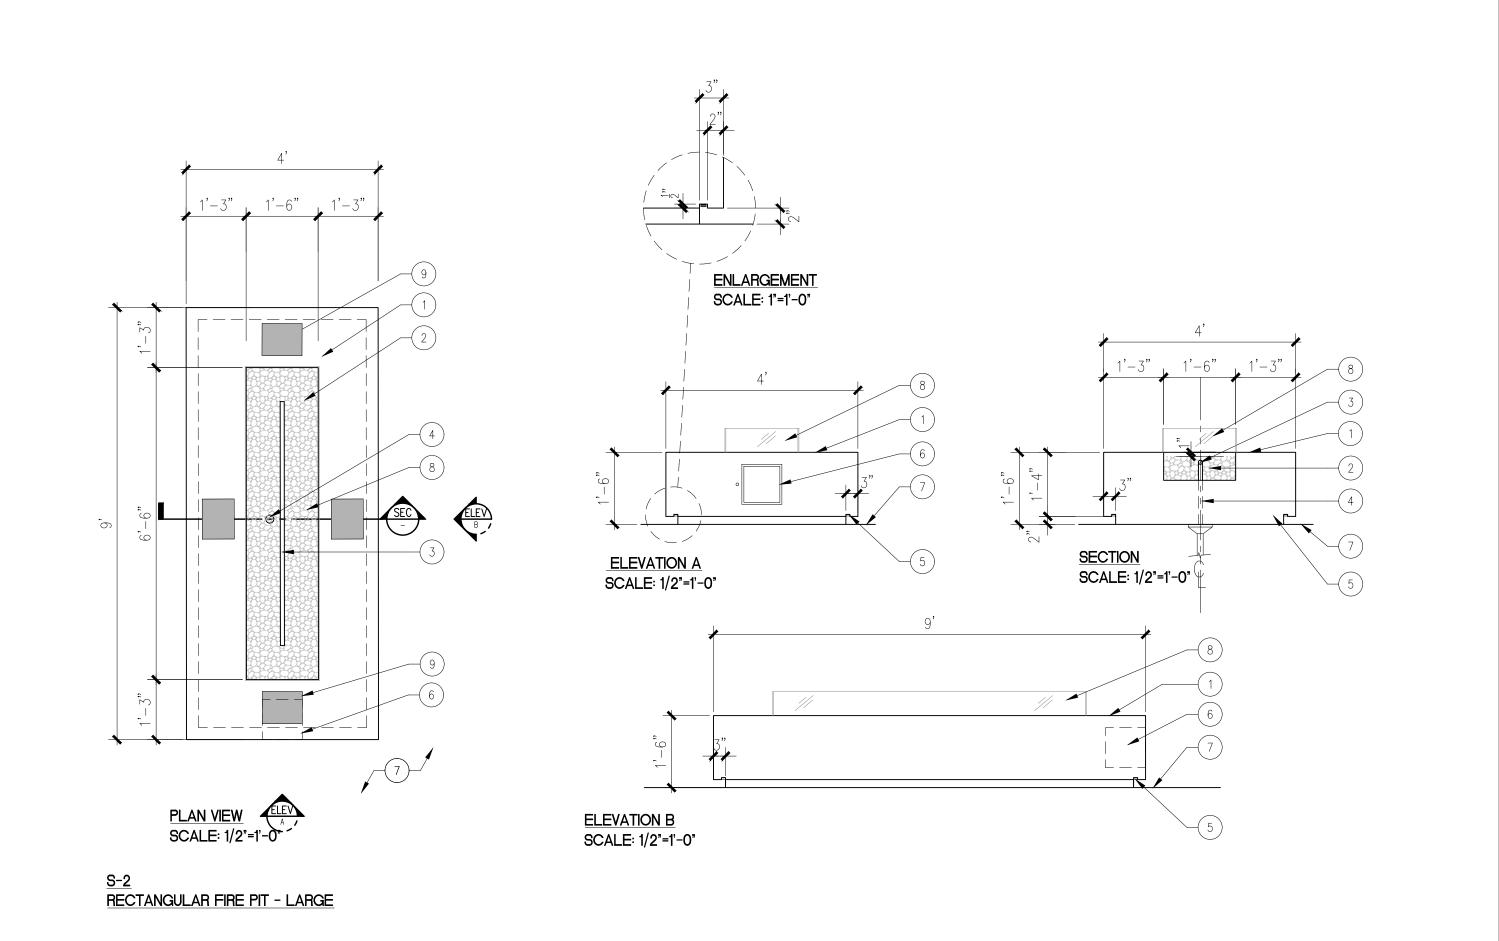

1 RECTANGULAR FIRE PIT 1/2" = 1'-0"


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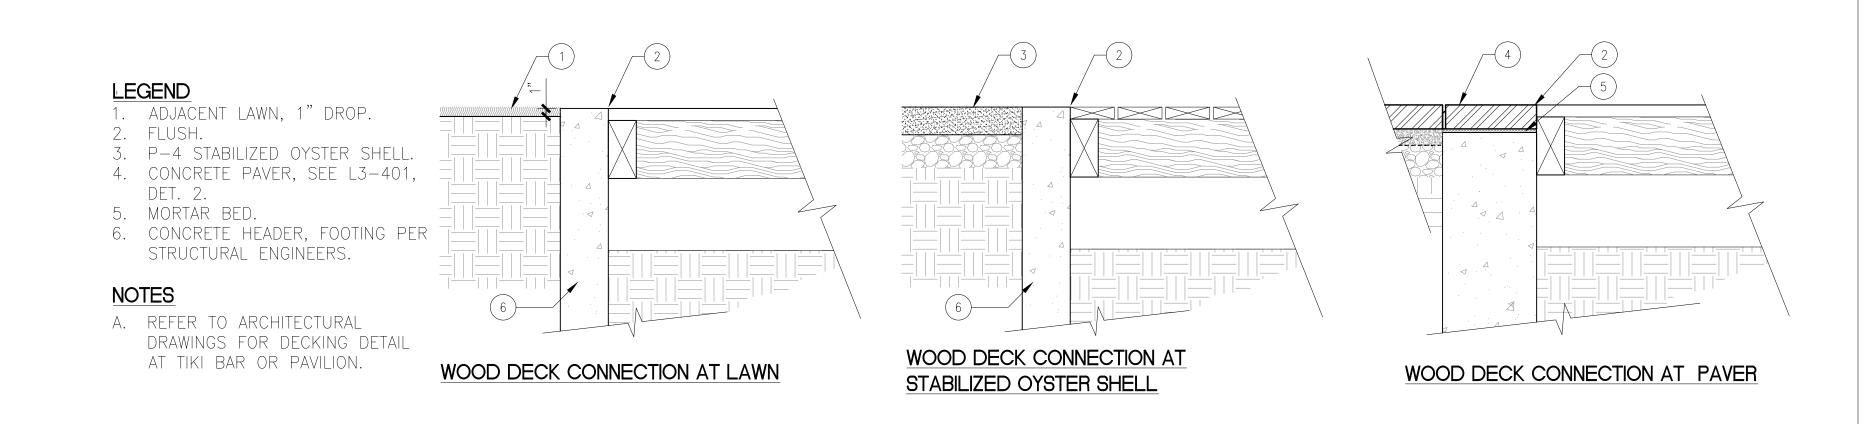


Beach House
HILTON HEAD ISLAND 1 SOUTH FOREST BEACH DRIVE HILTON HEAD, SC 29928

HARDSCAPE DETAILS

sheet title

## 3 SHUT-OFF PEDESTAL 1/2" = 1'-0"

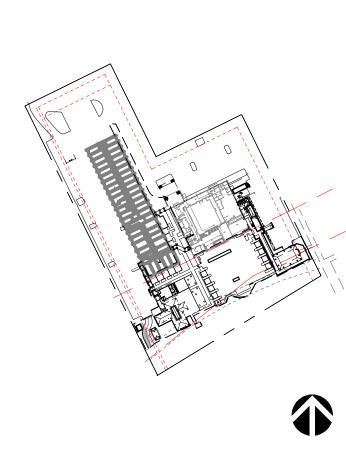


## WOOD DECK EDGE CONDITIONS 1" = 1'-0"


#### **LEGEND**

- 1. CANTILEVERED CONCRETE POOL COPING W/ 1/8" RADIUS.
  2. REFER TO SWIMMING POOL CONSULTANT'S DRAWINGS AND SPECIFICATION. REFER TO POOL SCHEDULE FOR MANUFACTURER, MODEL NUMBER, AND COLOR.
- 3. POOL PLASTER.
  4. POOL TILE. REFER TO POOL SCHEDULE FOR
- MANUFACTURER, COLOR, AND FINISH. 5. NOT USE.
- 6. ADJACENT PAVER, REFER TO DETAIL 2, SHEET L3-401. 7. WATER LEVEL.

- A. REFER TO POOL SCHEDULE FOR ALL COLORS, TYPES,
- FINISHES, AND MANUFACTURER REQUIREMENTS.

  C. ALL DIMENSIONS ARE FROM FACE OF TILE, UNLESS NOTED OTHERWISE.

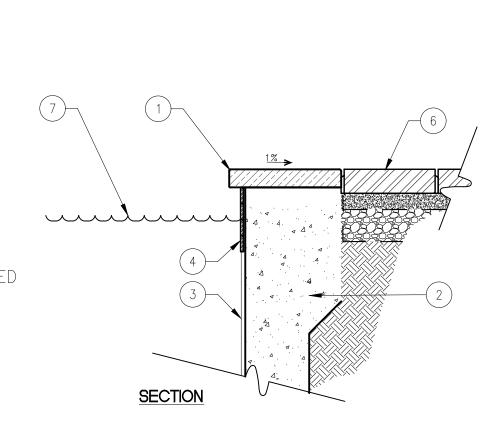

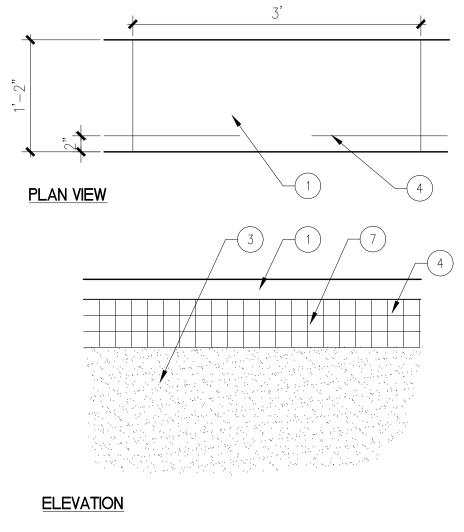



<u>PLAN</u>

1. EXISTING DUNE. 2. EXISTING WOOD LOG, SIZE AND LOCATION V.I.F. 3. 2X12 WOOD COVER BOARD WITH  $\pm 1/4$ " GAP. LAG BOLT **SECTION** 

A. EXISTING WOOD POST LOCATION, SIZE, AND HEIGHT TO BE

**NOTES** 

VERIFIED IN FIELD.

- NEW BOARDS TO LAG THROUGH SHIM. 4. PLANTING AREA FINISH GRADE. 5. CUT EXISTING WOOD LOG 2" BELOW THE TOP OF
- CLADDING.

6. 2X4 SHIM, LAG BOLT SHIM TO LOG.

4 DUNE WALL CLADDING

1" = 1'-0"

PRE-CAST POOL COPING

1" = 1'-0"


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issues | revisions

HILTON HEAD ISLAND

1 SOUTH FOREST BEACH DRIVE HILTON HEAD, SC 29928 project logo

HARDSCAPE DETAILS

sheet title
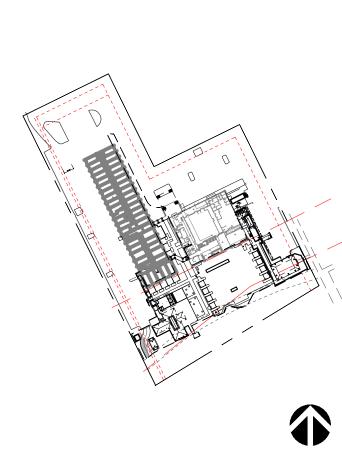
#### NOTES

- 1. ALL BASE INFORMATION HAS BEEN TAKEN FROM DRAWINGS PROVIDED BY WATG LANDSCAPE
- 2. SYSTEM HAS BEEN DESIGNED BASED ON A MINIMUM STATIC WATER PRESSURE OF 56 PSI.
- 3. CONTRACTOR SHALL FIELD VERIFY ON THE UPSTREAM SIDE OF THE BACKFLOW PREVENTER PRIOR TO ORDERING MATERIALS OR STARTING ANY IRRIGATION INSTALLATION AND NOTIFY CONSULTANT OF ANY DIFFERENCE FROM STATED PRESSURE. IF CONTRACTOR FAILS TO NOTIFY CONSULTANT HE ASSUMES FULL RESPONSIBILITY FOR ANY SYSTEM ALTERATIONS AS DIRECTED BY THE CONSULTANT.
- 4. INSTALL IRRIGATION SLEEVES UNDER ALL PAVED SURFACES PER THE FOLLOWING SCHEDULE: PIPE SIZE OR WIRE QUANTITY
  - **DRIP TUBING** 1-2" SCH 40 PVC 3/4" LATERAL 1" PRESSURE SUPPLY LINE 1-2" SCH 40 PVC 1-2" SCH 40 PVC 1 1/4" PRESSURE SUPPLY LINE 1-3" SCH 40 PVC 1 1/2" PRESSURE SUPPLY LINE 1-3" SCH 40 PVC 1-6" SCH 40 PVC 1-2" SDR 35 PVC
  - 2 1/2" PRESSURE SUPPLY LINE 1-20 CONTROL WIRES 1-3" SDR 35 PVC 1-40 CONTROL WIRES
- 5. INSTALL DRIP EMITTER TUBING AS SHOWN ON PLANS AND AS DESCRIBED BY CONSTRUCTION
- 6. SECURE DRIP TUBING AT A CONSISTENT ROW SPACING WITH NETAFIM #TLS6 SOIL STAPLES OR 6" JUTTE MATTE STAPLES NO GREATER THAN 36" ALONG LENGTH OF TUBING. USE TWO STAPLES IN AN 'X' PATTERN OVER ANY CHANGES IN DIRECTION OF TUBING.
- 7. DRIP TUBING TO BE LAID DOWN SO THAT EMITTER OUTLETS ARE STAGGERED ON A TRIANGULAR SPACING PATTERN.
- 8. DRIP TUBING SHALL BE INSTALLED 1" BELOW MULCH LAYER AS DETAILED. SUPPLY AND EXHAUST HEADERS SHALL BE INSTALLED BELOW GRADE AT DEPTHS SHOWN.
- 9. A DIAGRAM OF THE IRRIGATION PLAN SHOWING HYDROZONES SHALL BE KEPT WITH THE IRRIGATION CONTROLLER FOR SUBSEQUENT MANAGEMENT PURPOSES.

- 2. Refer to Sheet L4-101 for Irrigation Plan

**NOTE:** IRRIGATION LAYOUT TO BE UPDATED PER FIELD CONDITIONS & FINAL DESIGN.

Aqua Commercial Irrigation
810 Los Vallecitos Blvd., Suite 204
San Marcos, California 92069
Ph: (760)750-1900 Fax: (760)750-1999

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no. date

issues | revisions

key plan

1 SOUTH FOREST BEACH DRIVE HILTON HEAD, SC 29928


IRRIGATION SCHEDULES AND NOTES

L4.001

1. Refer to Sheet L4-001 for Irrigation Schedule and Notes.

3. Refer to Sheets L4-401 & L4-402 for Irrigation Details.

4. Refer to Book Specifications for Irrigation Specifications.

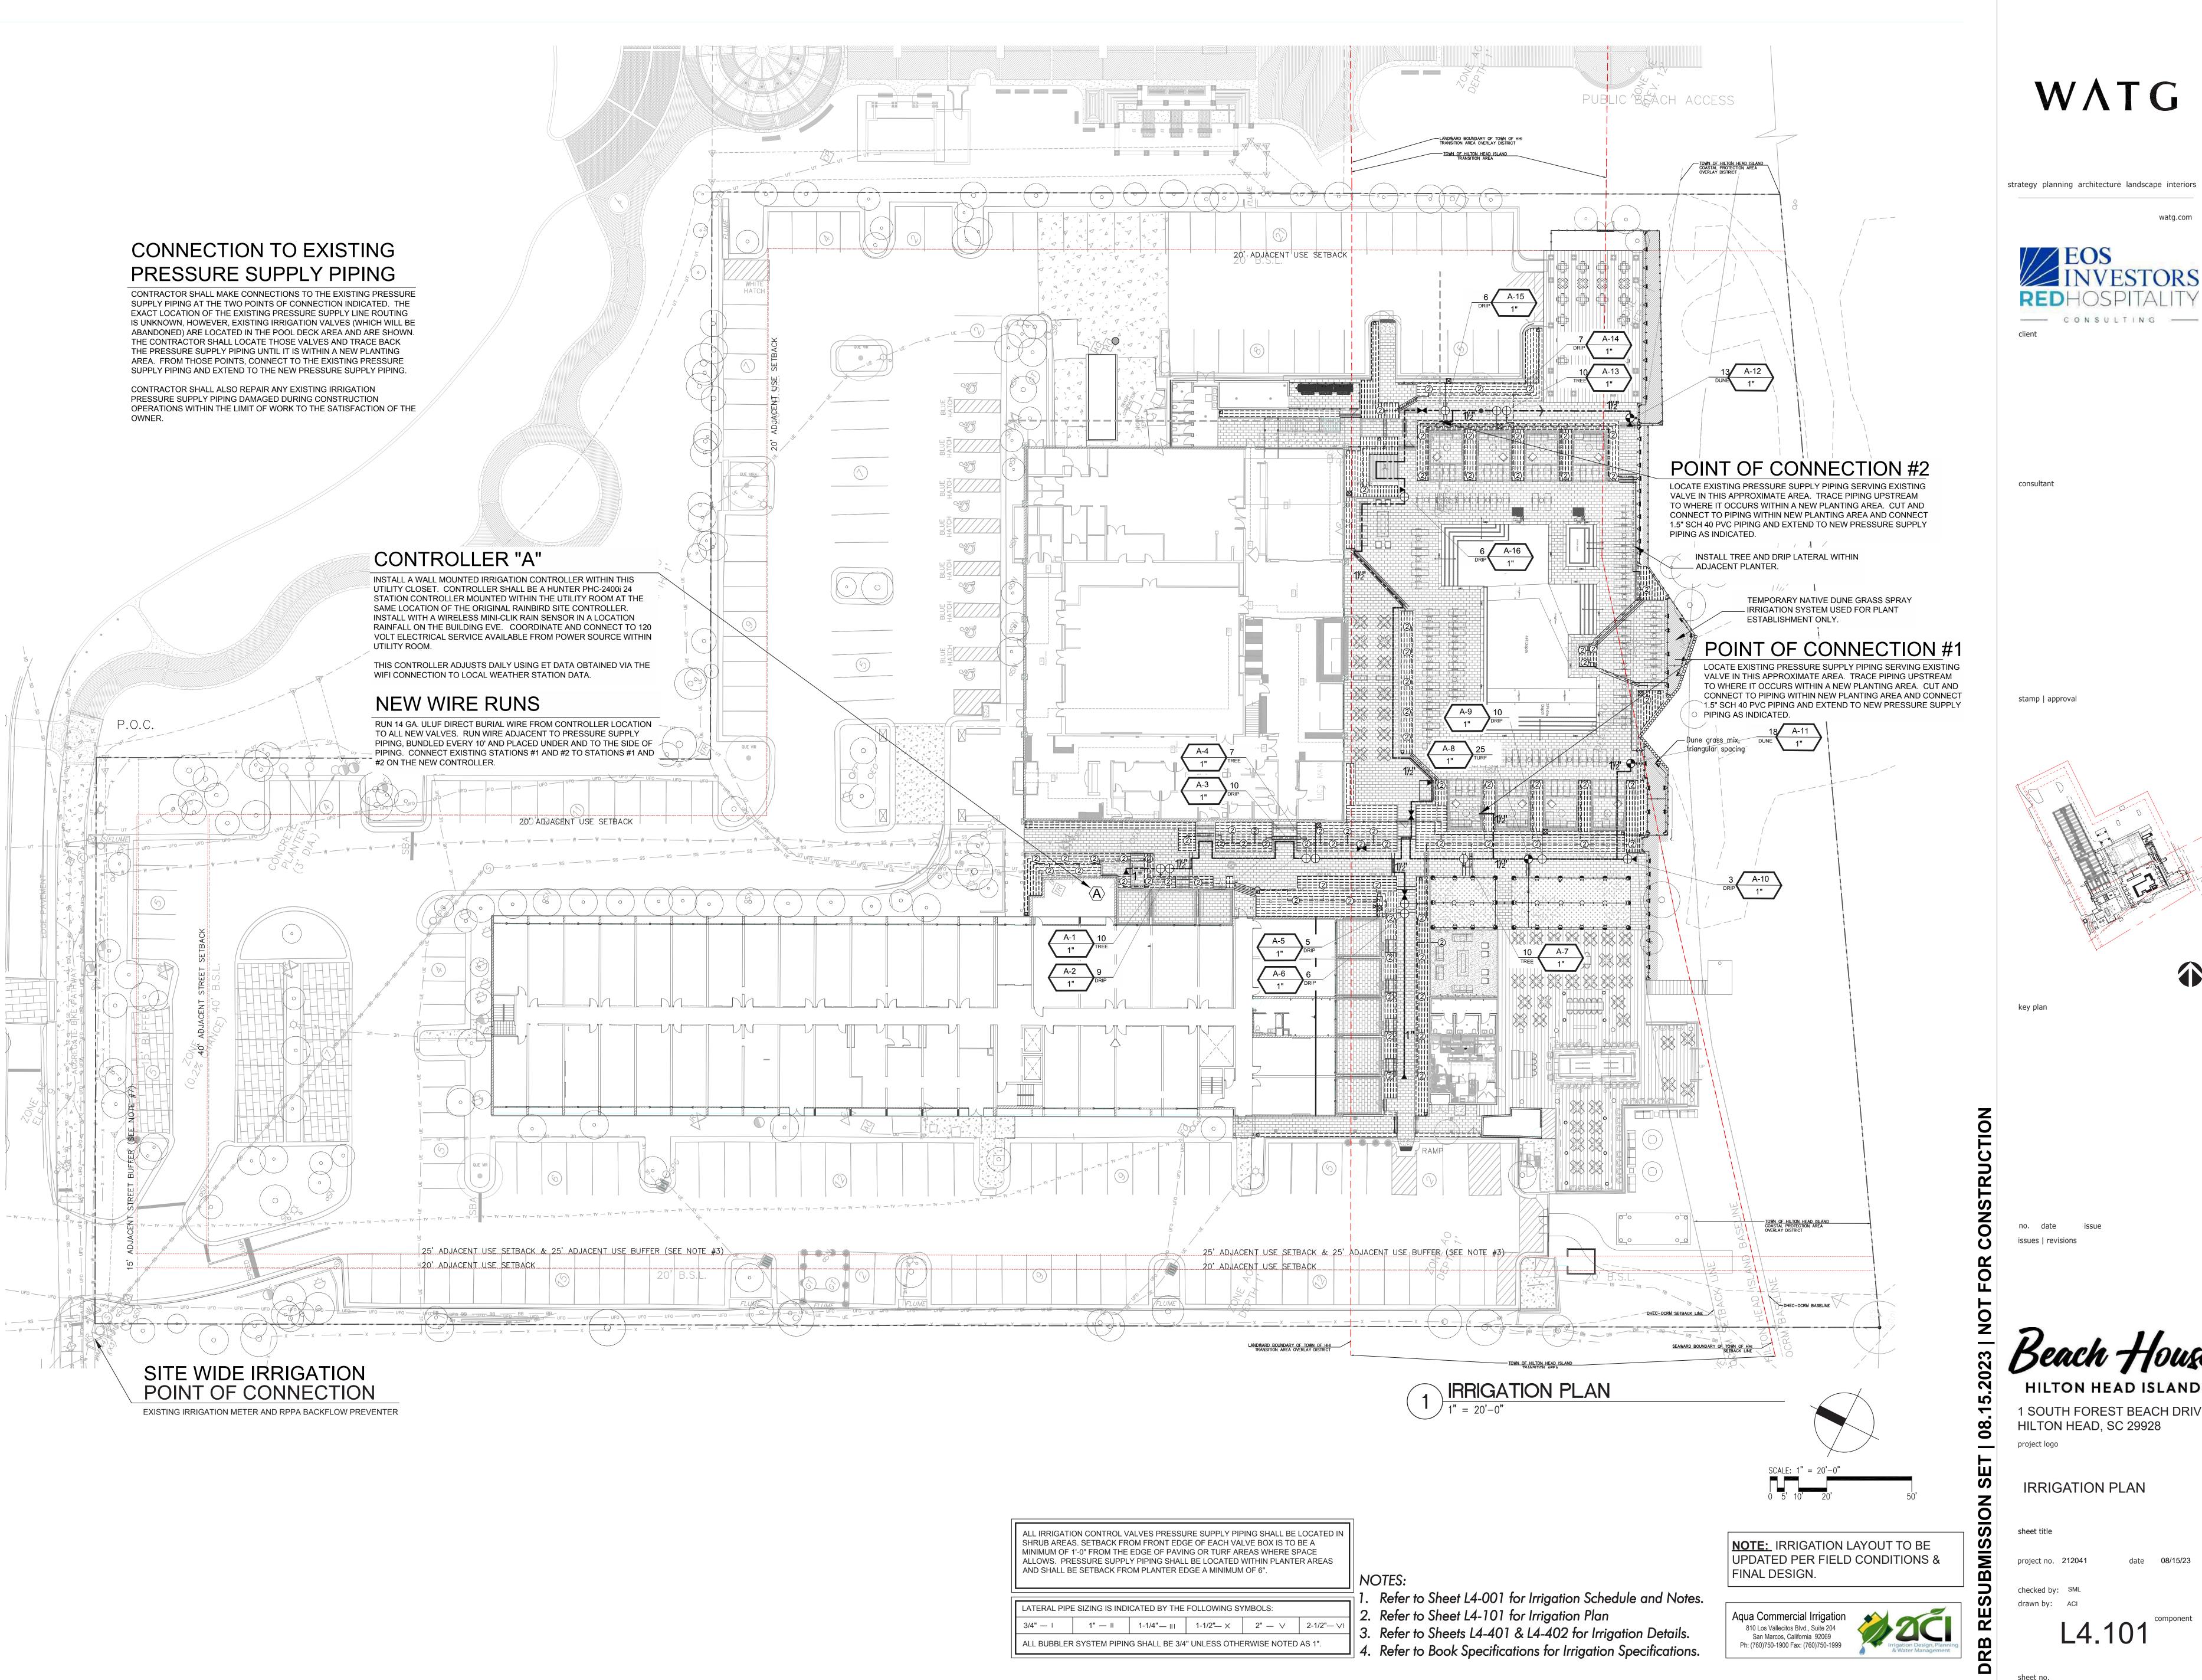


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consultant

1 SOUTH FOREST BEACH DRIVE

HILTON HEAD, SC 29928

**IRRIGATION PLAN** 

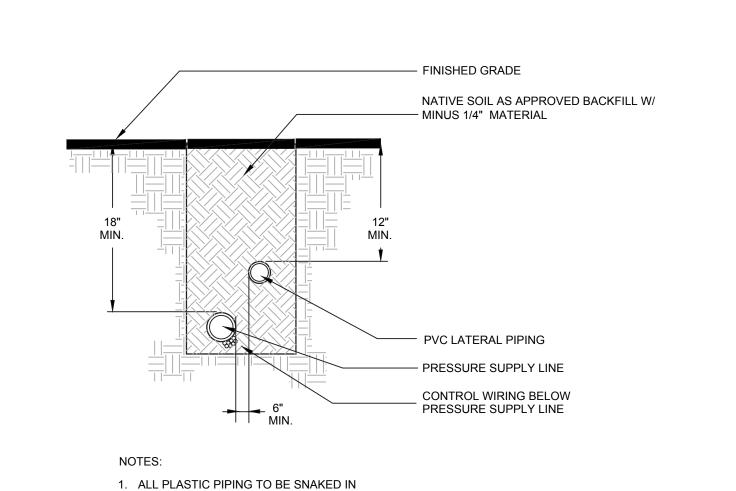

N.T.S.

1/2" PVC SCH 40 SUPPLY RISER

TRENCH FOR SUPPLY & EXHAUST HEADERS

3/4" X 1/2" X 3/4", S x S x T

PVC SCH 40 TEE OR ELL

3/4" PVC SCH 40 SUPPLY OR EXHAUST HEADER

N.T.S. 6 HEADER MANIFOLD

STAINLESS STEEL CLAMP (2)

1-1x3" SCH.80 PVC NIPPLE

1" SCH 80 FIPxFIP 90 ELL

- 1" SCH.80 PVC FIPxFIP

- 1"x12" SCH.80 PVC NIPPLE

SUPPORT PIPE

1/2" x 36" GALVANIZED STEEL

— 1" SCH. 80 PVC FIPxFIP 90 ELL

1-1"x3" SCH.80 PVC NIPPLE

PRESSURE SUPPLY LINE

SERVICE TEE - SOLVENT WELD OR

GASKETED FITTING. REFER TO

TECHNICAL SPECIFICATIONS

**TRENCHES** 

10" ROUND VALVE BOX

FINISH GRADE

POTABLE CAP -

3/4" SCREENED GRAVEL SUMP - 1 CU. FT.

QUICK COUPLING VALVE

1" SCH 80 NIPPLE ----

BRAND "QC" INTO VALVE BOX


LID. REFER TO TECHNICAL SPECIFICATIONS.


VALVE BOX TO REST ON GRAVEL SUMP.


2. BUNDLE AND TAPE WIRING AT 10' INTERVALS.

3. INSTALL ALL CONTROL AND COMMON WIRING

TO THE SIDE AND BELOW THE PRESSURE

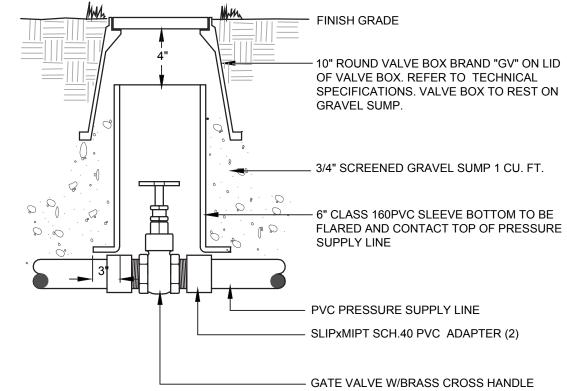

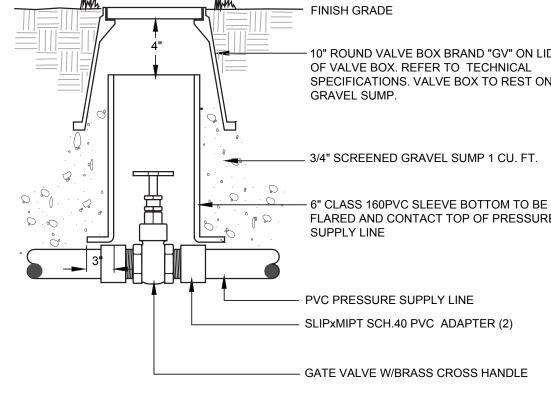

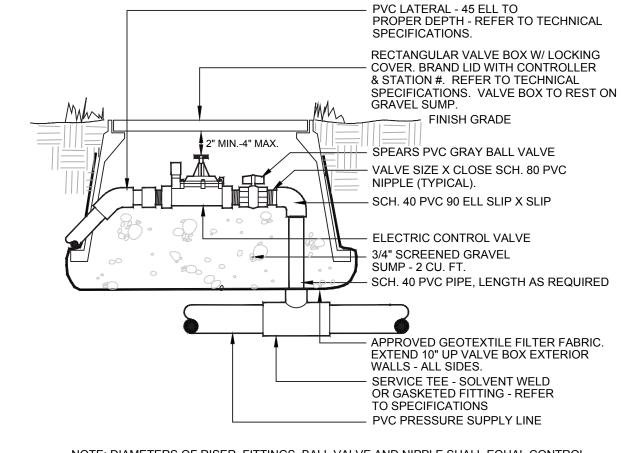

NOTE: DIAMETERS OF RISER, FITTINGS, BALL VALVE AND NIPPLE SHALL EQUAL CONTROL VALVE DIAMETER. LOOP ALL SPARE WIRES FROM CONTROLLER INSIDE EACH VALVE BOX-12" DIAMETER LOOP (MIN.) ALL WIRING TO BE INSTALLED PER LOCAL CODE. PROVIDE EXPANSION COILS AT EACH WIRE CONNECTION W/IN VALVE BOX (WRAP AROUND 1/2" PIPE 15 TIMES, REMOVE PIPE) COMPACT SOIL AROUND VALVE BOX TO SAME DENSITY AS UNDISTURBED ADJACENT SOIL.

**HUNTER ECO-ID-12** 

- POP-UP DRIP

FLUSH POINT.

INDICATOR AND

TWO (2) MARLEX

STR 90° ELLS

\_1/2" SCH 80 PVC

HUNTER RZWS-10-25-CV-R 10"DEEP ROOT WATERING SYSTEM ASSEMBLY WITH SWING JOINT.

— 1" x 1" x 1/2" SxSxT SCH 40 PVC TEE

— 1/2" SCH 40 PVC LATERAL PIPE

\_\_\_ 1/2" SCH 40 S x T ELL FITTING

DEEP ROOT WATERING SYSTEM

ASSEMBLY WITH SWING JOINT.

SYMBOL: (2)

REFER TO DETAIL # 9, THIS SHEET FOR 2-WIRE PATH, CONDUIT, GROUNDING AND DECODER REQUIREMENTS. CONTROL VALVE ASSEMBLY

IN-LINE EMITTER TUBING -RAINBIRD XFS-06-18-XX SHRUBS

INSTALL AT THE QUANTITIES

PLANTING BED MULCH (SHRUB BEDS) OR AMENDED TURF PLANTING MEDIUM

EXHAUST HEADER
TERMINATION OF SYSTEMS
|& RISERS AS REQ'D.

PLANTING PIT

ROOTBALL

RWS-S-B-C-1401 10" DEEP ROOT

WATERING SYSTEM ASSEMBLY

WITH SWING JOINT.

1" LATERAL PIPING

FINISH SOIL GRADE

GRATED CAP

CHECK VALVE

SWING JOINT ASSEMBLY

LATERAL; TEE OR

ELL/PIPE SCH. 40 PVC.

PURPLE RECYCLED

(PART OF DEEP ROOT

WATERING ASSEMBLY

1/2" PVC SCH 40 SUPPLY OR EXHAUST – HEADER

DESCRIBED ON THE PLAN:

AGRIFIM SMART-LOC

ADAPTER FITTING

1/2" S x T sch 40 ELL (TYPICAL)

TRENCH BOTTOM

EMITTER TUBING EXHAUST

PLAN

1/2" SCH 40 TEE TO

TWO (2) MARLEX STR 90° ELLS

**ECO-INDICATOR ASSEMBLY** 


N.T.S.

consultant

WATG

strategy planning architecture landscape interiors

- CONSULTING -

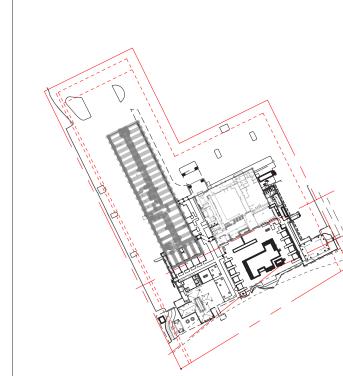

key plan

no. date

issues | revisions

1 SOUTH FOREST BEACH DRIVE HILTON HEAD, SC 29928

**IRRIGATION DETAILS** 

checked by: SML

2. Refer to Sheet L4-101 for Irrigation Plan

Aqua Commercial Irrigation

4. Refer to Book Specifications for Irrigation Specifications.

SET BOTTOM OF CAP AT GRADE LOCATE 6" AWAY FROM WALLS AND OTHER VERTICAL SURFACES. CURB AND GUTTER OR SIDEWALK WHERE APPLICABLE - 12" HI-POP SPRAY HEAD — 1/2" X 4" SCH.80 PVC NIPPLE - 1/2" MIPxFIP MARLEX 90 ELL (2) — 1/2" X 8" SCH.80 PVC NIPPLE — PVC LATERAL - RECYCLED PURPLE — SOLVENT WELD SCH.40 PVC FITTING — 1/2" MIPxFIP MARLEX 90 ELL

VALVE INSTALL ASSEMBLY TO REST ON GRAVEL SUMP. SUMP TO BE LINED WITH ONE CONTINUOUS PIECE OF

GEOTEXTILE FILTER FABRIC EXTENDING FABRIC 10" UP ALL EXTERIOR SIDES OF VALVE BOX. VALVE BOX TO BE SET

FLUSH WITH FINISH GRADE. VALVE ASSEMBLY TO BE CONTAINED AND CENTERED WITHIN VALVE BOX. NO PART OF

ASSEMBLY TO CONTACT BOX LID. DO NOT CUT BOX. PROVIDE 12" DIAMETER LOOP (MIN.) OF SPARE WIRES FROM

- 3/4" PVC LATERAL DRIP HEADER LINE

PER IRRIGATION SCHEDULE

REDUCER

- 1" FPT x SLIP COUPLING W/ 1" X 3/4" SLIP

RAINBIRD DRIP VALVE CONTROL ZONE KIT

STANDARD RECTANGULAR VALVE BOX W/

IDENTIFICATION REQUIREMENTS. VALVE

- 3/4" SCREENED GRAVEL SUMP - 2 CU. FT.

PVC PRESSURE SUPPLY LINE

-APPROVED GEOTEXTILE FILTER FABRIC.

INSTALL TUBING 3" FROM CURB OR

\_ RAINBIRD XFS-09-18-XXX IN-LINE **EMITTER TUBING EMITTERS AT 12"** 

RAINBIRD XFF-MC-050 ADAPTER -

— 12" TUBE SPACING (TYPICAL).

— 3/4" END PIPE HEADER

LINE FLUSHING VALVE

CONTINUATION OF SYSTEM

FITTING (RAINBIRD TUBING TO PVC

PVC EXHAUST HEADER ASSEMBLY &

INTERVALS

FITTING)

EXTEND 10" UP VALVE BOX EXTERIOR

-1" SCH. 40 PVC PIPE, LENGTH AS REQUIRED

LOCKING LID. REFER TO TECHNICAL

SPECIFICATIONS FOR BRANDING

BOX TO REST ON GRAVEL SUMP.

- 1" SCH 80 PVC BALL VALVE

- 1" STREET 90° SxT SCH 40

- PVC SERVICE 90° SXS SCH 40

WALLS - ALL SIDES.

18"

(EMITTERS)

RAINBIRD XFF-TEE OR XFF-ELBOW

- CURB, WALK, WALL OR FENCE

IN-LINE EMITTER TUBING LAYOUT

PRECISION 'O' SERIES SPRAY NOZZLE

OR MP ROTATOR NOZZLE

NOTE: TUBING SHALL BE STAPLED TO THE SOIL SURFACE 3' O.C. ALONG EACH TUBING LENGTH

FOR SURFACE MOUNTED CONNECTIONS

CONTROLLER INSIDE EACH VALVE BOX. VALVE BOXES TO BE SPACED EVENLY FROM WALK OR CURB AND FROM

DRIP VALVE ASSEMBLY

EACH OTHER. BOLT HOLE IN BOX TO FACE CURB OR WALK.

1" VALVE ASSEMBLY —— (SEE DETAIL #5, THIS SHEET)

1" PVC SCH 40 SUPPLY HEADER

→ WALK OR CURB →

WITH 6" LONG SOIL STAPLES OR 6" LONG JUTTE MATT STAKES.

NOTE: 12" POP-UP SPRAY HEADS TO BE PLACED FOUR FEET (MIN) FROM USE TEFLON TAPE ON ALL THREADED CONNECTIONS UNLESS SPECIFICALLY

6" POP-UP SPRINKLER

6" POP-UP SPRAY HEAD OR ROTOR. CAP BLACK IN COLOR W/ PURPLE SEAL (SPRAY HEAD) PURPLE FOR WALK OR CURB. 3. FINISH GRADE. 4. LATERAL LINE PIPE. 5. SCH 40 PVC SxSxT TEE. 6. MARLEX 90° STREET ELL. 7. PVC SCHEDULE 80 NIPPLE - 12" LONG. \* 3" IN TURF AREAS. 6" IN PLANTING BEDS. NOTE: USE TEFLON TAPE ON ALL

INDICATED BY THE MANUFACTURER OF THE COMPONENT TO NOT USE TEFLON TAPE.

**NOTES:** 1. Refer to Sheet L4-001 for Irrigation Schedule and Notes.

810 Los Vallecitos Blvd., Suite 204 3. Refer to Sheets L4-401 & L4-402 for Irrigation Details. San Marcos, California 92069 Ph: (760)750-1900 Fax: (760)750-1999

- FINISH GRADE 6" ROUND VALVE BOX BRANDED WITH THE LETTERS "AR" AIR/VACUUM RELIEF VALVE 1/2" PVC COUPLING 1/2" SCH 80 PVC (LENGTH AS REQUIRED) BRICK SUPPORTS (3) -LATERAL PIPE PEA GRAVEL APPROXIMATE LOCATION SHOWN ON PLAN. INSTALL AT HIGHEST POINT IN EACH DRIP SYSTEM. AIR RELIEF VALVE

QUICK COUPLING VALVE

N.T.S.

EMITTER TUBING INTAKE

RAINBIRD XFS-06-18-XXX IN-LINE EMITTER TUBING

RAINBIRD XFF-MC-050 ADAPTER - FITTING (RAINBIRD

MID-LAYOUT SUPPLY HEADER
 & RISERS AS REQ'D, 18" O.C..

TRENCH BOTTOM

EMITTERS AT 12" INTERVALS

TUBING TO PVC FITTING)

1/2" SCH 40 FPT TEE

PLANTING BED MULCH

(TYPICAL)

NOTE: MATCH INLET SIZE FOR SWING JOINT ASSEMBLY -  $\frac{1}{2}$ " FOR SPRAY HEADS,  $\frac{3}{4}$  FOR ROTORS

**NOTE:** IRRIGATION LAYOUT TO BE UPDATED PER FIELD CONDITIONS & FINAL DESIGN.

DEEP ROOT WATERING ASSEMBLY

N.T.S.

#### PART I - GENERAL

- 1.01 WORK INCLUDED Work of this Section generally includes provision of an underground irrigation system including the following:
- Trenching, stockpiling excavation materials, and refilling trenches. Complete system including but not limited to piping, valves, fittings, heads, controller wiring and final adjustments to insure efficient coverage as determined by Consultant.
- Replacement of unsatisfactory materials. Clean up, inspection, and approval.

#### 1.02 REFERENCES

- Perform Work in accordance with requirements of Conditions of the Contract and division 01 -General Requirements as well as provisions of all applicable laws, codes, ordinances, rules, and
- Conform to requirements of reference information listed below except where more stringent requirements are shown or specified in Contract Documents. American Society for Testing and Materials (ASTM)-Specifications and Test Methods specifically referenced in this Section. Underwriters Laboratories (UL) - UL Wires and Cables.

#### 1.03 QUALITY ASSURANCE

- Special Requirements:
- Tolerances Specified depths of pressure supply lines and laterals and pitch of pipes are minimums. Settlement of trenches is cause for removal of finish grade treatment, refilling, recompaction, and repair of finish grade treatment. Coordination With Other Contracts - Protect, maintain, and coordinate Work with Work
- under other Sections. Damage To Other Improvements - Contractor shall replace or repair damage to grading, utilities, soil preparation, seeding, sodding, or planting done under other Sections during work associated with installation of irrigation system at no additional cost to Owner.
- Work involving substantial plumbing for installation of backflow preventers, copper service and related work shall be executed by licensed and bonded plumber(s), performed in accordance with prevailing codes and regulations. Work involving connection to, installation, or extension of 120 volt or greater electrical service, shall be executed by a licensed and bonded electrician, performed in accordance
- 1.04 SUBMITTALS Prepare and make submittals in accordance with conditions of the Contract.

with prevailing codes and regulations.

- Submit all products to Owner for approval.
  - Controller Drawings
    - Provide one controller drawing for each automatic controller installed. a. Controller drawing may be same size reproduction of record drawing, if scale permits fitting inside controller door without folding drawing. If photo reduction prints
    - are required, keep reduction to maximum size possible to retain full legibility. Controller drawing shall be blueline print of actual "as-built" system, showing area covered by that controller. Identify area of coverage of each remote control valve, using a distinctly different
    - pastel color for each zone. Highlight heads, lateral piping, and control valves. Following review of controller drawings by Consultant, hermetically seal each drawing between two layers of 20 mil thick clear plastic.
    - Controller drawings shall be completed and approved by Consultant prior to final completion walk-through of irrigation system. Attach approved controller drawing to inside of each controller door using selfadhesive Velcro strips.
  - Operation Manual:
  - See Section 01700 Contract Closeout, Paragraph 1.07, for description and timing of Operation Manual submittal. Include the following information: Index sheet stating project name, and listing company, address, phone number and contact person of Owner, Landscape Architect and Contractor, including Primary Subcontractors.
  - Record Drawings (As-Builts): At onset of irrigation installation Contractor shall secure Mylar sepias of original irrigation design from owner. Make blueline or blackline prints for every week on Project. At end of every day, revise prints for Work accomplished that day in red ink. As-built sepias shall be brought up-to-date at close of working day on every Friday by a qualified draftsperson. A print of record plan(s)shall be available at Project Site. Indicate zoning and non-pressure piping changes on as-builts. Upon completion of Project submit for review, prior to final acceptance, final set of as-built mylar sepias to the Landscape Architect and owner. Dimension from two permanent points of reference (building corners, sidewalk, road
    - intersections or permanent structures), location of the following items: Connection to existing water lines Routing of pressure supply lines (dimension every 100 feet along routing).
    - Electric control valves. Quick coupling valves.
    - Drain valves. Gate valves.
    - Air release valves Drip line blowout stubs.
    - Control wire routing (if not with pressure supply line). Communication Cable routing.
  - Other related equipment as directed by Consultant. Consultant will not certify any pay request submitted by the Contractor if the as-built drawings are not current, and processing of pay request will not occur until as-builts are up-
  - Prior to scheduling walk-through for substantial completion, Contractor to submit all as-built information to Consultant for approval. Manufacturer Technical Manual for controllers.
- 1.05 DELIVERY, STORAGE, and HANDLING Deliver, unload, store, and handle materials, packaging, bundling, products, in dry, weatherproof, waterproof condition in manner to prevent damage, breakage, deterioration, intrusion, ignition, and vandalism. Deliver in original unopened packaging containers prominently displaying manufacturer name, volume, quantity, contents, instructions, and conformance to local, state, and federal law. Remove and replace cracked, broken, or contaminated items or elements prematurely exposed to moisture, inclement weather, snow, ice, temperature extremes, fire, or jobsite
- Handling of PVC Pipe Exercise care in handling, loading and storing of PVC pipe. All PVC pipe shall be transported in a vehicle which allows length of pipe to lie flat so as not to subject it to undue bending or concentrated external loads. All sections of pipe that have been dented or damaged shall be discarded, and if installed, shall be removed and replaced with new piping.

#### 1.06 JOB SITE CONDITIONS

- Protection of Property:
  - Preserve and protect all trees, plants, monuments, structures, and paved areas from damage due to Work of this Section. In the event damage does occur, all damage to inanimate items shall be completely repaired or replaced to satisfaction of Owner. All injury to living plants shall be repaired by Owner, and all costs of such repairs shall be charged to
- Protect buildings, walks, walls, and other property from damage. Barricade open trenches. Damage caused to asphalt, concrete, or other building material surfaces shall be repaired
- or replaced at no cost to Owner. Restore disturbed areas to original condition. All trenching or other Work under limb spread of any and all trees shall be done by hand or

by other methods so as to prevent damage to limbs or branches.

- Where it is necessary to excavate adjacent to existing trees, use all possible care to avoid injury to trees and tree roots. Excavation, in areas where two inch and larger roots occur, shall be conduit, shall be tunneled under and shall be heavily wrapped with burlap to prevent scarring or excessive drying. Where a trenching machine is operated close to trees having roots smaller than two inches in diameter, wall of trench adjacent to tree shall be hand trimmed, making clean cuts through roots. Roots one inch and larger in diameter shall be painted with two coats of "Tree Seal". Trenches adjacent to trees shall be closed within 24 hours, and when this is not possible, side of trench adjacent to tree shall be kept shaded 3.02 PREPARATION with moistened burlap or canvas.
- Protection and Repair of Underground Lines Request proper utility company to stake exact location (including depth) of all underground electric, gas, or telephone lines. Take whatever precautions are necessary to protect these underground lines from damage. In the event damage does occur, all damage shall be repaired by Contractor, and all costs of such repairs shall be paid by Contractor unless
  - other arrangements have been made. Replacement of Paving and Curbs - Where trenches and lines cross existing roadways, paths, curbing, etc., damage to these shall be kept to a minimum and shall be restored to original condition as deemed acceptable by Owner's Representative.
- 1.07 WARRANTY/GUARANTY Contractor shall warrant materials against defects for a period of one year from date of Substantial Completion. Contractor shall guarantee workmanship for similar period. Contractor shall be responsible for coordinating material warranty items with manufacturer/distributor.
- Settling of backfilled trenches, which may occur during guaranty period, shall be repaired by contractor at no expense to Owner, including complete restoration of damaged property and landscape improvements. Expenses due to vandalism before substantial completion shall be borne by Contractor.
- Owner or Representative Maintenance Company will maintain turf and planting areas during warranty period, so as not to hamper proper operation of irrigation system.

#### 1.08 MAINTENANCE

Furnish the following maintenance items to Owner prior to final Acceptance: 2 Sets of special tools required for removing, disassembling, and adjusting each type of sprinkler head and valve supplied on this Project. Two 6-foot valve keys for operation of gate valves or stop and waste valves (if applicable). 2 keys for each automatic controller.

#### PART II - PRODUCTS

#### 2.01 MATERIALS:

- General Piping: Potable Water Pressure Supply Lines (downstream of backflow prevention units) Schedule 40BE (1" - 2-1/2") Non-pressure Lines - Schedule 40BE.
- In Line Drip Emitter Tubing As indicated in the Schedules and Details. Blow-Out tubing (1/2") - Salco 1/2" A/R PVC flex hose

5 sprinkler bodies of each size/type used.

200' of drip line of the type specified.

- Above grade piping UVR Brownline pipe see below.
- B. Plastic Pipe and Fittings: Identification Markings:
  - a. All pipe to be identified with following indelible markings: Manufacturer's name and Nominal pipe size
  - Schedule of class and Pressue rating NSF (National Sanitation Foundation) seal of approval. Date of extrusion.
  - Solvent Weld Pipe Manufactured from virgin polyvinyl chloride (PVC) compound in accordance with ASTM D2241 and ASTM D1784; cell classification 12454-B, Type 1,
  - Fittings Standard weight, Schedule 40, injection molded PVC; complying with ASTM D1784 and D2466, cell classification 12454-B.
  - Threads Injection molded type (where required). Tees and ells - Side gated.
  - Threaded Nipples ASTM D2464, Schedule 80 with molded threads. Joint Cement and Primer - Type as recommended by manufacturer of pipe and
- 3. UVR Pipe Solar Proof UVR Schedule 40 for use in above ground applications, brown color, belied ends, with special additives used the pipe compound to make the pipe Ultra Violet Resistant in accordance with ASTM D1785. Diameter and thickness are to be in accordance with ASTM D2122.
- Low Pressure/Volume Systems: Emitter Tubing as indicated on drawings. Drip Tubing - Manufactured of UV resistant flexible vinyl chloride compound conforming to ASTM D1248, Type 1, Class C, Category 4, P14 and ASTM D3350 for PE 1221110.
- Fittings As indicated on the drawings Drip Valve Assembly - Type and size shown on drawings. Wye Strainer or Basket Strainer - Plastic/fiberglass construction with 200-mesh nylon screen. Size as noted on drawings.
- Control Valve 2 way, solenoid pilot operated type made of synthetic, non-corrosive material; diaphragm activated and slow closing. Include freely pivoted seat seal; retained (mounted) without attachment to diaphragm
  - Preset Pressure Regulator Plastic construction with pre-set pressure regulation and sized for zone flow rate.
  - Copper Pipe and Fittings: Copper Pipe - Type 'K' hard tempered:
- Fittings Wrought copper, solder joint type.
- Joints Soldered with solder, 45% silver, 15% copper, 16% zinc, and 24% cadmium and
- solidus at 1125 degrees F and liquids at 1145 degrees F. Gate Valves for 3/4 inch through 2-1/2 Inch Pipe - Bronze construction; solid wedge, IPS
- threads, and non-rising stem with wheel operating handle Gate Valves for 3 inch and Larger Pipe - Iron body, brass or bronze mounted AWWA gate valves with a clear waterway equal to full nominal diameter of valve; rubber gasket or mechanical joint-type only. Valves shall be able to withstand a continuous working pressure of 150 PSI and be equipped with a square operating nut.
- Gate Valves, Drip Line Blow-out Stubs, and Wire Stub Box Carson #910-10-4 with bolt 3/4 Inch through 2-Inch Control Valves - Carson #1419-12-3B w/ bolt down cover.
- Drip Valve Assemblies Carson #1419-12-3B w/ bolt down cover, Control Wiring Splices - Carson #910-12-3B w/ bolt down cover. Master Valve – Rectangular with extension (see construction details). Provide stainless steel bolts for valve box covers where required and indicated above.
- Electrical Control Wiring:
  - Electrical Control Wire AWG UF UL approved No. 14 gauge direct burial copper wire for all control wires, and No. 12 gauge direct burial copper wire for all common 2 Wire Control Path - Paige P7254-D
  - Electrical Conduit for 2 Wire Path 1-1/4" electrical conduit SCH 40 PVC Control wire connections and splices shall be made with 3M SCOTCH LOCK 3570 direct bury splice. High Voltage - Type required by local codes and ordinances, of proper size to
- accommodate needs of equipment serviced Electric Control Valves - As indicated on drawings Emitters, Emitter Tubing and Emitter Components - As indicated on the Drawings. Sprinkler Heads and Swing Joints - As indicated on drawings. Sprinkler bodies shall be equipped
- with integral check valves. Fabricate riser/swing joint units in accordance with details on Drawings with riser nipples of same size as riser opening in sprinkler body. In-Line Check Valves – Use where low head drainage occurs. Check valve size shall match pipe size on which they are installed. Utilize both swing and spring style as indicated. Air Release Valves as indicated on the Drawings.

#### PART III - EXECUTION

- done by hand. Roots two inches or larger in diameter, except directly in the path of pipe of 3.01 INSPECTION Examine areas and conditions under which Work of this Section is to be performed. Do not proceed with Work until unsatisfactory conditions have been corrected.
  - Grading operations, with the exception of final grading, shall be completed and approved by Owner prior to staking or installation of any portion of irrigation system except sleeving.

- A. Staking shall Occur as Follows: Mark with powdered lime or marking paint, routing of pressure supply line and flag heads and control valve locations for first series of zones as directed by Landscape Architect. Contact Landscape Architect 48 hours in advance and request review of staking. Landscape Architect will review staking and direct changes if required. Staking review does not relieve installer from coverage problems due to improper placement of heads after
- Install sleeving under asphalt paving and concrete walks, prior to concreting and paving operations, to accommodate piping and wiring. Compact backfill around sleeves to 95% Standard Proctor Density within 2% of optimum moisture content in accordance with ASTM D1557 Trenching - Trench excavation shall follow, as much as possible, layout shown on Drawing. Dig trenches straight and support pipe continuously on bottom of trench. Trench bottom shall be clean and smooth with all rock and organic debris removed. Pressure supply line trenches shall be overexcavated as required to allow for bedding material. Trench depth shall be uniform as required to

meet minimum depth requirements for type of piping.

- Piping Smaller than 3 Inches Trenches shall have a minimum width of 7 inches. Line Clearance - Provide not less than 6 inches of clearance between each line and not less than 12 inches of clearance between lines of other trades.
- Pipe and Wire Depth: Pressure Supply Piping - 18 inches from top of pipe.
- Non-pressure Piping (drip main laterals) 12 inches from top of pipe. Non-pressure Piping (drip emitter tubing and side laterals) - 12 inches from top of

drawings. Final density of backfill shall match that of surrounding soil. Use of sleeves of

suitable diameter is acceptable if installed first by jacking or boring, and pipe laid through

- Control Wiring Side and bottom of pressure supply line. Boring will be permitted only where pipe must pass under obstruction(s), which cannot be removed, and must be approved by consultant if not specifically indicated on construction
- sleeves. Observe same precautions as though pipe were installed in open trench. Refer to drawings for sleeving schedule and sizing requirements. Install vertical piping as required to reach correct piping depth when sleeving into walled
- 3.03 INSTALLATION Locate other equipment as near as possible to locations designated on construction 3.04 FIELD QUALITY CONTROL drawings. Deviations shall be approved by Consultant prior to installation.
  - A. PVC Piping Snake pipe in trench as much as possible to allow for expansion and contraction. When pipe laying is not in progress, or at end of each day, close pipe ends with tight plug or cap. [Perform work in accordance with good practices prevailing in piping trades]
  - Coordinate pressure supply line installation with required bedding operations. Stake all above grade PVC piping per details. Use 45° ells when making perpendicular crossings of above grade PVC piping, to depress
  - Lay pipe and make all plastic to plastic joints in accordance with manufacturer's recommendations. Above grade piping – install per details. Drip Tubing
  - Install fitting connections per manufacturer's recommendations. Install drip tubing on the finish grade surface, and under the specified mulch as detailed. Only intake and exhaust manifolds shall be installed below grade at 12" deep, with riser and adapter assemblies extending to grade level. Tubing shall be installed in parallel, evenly spaced rows as indicated on the drawings, with a
  - slight snaking of the tubing to allow for expansion/contraction. Distance between rows shall not deviate more then 1" from row to row. Staple tubing to soil surface at minimum of 3' on center or as detailed.
  - Install drip line blowout stubs at all dead ends of drip tubing. Any deviations from drip tube routing shown on drawings must be approved by Consultant prior to installation. Any changes exceeding a 5% increase in the length of the drip tubing, or the tie in placement of the pvc/poly adapter indicated on the drawings must be approved
  - by the Consultant prior to installation. 2 Wire Path Wiring Low Voltage Wiring:
    - Bury 2 wire path in conduit between controller and electric valves in pressure supply line trenches, with conduit consistently located below and to one side of pipe, on top of initial pipe bedding, or in separate trenches. Provide an expansion loop at pressure supply line angle fittings, every electric control valve location (in valve box), and at minimum 500 feet intervals. Form
    - withdrawing pipe. Make splices and electric control valve connections using connectors as specified refer to materials section. Install 2 wire path wire splices not occurring at control valve in a separate splice

expansion loop by wrapping wire at least 8 times around a 3/4 inch pipe and

- Run all future control wires from controller pedestal to point indicated on drawings. Coil a minimum of ten (10) feet at termination and install in 10" round valve box.
- Label all wires at terminatior High Voltage Wiring for Automatic Controller a. Provide 120 volt power connection to automatic controller. 120 volt power
- connection must be made by a licensed Electrician per the NEC. Install controller in accordance with manufacturer's instructions as detailed and where Connect remote control valves to controller in numerical sequence as shown on Drawings.
- Final location of controller shall be approved by Consultant prior to installation. Each controller shall be grounded per the NEC. Above ground conduit shall be rigid galvanized with appropriate fittings. Below ground conduit shall be schedule 40 PVC. Run two (2) 14 ga ULUF wire from flow sensor terminal to each flow sensor indicated, and connect as detailed.
- Adjacent valves may share a 2 or 4 station decoder. Electric Control Valves Install cross handle 2 inches below finished grade where shown on Drawings and as When grouped together, allow at least 12 inches between valve box sides.

Install decoders and surge protectors per details and where indicated on plans.

- Install each remote control valve in a separate valve box; Install individual valve box flush with grade. When parallel to roadway, sidewalk, or other permanent element or structure, control valve and box to be installed perpendicular to element or structure, spaced equally. Drip Valve Assemblies - Install drip valve assembly as detailed and as described above in the
- section titled "Electric Control Valves". Sprinkler Heads Install sprinkler heads where designated on Drawings or where staked. Spacing of heads shall not exceed the maximum indicated on Drawing unless re-staked as directed by Consultant. In no case shall the spacing exceed maximum recommended by manufacturer. Set plumb to finish grade as detailed. Install heads on double swing-joint risers of schedule as detailed. Angled nipple relative to non-pressure, line shall be no more than 45 degrees or
- less than 10 degrees. Adjust heads to correct height after sod is installed. Refer to details for head placement and angle of heads on slopes. Adjust part circle heads for proper coverage. Plant placement shall not interfere with intended sprinkler head coverage, piping, or other equipment. Consultant may request nozzle changes or adjustments without additional cost to the Owner. 4. Install sprinkler heads 3" from curbs and sidewalks, 12" from vertical surfaces such as walls

Valve box extensions are not acceptable except for master valve.

**NOTES:** 

and fences, and on the slope face at toe of slopes. Valve Boxes Install one valve box for each type of valve installed as detailed flush with grade for all sodded areas, and 1/2" above grade for all seeded areas.

- Install gravel sump after compaction of all trenches. Valve box bottom edge to rest on gravel sump. Gravel sump to wrapped in filter fabric as detailed. Place final portion of gravel inside valve box after valve box is backfilled and compacted. Gate Valves - Install where shown on Drawings as detailed.
- Emitters Install as detailed at the quantities indicated on the drawings for each tree within drip zones as supplemental watering. Backfilling - Do not begin backfilling operations until required system tests have been completed. Backfill shall not be done in freezing weather except with prior approval by Consultant. Leave trenches slightly mounded to allow for settlement after backfilling is completed.
- All pressure supply lines shall be bedded with construction grade sand 4" below invert of pipe, to 6" above top of pipe and width of trench. Materials - Excavated material is generally considered satisfactory for backfill purposes after completing bedding requirements. Backfill material shall be free of rubbish, vegetable

Trenches shall be finish graded prior to walk-through of system by Consultant.

- matter, frozen materials, and stones larger than 2 inches in maximum dimension. Do not mix subsoil with topsoil. Material not suitable for backfill shall be hauled away. Contractor shall be responsible for providing suitable backfill if excavated material is unacceptable or not sufficient to meet backfill, compaction, and final grade requirements. Do not leave trenches open for a period of more than 48 hours. Open excavations shall be protected in accordance with OSHA regulations.
- Compact backfill to 90% maximum density in 6" lifts, determined in accordance with ASTM D155-7 utilizing the following methods: Mechanical tamping.

Piping shall be bedded with construction grade sand or squeegee - 6 inches below pipe to 6

- Puddling or ponding. Puddling or ponding and /or jetting is prohibited within 10'- 0" of building or foundation walls.
- Piping Under Paving: Provide for a minimum cover of 24 inches between the top of the pipe and the bottom of the aggregate base for all pressure and non-pressure piping installed under asphaltic concrete or concrete paving.
- inches above pipe and width of excavation. Compact backfill material in 6-inch lifts at 95% maximum density determined in accordance with ASTM D1557 using manual or mechanical tamping devices. Set in place, cap, and pressure test all piping under paving, in presence of consultant or
- Owner prior to backfilling and paving operations. Piping under existing walks or concrete pavement shall be done by jacking, boring, or hydraulic driving, but where cutting or breaking of walks and/or concrete is necessary, it shall be done and replaced at no cost to Owner. Obtain permission and prior approval to cut or break walks and/or concrete from Owner.

Water Supply and Point of Connection - Water supply shall be extended as shown from water

Air release Valves: Install where indicated on the drawings downstream of the Pump Assemblies and at isolate high points. Verify high point locations.

- Owner to be notified to observe all testing and before anything is backfilled. Flushing - After piping, risers, and valves are in place and connected, but prior to installation of emitters, quick coupling valves, and air release valves, thoroughly flush piping system under full head of water pressure from dead end fittings. Maintain flushing for 5 minutes through furthermost valves. Cap risers after flushing.
- C. Testing Conduct tests in presence of Consultant. Arrange for presence of Consultant a minimum of 48 hours in advance of testing. Supply force pump and all other test equipment. After backfilling, and installation of all control valves, quick coupling valves, drain valves, and air release valves, fill pressure supply line with water, and pressurize to 40 PSI over the
- designated static pressure or 120 PSI, whichever is greater, for a period of 2 hours. Leakage, Pressure Loss - Test is acceptable if no leakage or loss of pressure is evident during test period. Leaks - Detect and repair leaks.
- Retest system until test pressure can be maintained for duration of test. Before final acceptance, pressure supply line shall remain under pressure for a period of 48
- Walk Through for Substantial Completion: Arrange for Consultant's presence a minimum of 48 hours in advance of walk-through.
- Entire system shall be completely installed and operational prior to scheduling of walkthrough. All sodded areas are to be complete with head height and valve boxes adjusted accordingly.
- Operate each zone in its entirety for Consultant at time of walk-through and open all valve Consultant shall generate a list of items to be corrected prior to Final Completion.
- Furnish all materials and perform all Work required to correct all inadequacies due to deviations from Contract Documents, and as directed by Consultant During walk-through, expose all drip emitters under operations for observation by Consultant to demonstrate that they are performing and installed as designed; prior to placing of all mulch material. Schedule separate walk-through if necessary.
- Walk-Through for Final Completion: Arrange for Consultant's presence a minimum of 48 hours in advance of walk through. 2. Operate each zone identified as deficient at substantial completion walk through for Consultant at time of final completion walk through to insure correction of all incomplete
- 4. Items deemed not acceptable by Consultant shall be reworked to complete satisfaction of 5. If after request to Consultant for walk-through for Final Completion of irrigation system, Consultant finds items during walk through which have not been properly adjusted, reworked, or replaced as indicated on list of incomplete items from substantial completion walk-through, Contractor shall be charged for all subsequent walkthroughs. Funds will be
- withheld from final payment and/or retainage to Contractor, in amount equal to additional time and expenses required by Consultant to conduct and document further walk-throughs as deemed necessary to insure compliance with Contract Documents. 3.05 ADJUSTING - Upon substantial completion of installation, "fine-tune" entire system by regulating valves, adjusting patterns and break-up arms/screws, and setting pressure reducing valves or throttling control valve flow controls at proper pressure to provide optimum and efficient coverage. Flush and adjust all sprinkler heads for optimum performance and to prevent overspray onto walks,
- roadways, and buildings as much as possible. Heads of same type shall be operating at same pressure +/- 7%. If it is determined that irrigation adjustments will provide proper and more adequate coverage, make such adjustments prior to Final Acceptance, as directed, at no additional cost to Owner. Adjustments may also include changes in emitter spacing and sizes, and control valve throttling.
- 3.06 CONTROL SYSTEM SET UP Contractor shall program the following features into the controller and shall be operating the controller using these features within one month of the termination of the
  - maintenance period: Controllers shall be set to operate 'By Capacity' at the flow rate indicated on the Irrigation

Areas which do not conform to designated operation requirements due to unauthorized

changes or poor installation practices shall be immediately corrected at no additional cost to

The flows of all valves shall be learned by the controller. The Contractor shall demonstrate that each Controller is communicating with the Central Control System

The Contractor shall coordinate with the Controller Manufacturer to achieve these settings

Manufacture shall inspect and certify controller installation. 3.07 CLEANING - Maintain continuous cleaning operation throughout the duration of Work. Dispose of off-site at a legal dumpsite and at no additional cost to Owner, all trash or debris generated by

and requirements.

installation of irrigation system.

END OF SECTION 02810

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- CONSULTING client

consultant

key plan

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1 SOUTH FOREST BEACH DRIVE

**IRRIGATION DETAILS** 

HILTON HEAD, SC 29928

checked by: SML

NTERIOR WALL CONTROLLER

\_ Lakakuku

CONTRACTOR TO GROUND AND PROVIDE SURGE PROTECTION FOR FIELD UNIT IN ACCORDANCE WITH MANUFACTURER"S RECOMMENDATIONS AND GROUND ROD(S) SHOWN. ALL ELECTRICAL WORK

WEATHER SENSOR MOUNT TO BUILDING EAVE IN A LOCATION EXPOSED TO RAIN

CONTROLLER - INSTALL ON BUILDING WALL SECURE WITH ANCHOR BOLTS PER

MANUFACTURERS MOUNTING INSTRUCTIONS

TO CONFORM TO LOCAL CODE.

2" CONDUIT SECURED TO WALL

ELEC. PULL BOXES SECURED AND SEALED TO BUILDING WALL FOR

CONTROL WIRE ACCESS

2" SWEEP ELL - CONTROL WIRES & GROUND WIRE

**BUILDING WALL** 

FINISH GRADE

N.T.S

. Refer to Sheet L4-001 for Irrigation Schedule and Notes.

3. Refer to Sheets L4-401 & L4-402 for Irrigation Details.

2. Refer to Sheet L4-101 for Irrigation Plan

4. Refer to Book Specifications for Irrigation Specifications.

Ph: (760)750-1900 Fax: (760)750-1999

FINAL DESIGN.

Aqua Commercial Irrigation

NOTE: IRRIGATION LAYOUT TO BE

UPDATED PER FIELD CONDITIONS &

San Marcos, California 92069

#### GENERAL PLANTING NOTES

- 1. Refer to Planting Details and Specifications for additional planting information.
- 2. Consult with site superintendent, appropriate agencies, and Drawings to verify existing locations of underground utilities, pipes and structures. Take sole responsibility for costs incurred due to damage of these utilities, pipes, or structures if proper verification by Contractor was not performed.
- 3. Do not willfully proceed with planting operations when it is obvious that unknown obstructions and grade differences exist that may not have been known during the design process. Bring these conditions immediately to the attention of the Owner's Authorized Representative for resolution. Assume full responsibility for costs incurred due to lack of providing such notification.
- 4. Coordinate with other contractors whose work is related to proper execution of Contractor's work.
- 5. Prior to beginning planting operations obtain approval of final grade certification from Owner that certifies that rough grades are within 1/10th of an inch from specified grades. Ensure that finish grade elevations of planting areas are set to the proper elevations relative to the finish surfaces of paving, utility covers, and curbs.
- 6. Existing site soil may be used in planting areas, however, it may need to be amended as indicated in the Horticultural Soils Report. Should import soil be necessary to bring site to specified finish grades, indicate source location. Ensure that import soil is of a sandy loam nature, containing no toxic chemicals or elements that might inhibit or retard normal plant growth. Submit soil test results of import soil to Owner's Authorized Representative for approval prior to delivering import soil to site.
- 7. Submit representative photos of each tree species to Owner's Authorized Representative for approval. Trees of a single species and variety are to have matching form.
- 8. Plant material must be approved by Owner's Authorized Representative prior to installation. Plant material installed without approval of Owner's Authorized Representative may be subject to removal and replacement with related costs borne by Contractor.
- 9. Final locations of plant materials are subject to approval of the Owner's Authorized Representative prior to installation. Perform the following before beginning planting pit excavation: a. Shrubs — place in containers on—site in "final" locations.
- b. Trees stake or flag centerpoint of tree. c. Container Pots — locate pots prior to planting.
- 10. Notify Owner's Authorized Representative in sufficient time to perform a required site observation visit. Refer to Specifications for specific site visit notification tasks and times. Insufficient notification time given Owner's Authorized Representative may require the site visit to be canceled, or possibly, make Contractor responsible to compensate Owner's Authorized Representative for overtime.
- 11. Furnish plant material free of pests, poor condition, or disease, including pre-selected or "tagged" plant material that has been selected by Owner's Authorized Representative.
- 12. After fine grading operations have been completed and prior to beginning soil preparation, take a minimum of (3) horticultural soil samples where soil conditions or plant types vary, i.e. turf, shrub, slopes, etc. Soil samples are to be collected and tested by a qualified soil testing laboratory (as defined by the regulations and standards of the State of South Carolina or professional arborist association) and a written report prepared which includes recommendations for soil amendments, fertilization, planting backfill mixes and maintenance. Submit a copy of the report to the Owner's Authorized Representative. Planting specifications may be revised to conform to recommendations noted in Soil Report, however, only upon receipt of written change order from Owner.
- 13. If conflicts arise between actual size of planting areas on—site and those areas indicated on Drawings, contact Owner's Authorized Representative for resolution. Failure to make such conflicts known to Owner's Authorized Representative in a timely fashion may result in Contractor's own liability to relocate plant materials.
- 14. Ensure that turf areas are separated from ground covers and shrub areas with specified edging — refer to Drawings.
- 15. Triangular space ground covers and shrubs, unless indicated otherwise on Drawings — refer to Planting Details.
- 16. Provide a representative example of a typical tree staking and guying (if any) installation for review by Owner's Authorized Representative before performing tree staking and guying (if any) operations — refer to Planting Details.
- 17. Excavate plant pits to specified dimensions per Planting Details and soils
- 18. Do not plant trees closer than 4 feet to fixed edge such as sidewalks and walls unless otherwise indicated on Drawings.
- 19. Ensure that tops of tree root balls are set 2" above finish grade and shrub root balls are set 1" above finish grade.
- 20. Install plant material with its best side facing predominate public view.
- 21. Provide the required setbacks between trees and elements such as utilities, i.e. gas, electric, sewer, water and related vaults, streetlights, fire hydrants and signage.
- 22. Replace or repair existing materials that are damaged by Contractor during planting operations.
- 23. Verify property lines prior to commencing planting operations.
- 24. Refer to City and County standards for standard landscape plans and specifications, where applicable.

#### PALM SCHEDULE

KEY	BOTANICAL NAME	COMMON NAME	SIZE	FORM SPACING	QTY.	STAKE/GUY	REMARKS
SAB PAL	Sabal palmetto	Cabbage Palm	14'& 16' Tall	Per Plan	70	N/A	Including one multi—trunk palm for the planter by the pool as indicated in the plan.

#### TREE SCHEDULE

KEY	BOTANICAL NAME	COMMON NAME	SIZE	FORM	SPACING	QTY.	STAKE/GUY	REMARKS
GOR LAS	Gordonia lasiathus	Loblolly Bay	10' Tall	STD	Per Plan	8	N/A	
MYR CER	Myrica cerifera	Southern Wax Myrtle	8' Tall	STD	Per Plan	2	N/A	
QUE VIR	Quercus virginiana	Southern Live Oak	12'& 16' Tall	STD	Per Plan	6	N/A	

#### TREE ROOT BARRIER SCHEDULE

- 1. Provide root control barriers for trees planted within 5—feet of a hardscape edge such as paving, walls, curbs, steps, etc.
- 2. Type: UB18-2.
- 3. Mfg: Deep Root (800) 458-7668
- 4. Length: 10' long.
- A. Set top of barrier a minimum of 1/2" above finish grade and below surface of wood mulch or turf.
- C. Alternatives may be submitted for review.

#### WOOD MULCH SCHEDULE


1. Mulch these planter areas with a 3—inch deep layer of wood mulch:

convenience and reference only. Contractor is responsible to provide all plant material required to conform to specified plant

A. Shrub areas.

spacing.

- B. Ground cover areas.
- 2. Mulch Type: Wood Chips (2" minus).
- 3. Comments: Provide Owner's Authorized Representative with (1) baggie of mulch for review and approval prior to placement of mulch. 4. Refer to the Landscape Planting Specifications for additional mulch information.

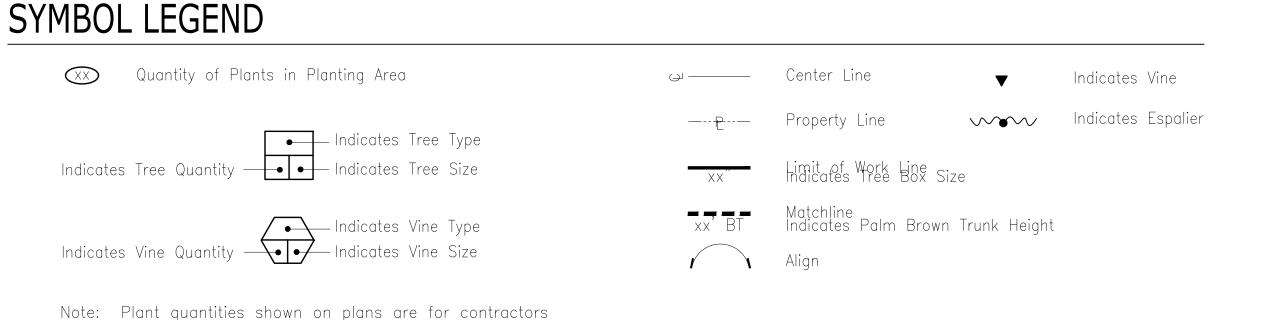

#### SHRUB & GROUND COVER

	BOTANICAL NAME	COMMONL NAME	SIZE	FORM	INSTALL HT&WIDTH	MATURE HT&WIDTH	SPACING	AREA/QTY	WATER USE	REMARKS
$\otimes$	Calamagrostis X acutiflora 'Karl Foerster'	Karl Foerster Grass	5 gal.	Ground Cover	Ht: 18" Wd: 12"	Ht: 3-5' Wd: 2.5'	O.C. 18"		Low	Triangular Spacing
	Dietes iridioides	Fortnight Iris	5 gal.	Shrub	Ht: -" Wd: -"	Ht: 2-4' Wd: 2-3'	Per Plan		Low	Per Plan
	Fatsia japonica	Japanese Aralia	15 gal.	Shrub	Ht: -" Wd: -"	Ht: 6-10' Wd: 6-10'	Per Plan		Moderate/ Medium	Per Plan
	Helianthus debilis	Dune Sunflower	1 gal.	Shrub	Ht: -" Wd: -"	Ht: 1-2' Wd: 2-4'	Per Plan		Moderate/ Medium	Per Plan
	Hibiscus coccineus	Scarlett Mallow	15 gal.	Shrub	Ht: -" Wd: -"	Ht: 6-8' Wd: 2-3'	Per Plan		Moderate/ Medium	Standard Trunk Shrub Form
(%)	Liriope muscari	Bug Blue Lilyturf	5 gal.	Shrub	Ht: -' Wd: -'	Ht: 1-1.5' Wd: 9"-12"	Per Plan		Low	Per Plan
	Oenothera drummondii	Beach Evening Primrose	1 gal.	Shrub	Ht: -' Wd: -'	Ht: 1' Wd: 3'	Per Plan		Low	Per Plan
	Philodendron xanadu	Xanadu Philodendron	5 gal.	Shrub	Ht: -" Wd: -"	Ht: 2-4' Wd: 3-5'	Per Plan		Moderate/ Medium	Per Plan
+	Rhaphiolepis indica 'clara'	White India Hawthorn	5 gal.	Shrub	Ht: 2' Wd: 1'	Ht: 3-4' Wd: 5'	24" O.C.		Moderate/ Medium	Per Plan
$\bigoplus$	Rosa banksiae "Lutea"	Lady Banks' Rose	1 gal.	Vine	Ht: 18" Wd: 12"	Ht: 1-3' Wd: 2'	Per Plan		Moderate/ Medium	Staked
	Ruellia brittoniana	Mexican Petunia	1 gal.	Ground Cover	Ht: 18" Wd: 12"	Ht: 1-3' Wd: 2'	18" O.C.		Low	Per Plan
	Serenoa repens	Saw Palmetto								
	Viburnum suspensum	Sandankwa Viburnum	5 gal.	Shrub	Ht: 4' Wd: 2'	Ht: 4' Wd: 5'	Per Plan		Moderate/ Medium	Per Plan

#### GRASSES SCHEDULE

	BOTANICAL NAME	COMMON NAME	SIZE	TYPE	SPACING DE	ETAIL NO.	QTY.	WATER USE	REMARKS
4	Panicum amarum	Seaside Panicum	15 gal.	Grass			_		Triangular Spacing

1. PLANTING SQUARE FEET AREA INFORMATION TO BE VERIFIED BY CONTRACTOR.

2. REPORT OF EXISTING PALMS HEIGHTS TO BE SUBMITTED TO LANDSCAPE ARCHITECT PRIOR TRANSPLANTS.

3. LOCATION OF BUILDING WALLS, WINDOWS AND DOORS NEED TO BE SITE VERIFIED BY LANDSCAPE CONTRACTOR AND SUBMITTED


TO LANDSCAPE ARCHITECT PRIOR PLANTING.

## WATG

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issues | revisions

HILTON HEAD ISLAND 1 SOUTH FOREST BEACH DRIVE HILTON HEAD, SC 29928

PLANTING SCHEDULE & NOTES

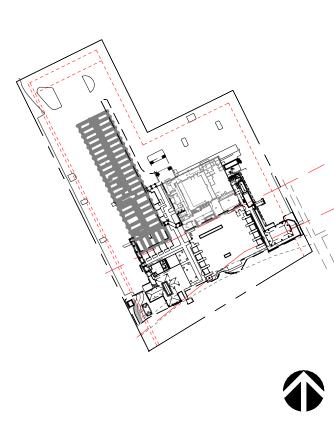drawn by: FCVA / GG / CLT






GORDONIA LASIATHUS LOBLOLLY BAY



MYRICA CERIFERA SOUTHERN WAX MYRTLE

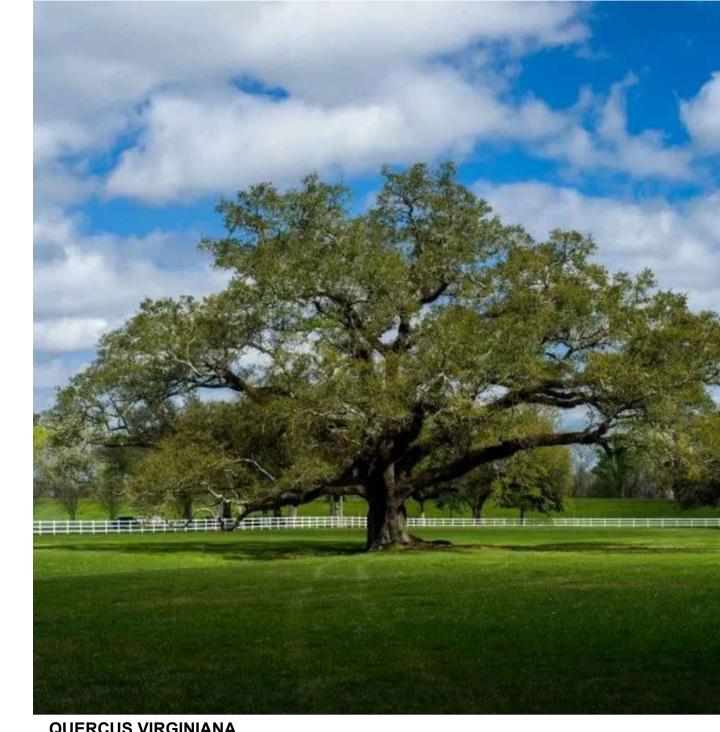

**QUERCUS VIRGINIANA** SOUTHERN LIVE OAK

#### SHRUB & GROUNDCOVER SCHEDULE



CALAMAGROSTIS X ACUTIFLORA 'KARL FOERSTER'
KARL FOERSTER GRASS



**DIETES IRIDIOIDES**FORTNIGHT IRIS



FATSIA JAPONICA JAPANESE ARALIA



HELIANTHUS DEBILIS
DUNE SUNFLOWER



HIBISCUS COCCINEUS SCARLETT MALLOW



LIRIOPE MUSCARI BUG BLUE LILYTURF



OENOTHERA DRUMMONDII BEACH EVENING PRIMROSE



PHILODENDRON XANADU XANADU PHILODENDRON


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Beach House
HILTON HEAD ISLAND

1 SOUTH FOREST BEACH DRIVE HILTON HEAD, SC 29928 project logo

PLANTING IMAGERY

project no. 212041 date checked by: LKW / JHC

drawn by: FCVA / CL

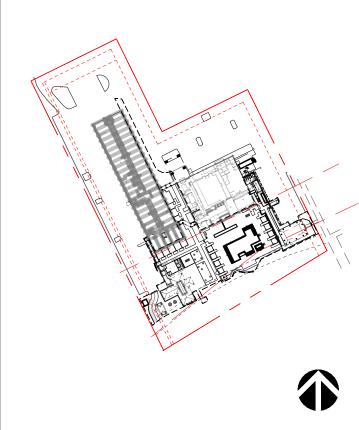L5-002

#### SHRUB & GROUNDCOVER SCHEDULE





ROSA BANKSIAE 'LUTEA' LADY BANKS' ROSE



RUELLIA BRITTONIANA MEXICAN PETUNIA



SERENOA REPENS SAW PALMETTO



#### **GRASSES SCHEDULE**



PANICUM AMARUM SEASIDE PANICUM

NOTE.

1. PLANTING SQUARE FEET AREA INFORMATION TO BE VERIFIED BY

2. REPORT OF EXISTING PALMS HEIGHTS TO BE SUBMITTED TO LANDSCAPE ARCHITECT PRIOR TRANSPLANTS.


3. LOCATION OF BUILDING WALLS, WINDOWS AND DOORS NEED TO BE SITE VERIFIED BY LANDSCAPE CONTRACTOR AND SUBMITTED TO LANDSCAPE ARCHITECT PRIOR PLANTING.

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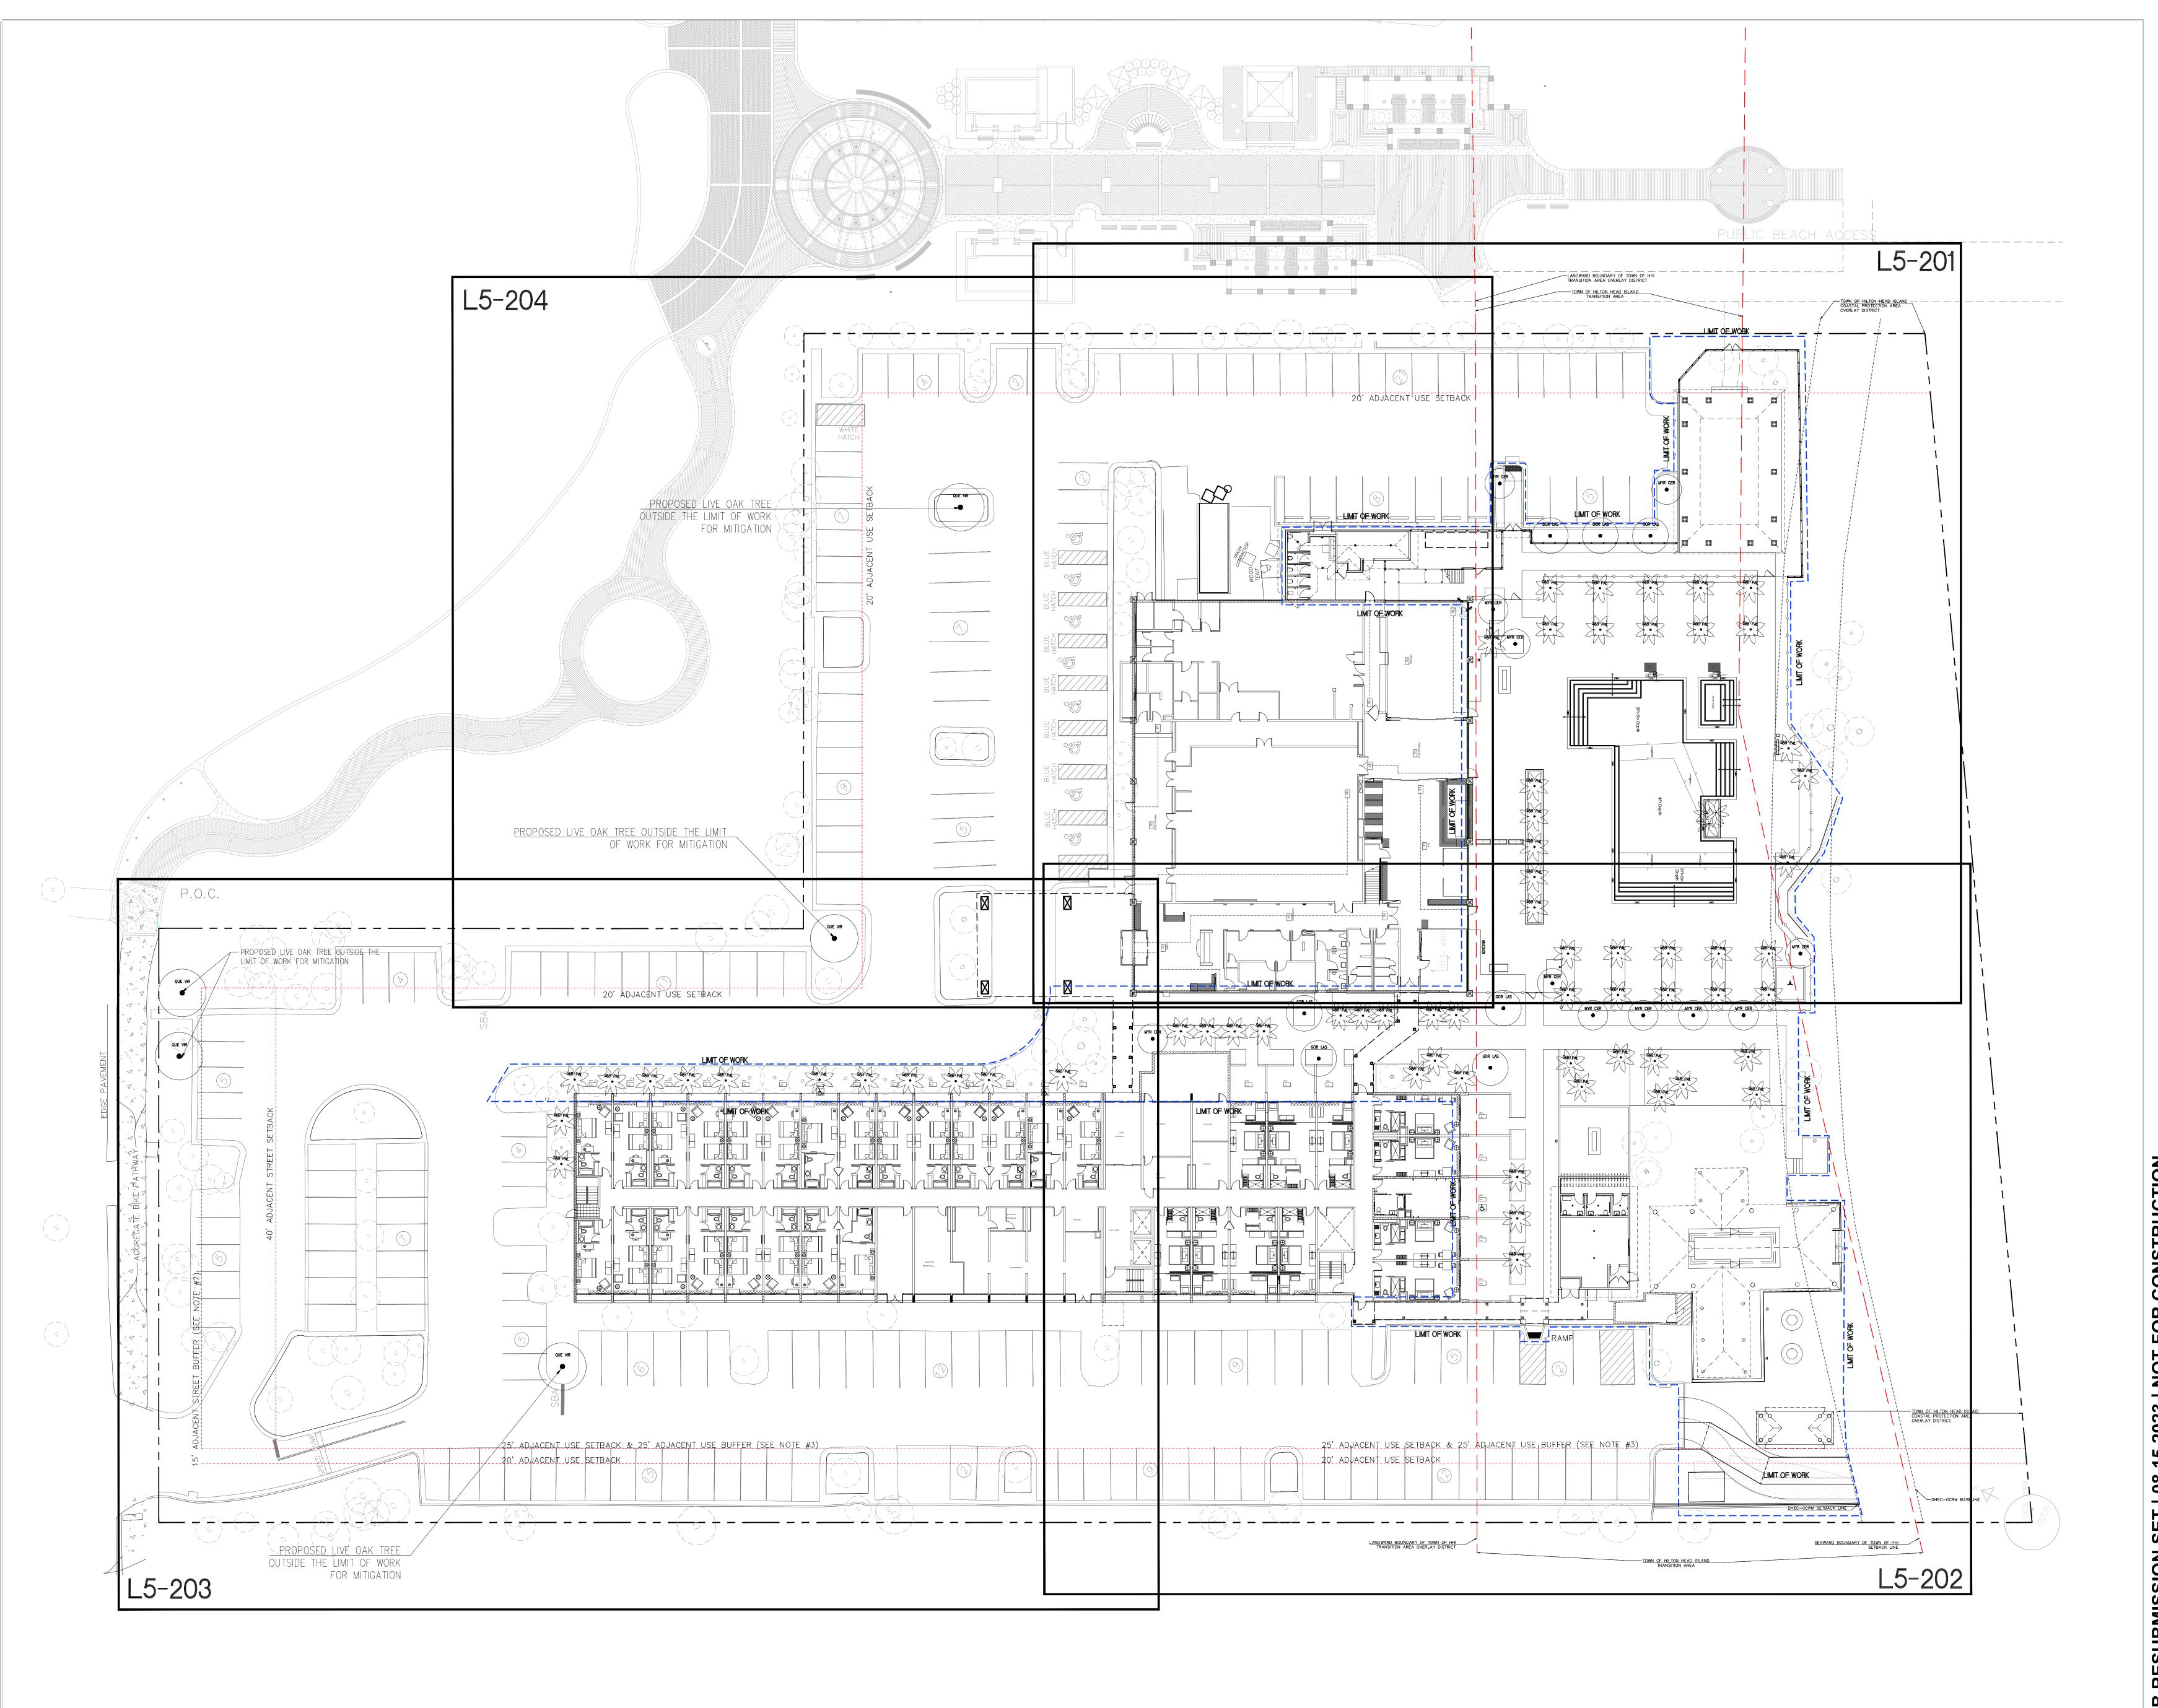
Beach House
HILTON HEAD ISLAND

1 SOUTH FOREST BEACH DRIVE HILTON HEAD, SC 29928

PLANTING IMAGERY

checked by: LKW / JHC drawn by: FCVA / CL

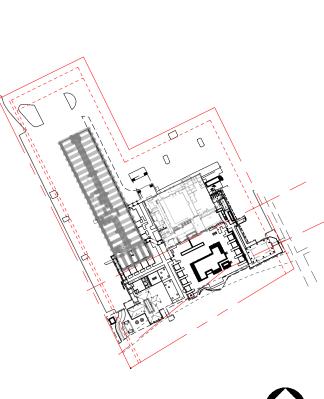project no. 212041



strategy planning architecture landscape interiors

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client

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Beach House
HILTON HEAD ISLAND


1 SOUTH FOREST BEACH DRIVE
HILTON HEAD, SC 29928
project logo

OVERALL TREE PLAN

project no. 212041 date 08/2

checked by:
drawn by:

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HILTON HEAD ISLAND

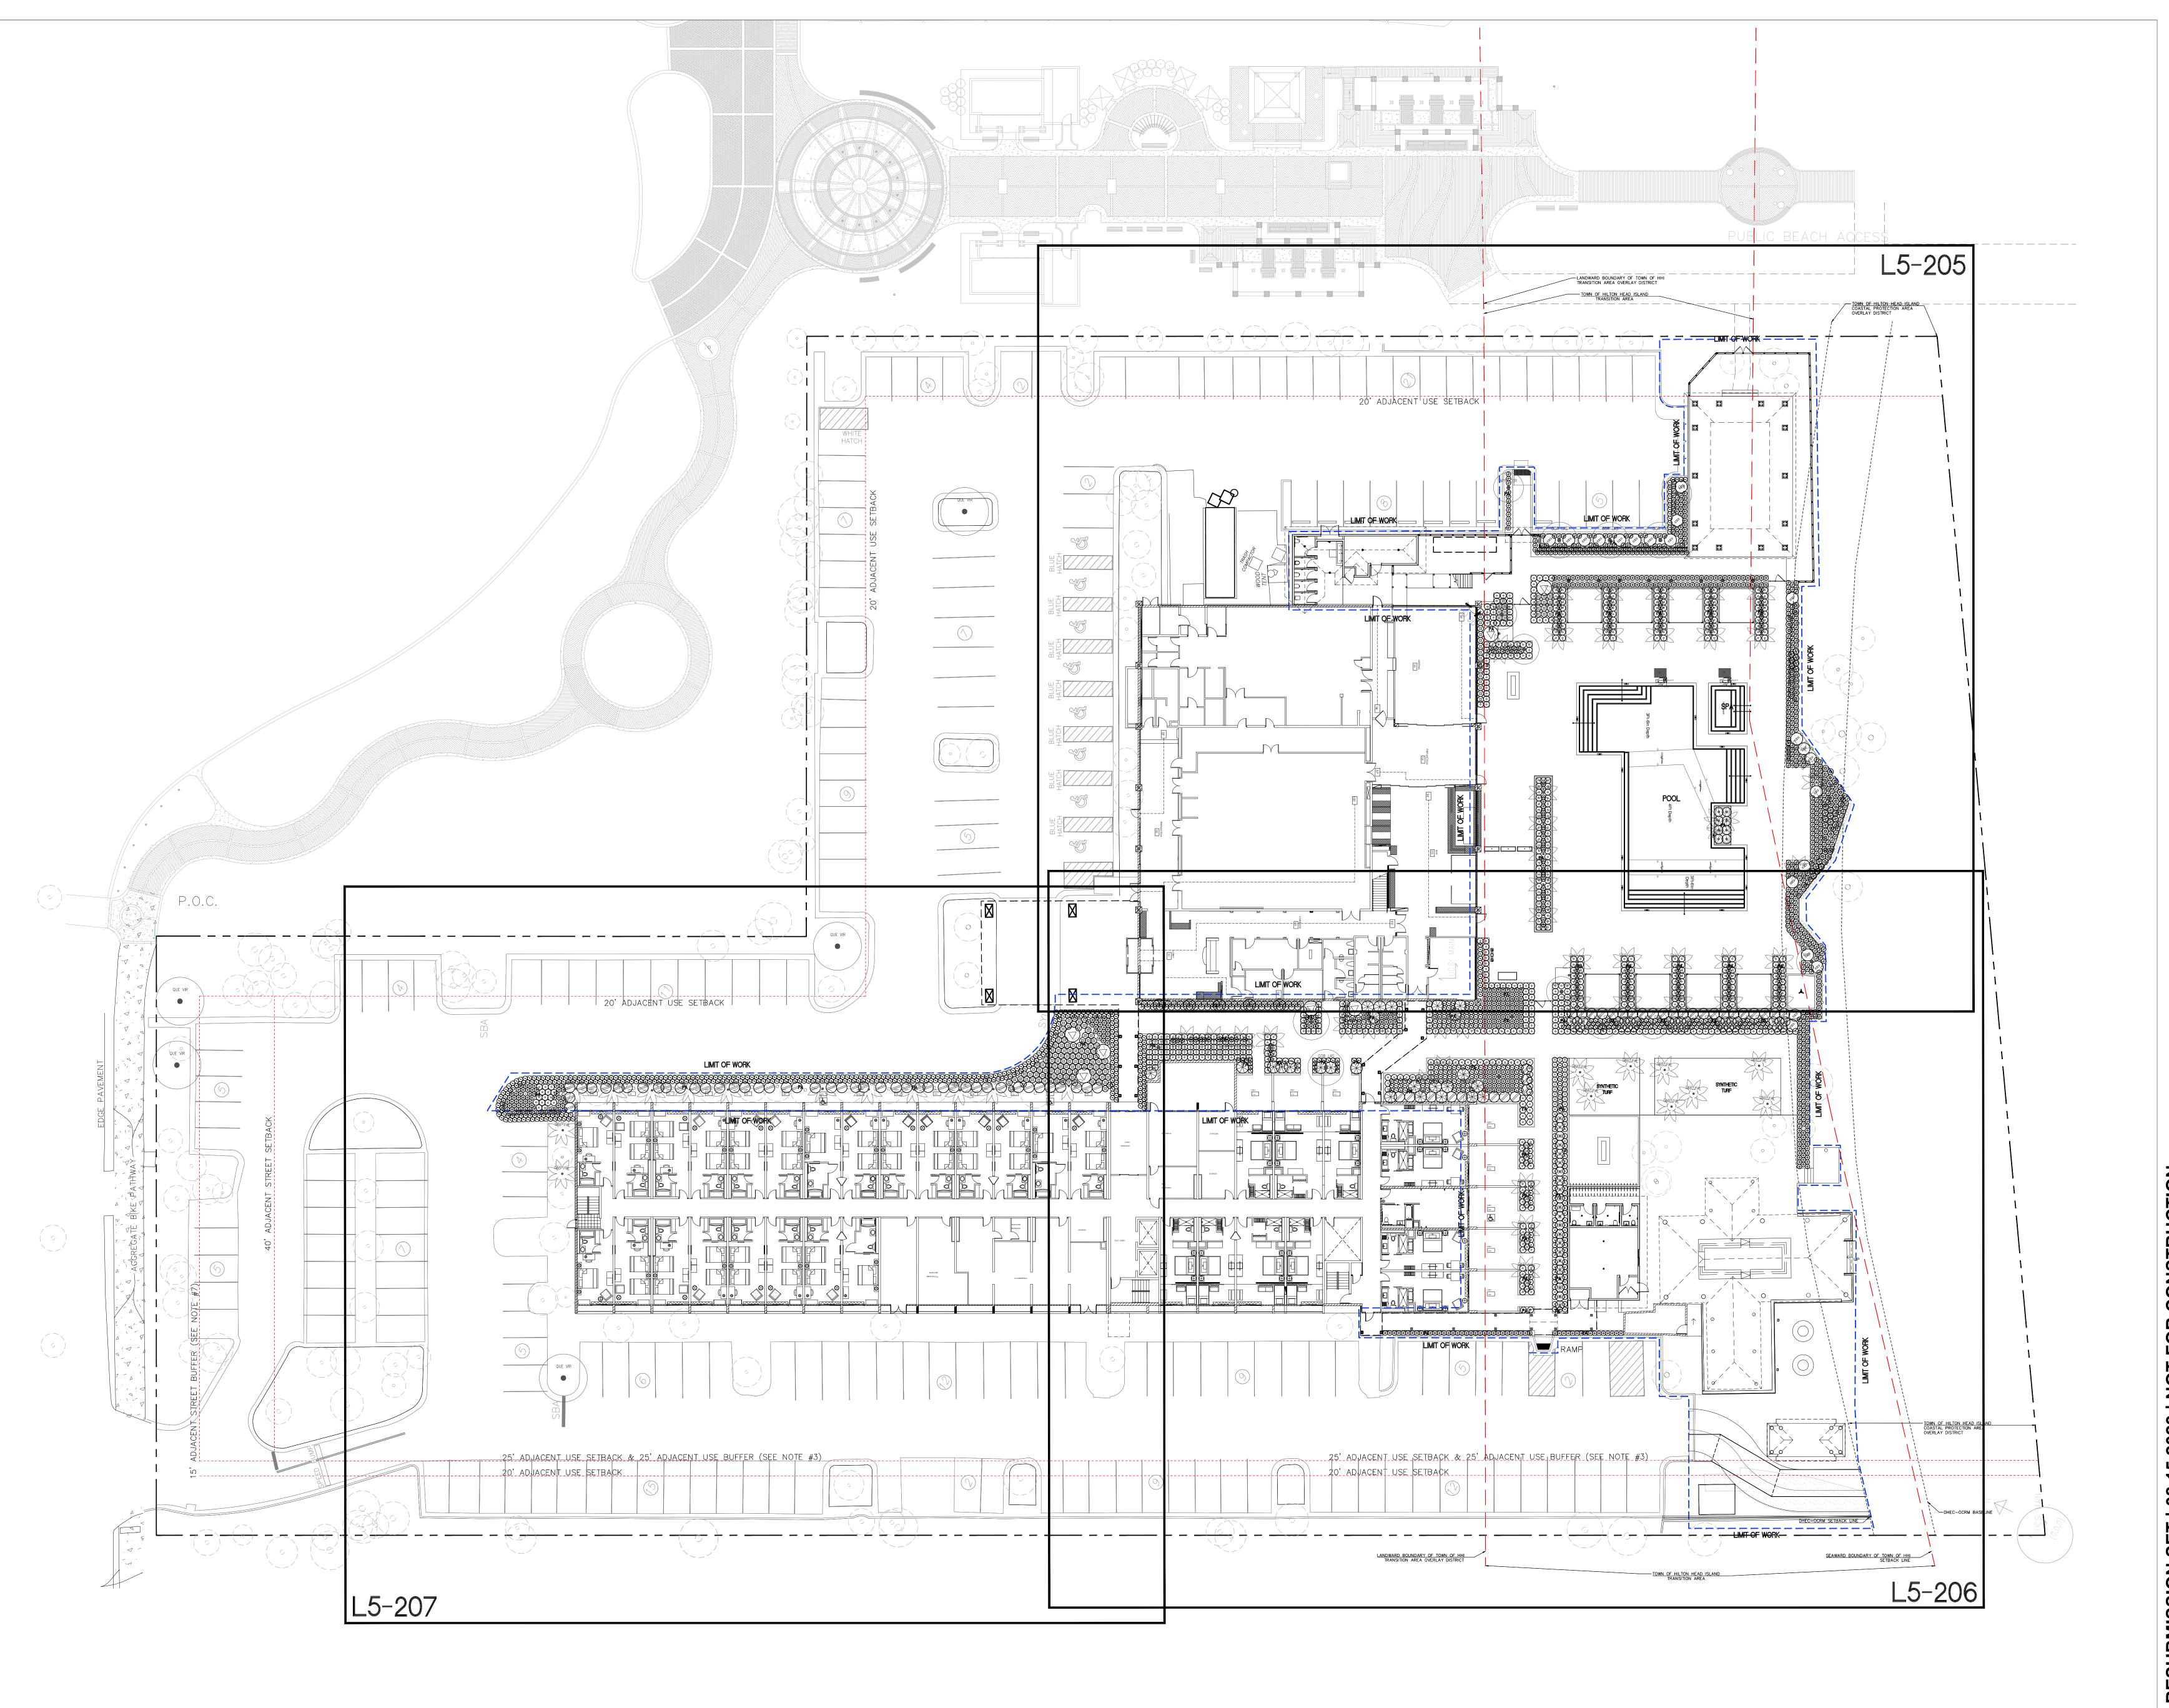
1 SOUTH FOREST BEACH DRIVE
HILTON HEAD, SC 29928

OVERALL SHRUB PLAN

project no. 212041 date 08/19

checked by:
drawn by:

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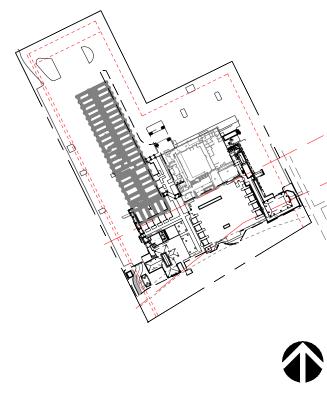

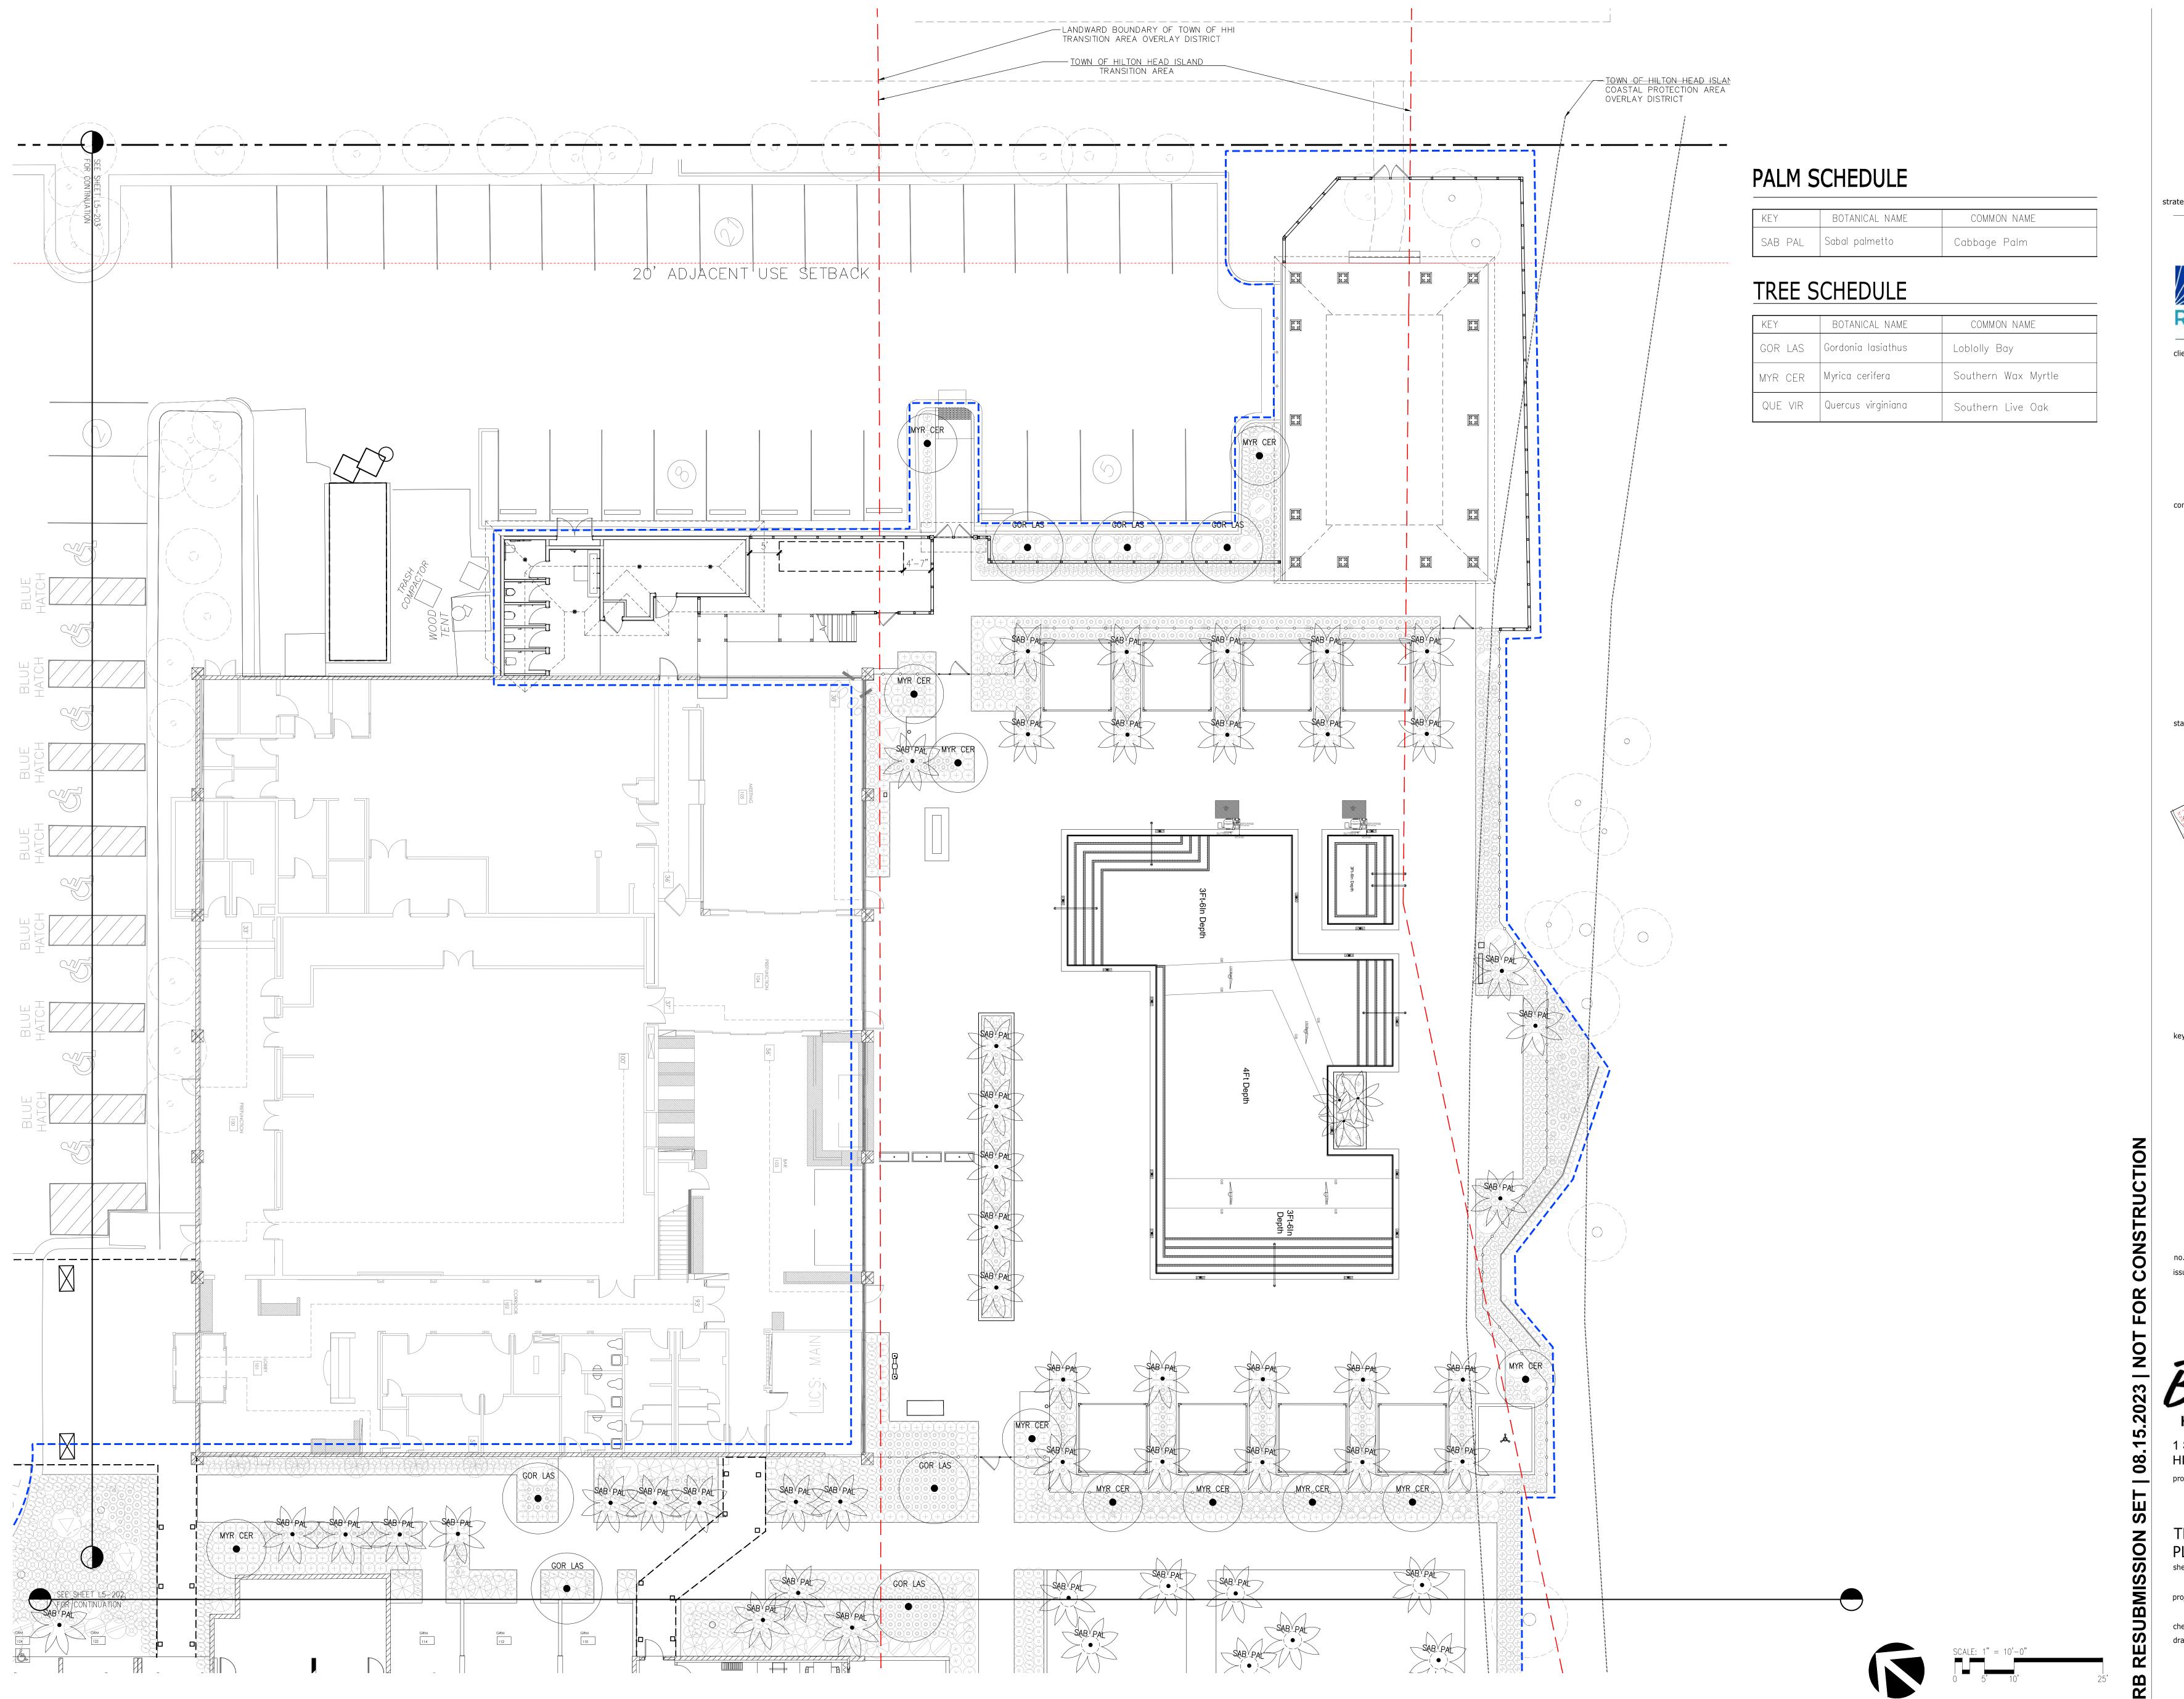
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Beach House

HILTON HEAD ISLAND

1 SOUTH FOREST BEACH DRIVE
HILTON HEAD, SC 29928


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TREE ENLARGEMENT
PLANTING PLAN-POOL DECK

project no. 212041 date 08/15/2
checked by:

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L5-201




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Beach House
HILTON HEAD ISLAND

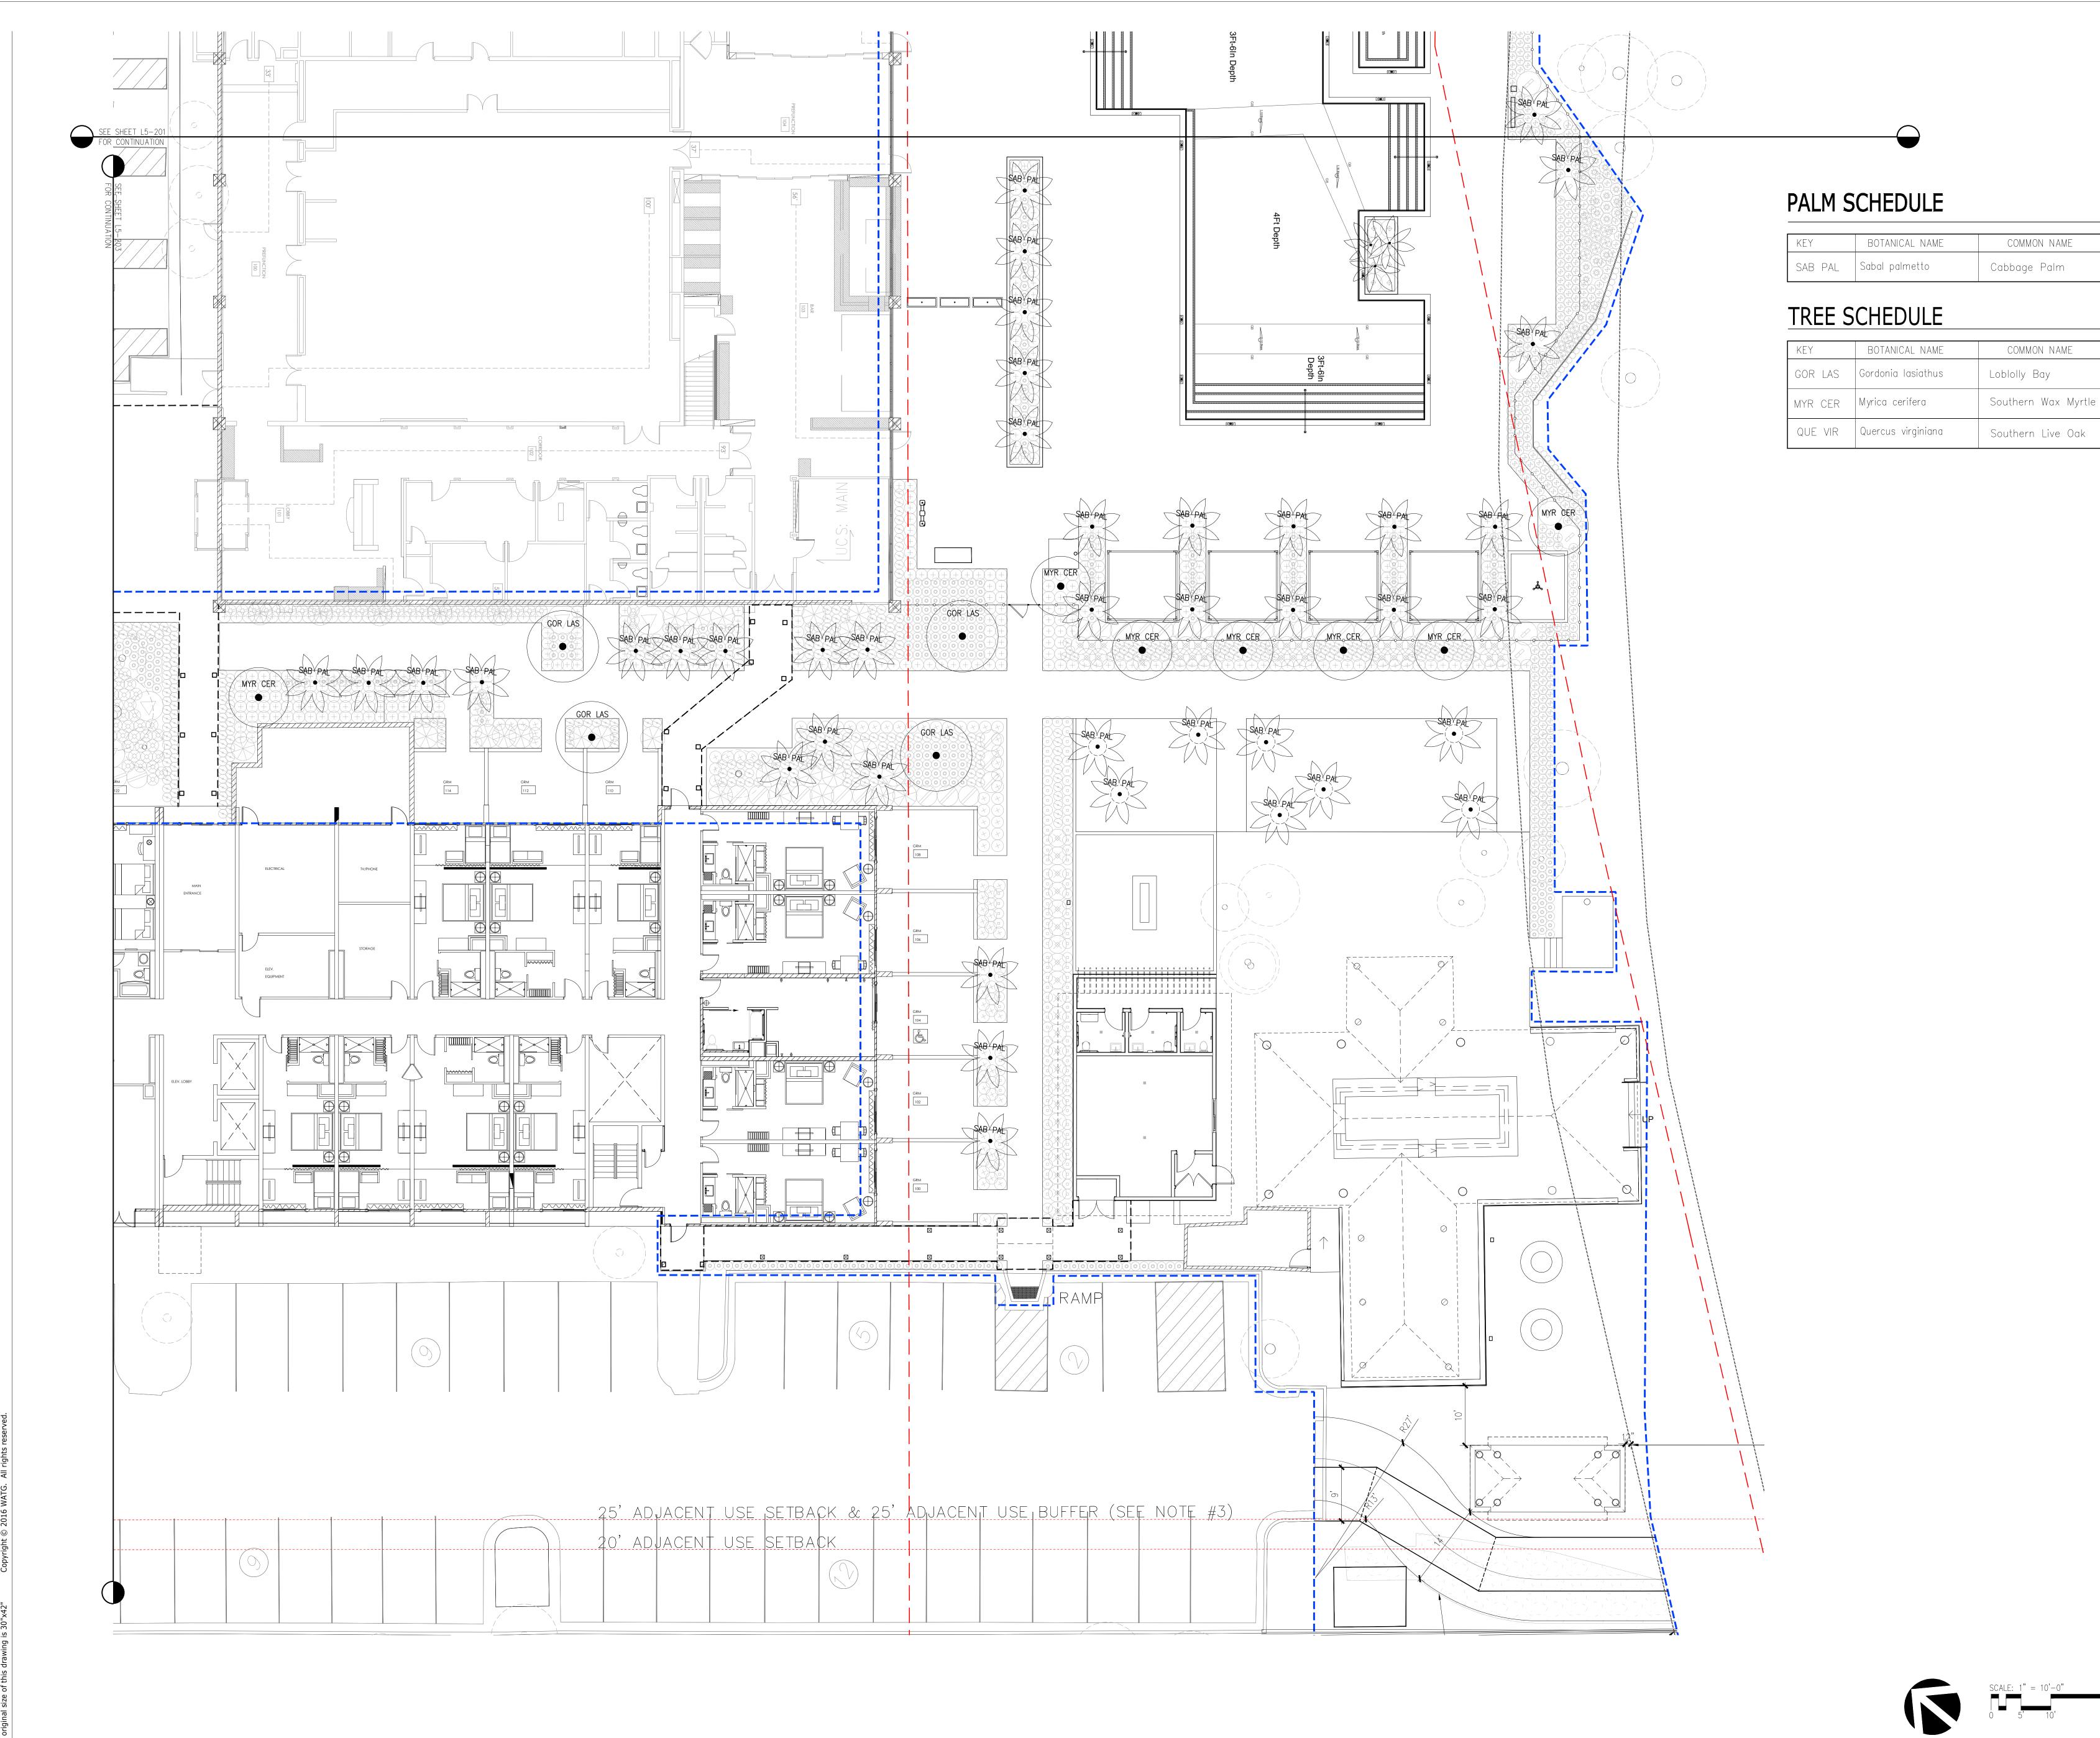
1 SOUTH FOREST BEACH DRIVE HILTON HEAD, SC 29928 project logo

TREE ENLARGEMENT PLANTING PLAN-TIKI BAR AREA

project no. 212041 date 08/15/23


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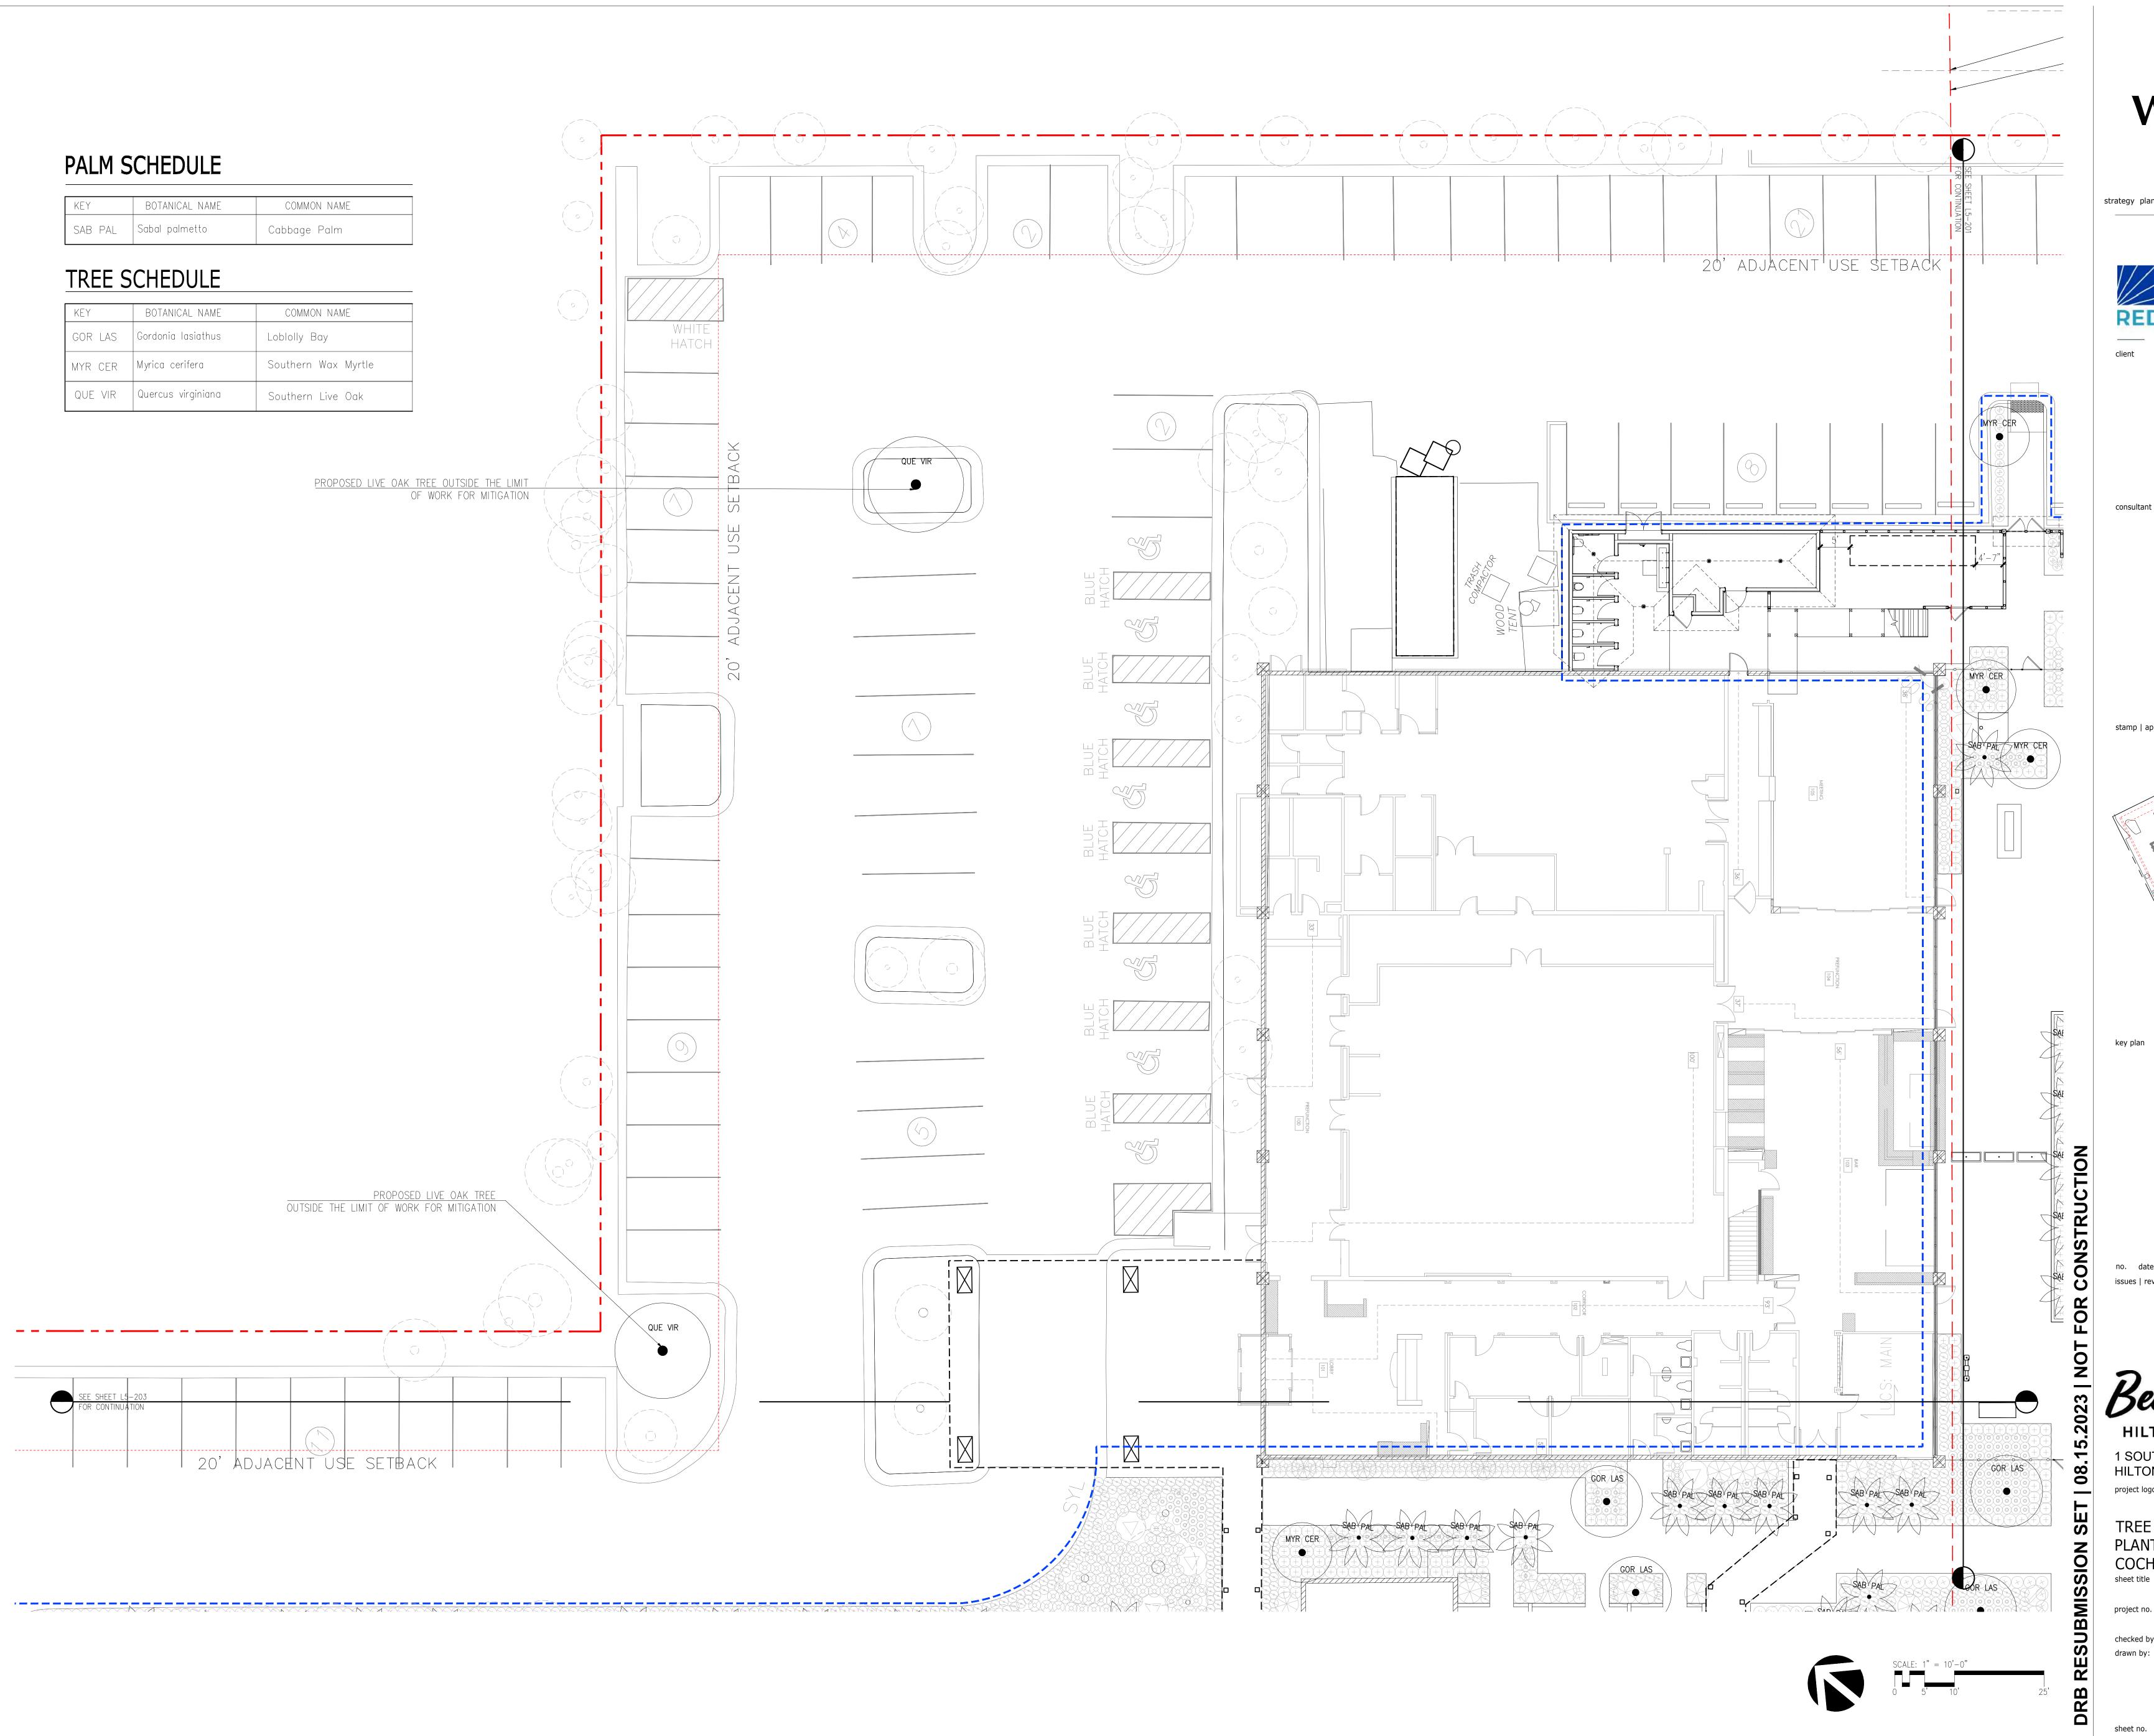
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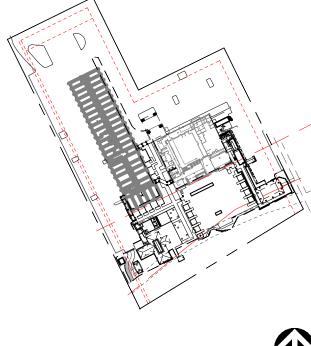
TREE ENLARGEMENT PLANTING PLAN-PARKING sheet title

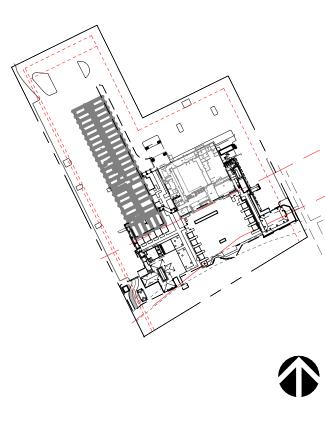
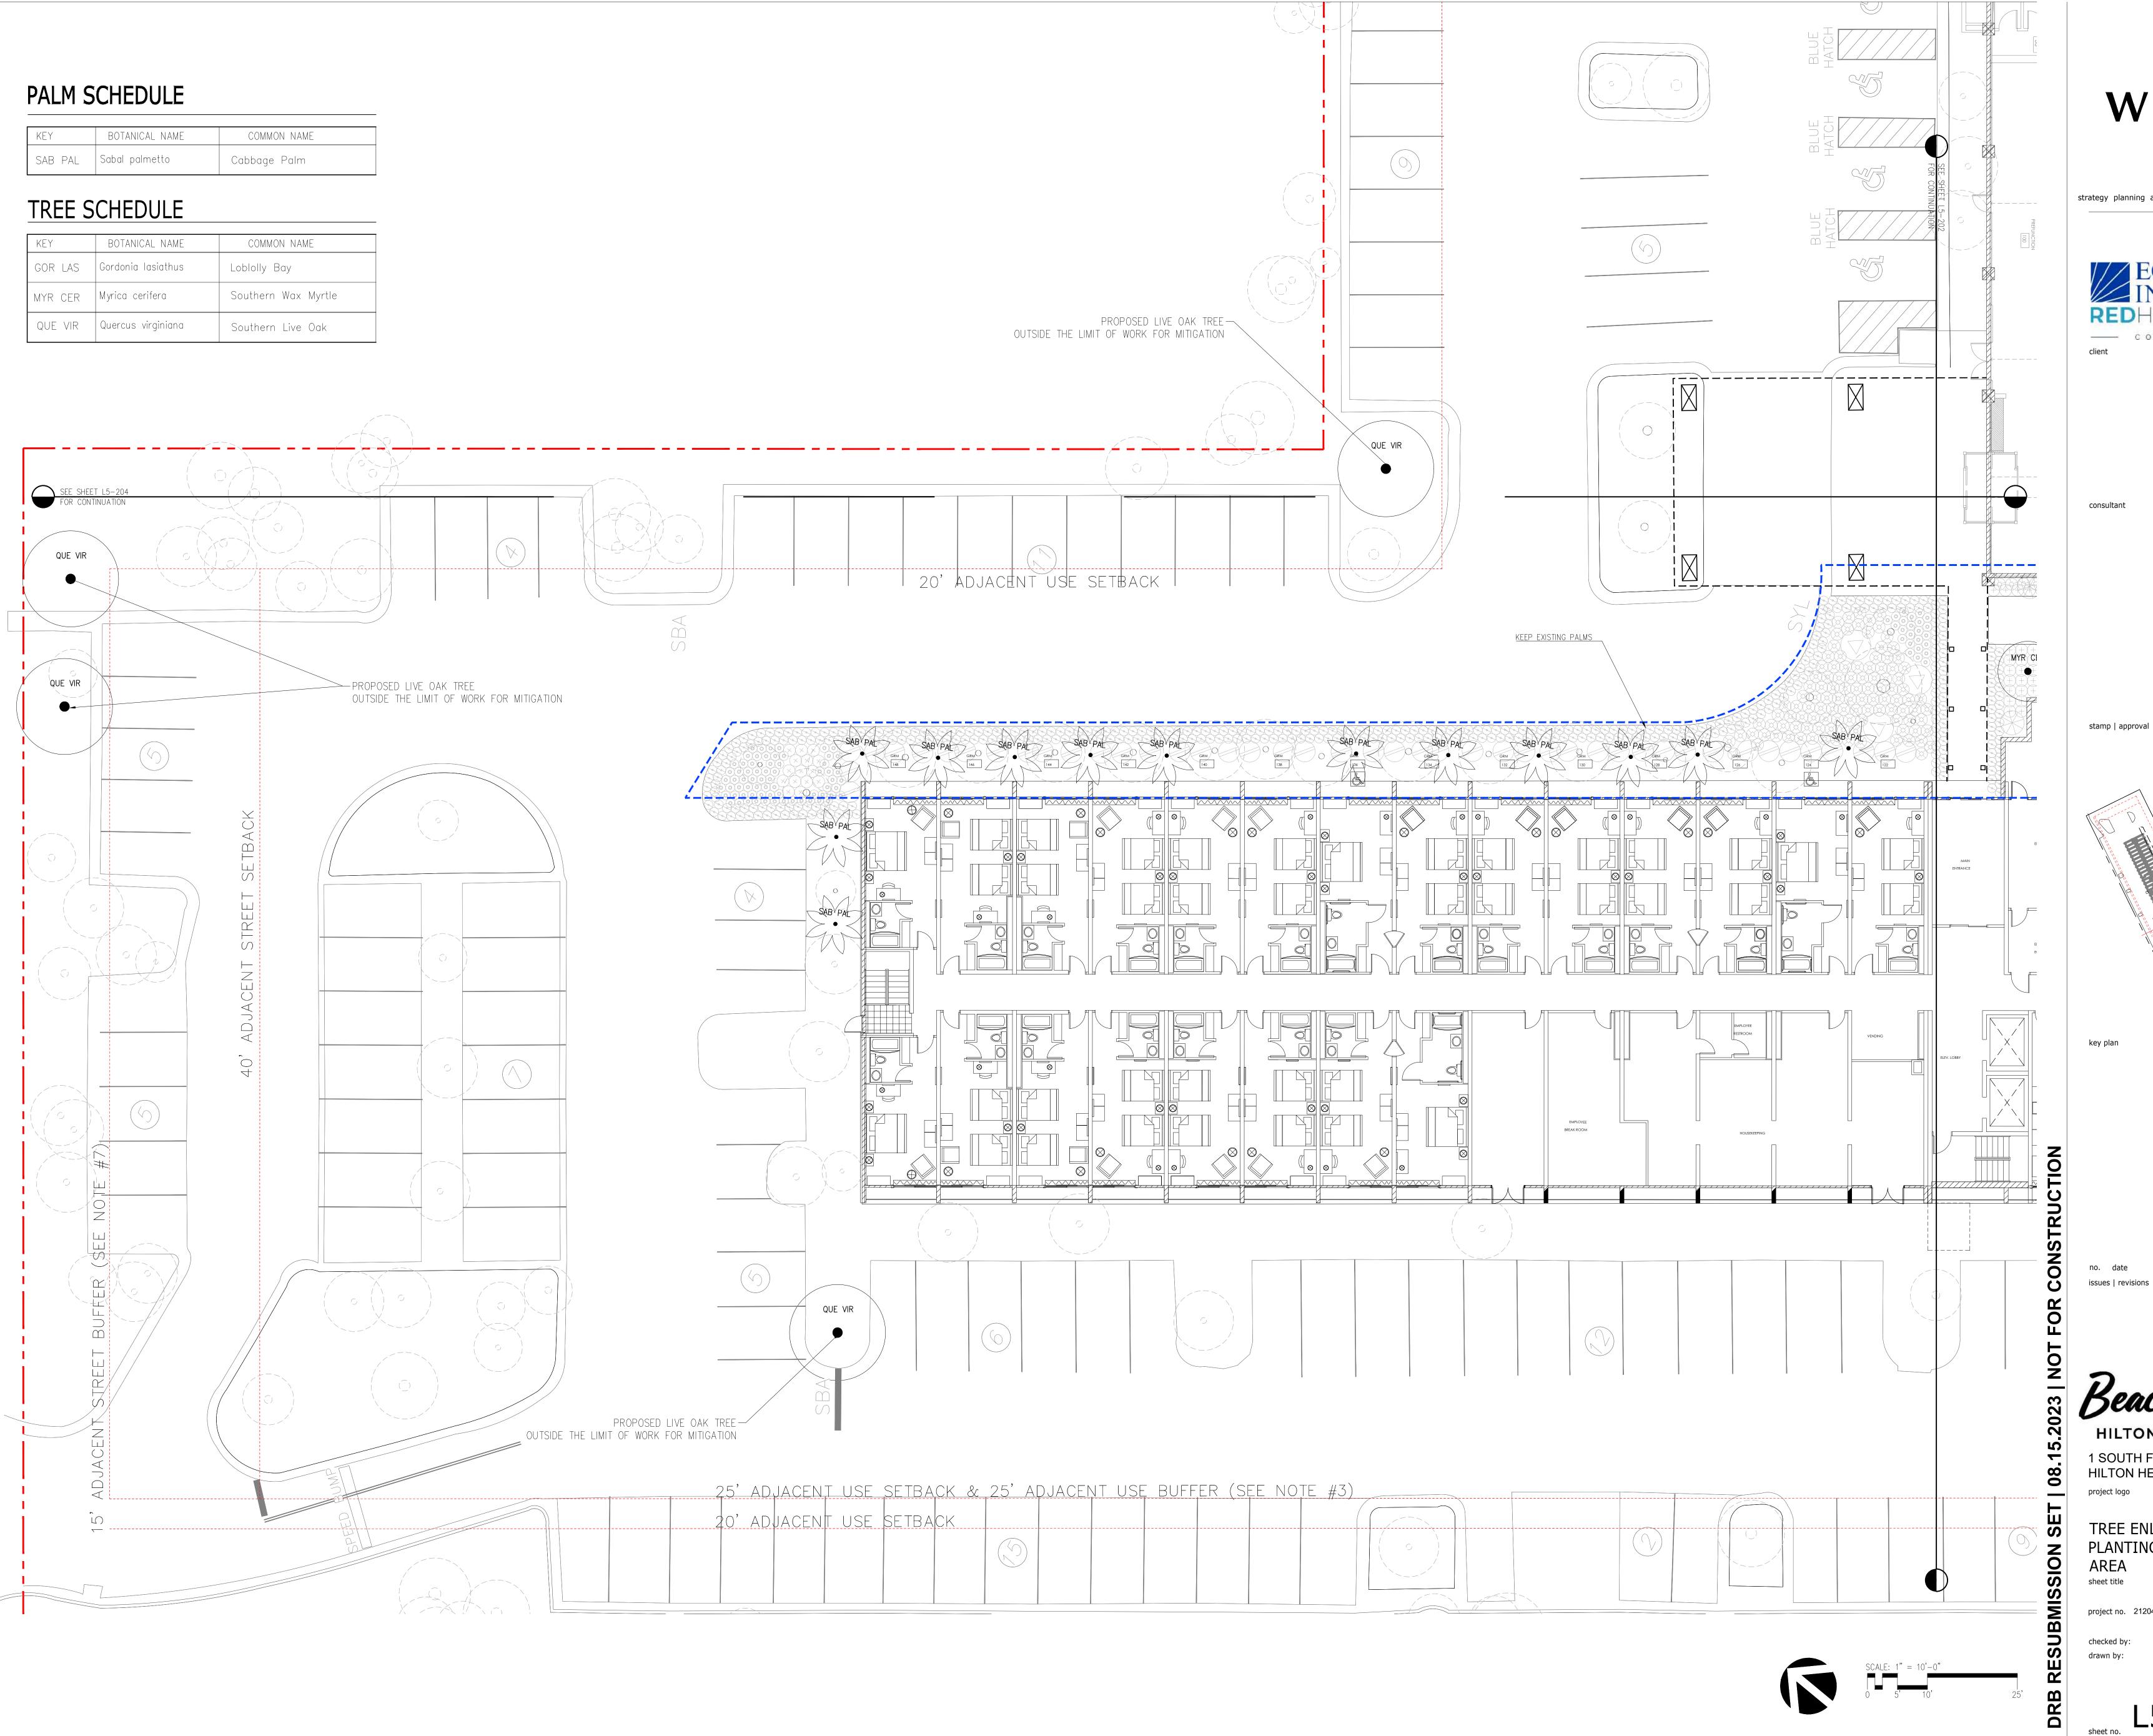
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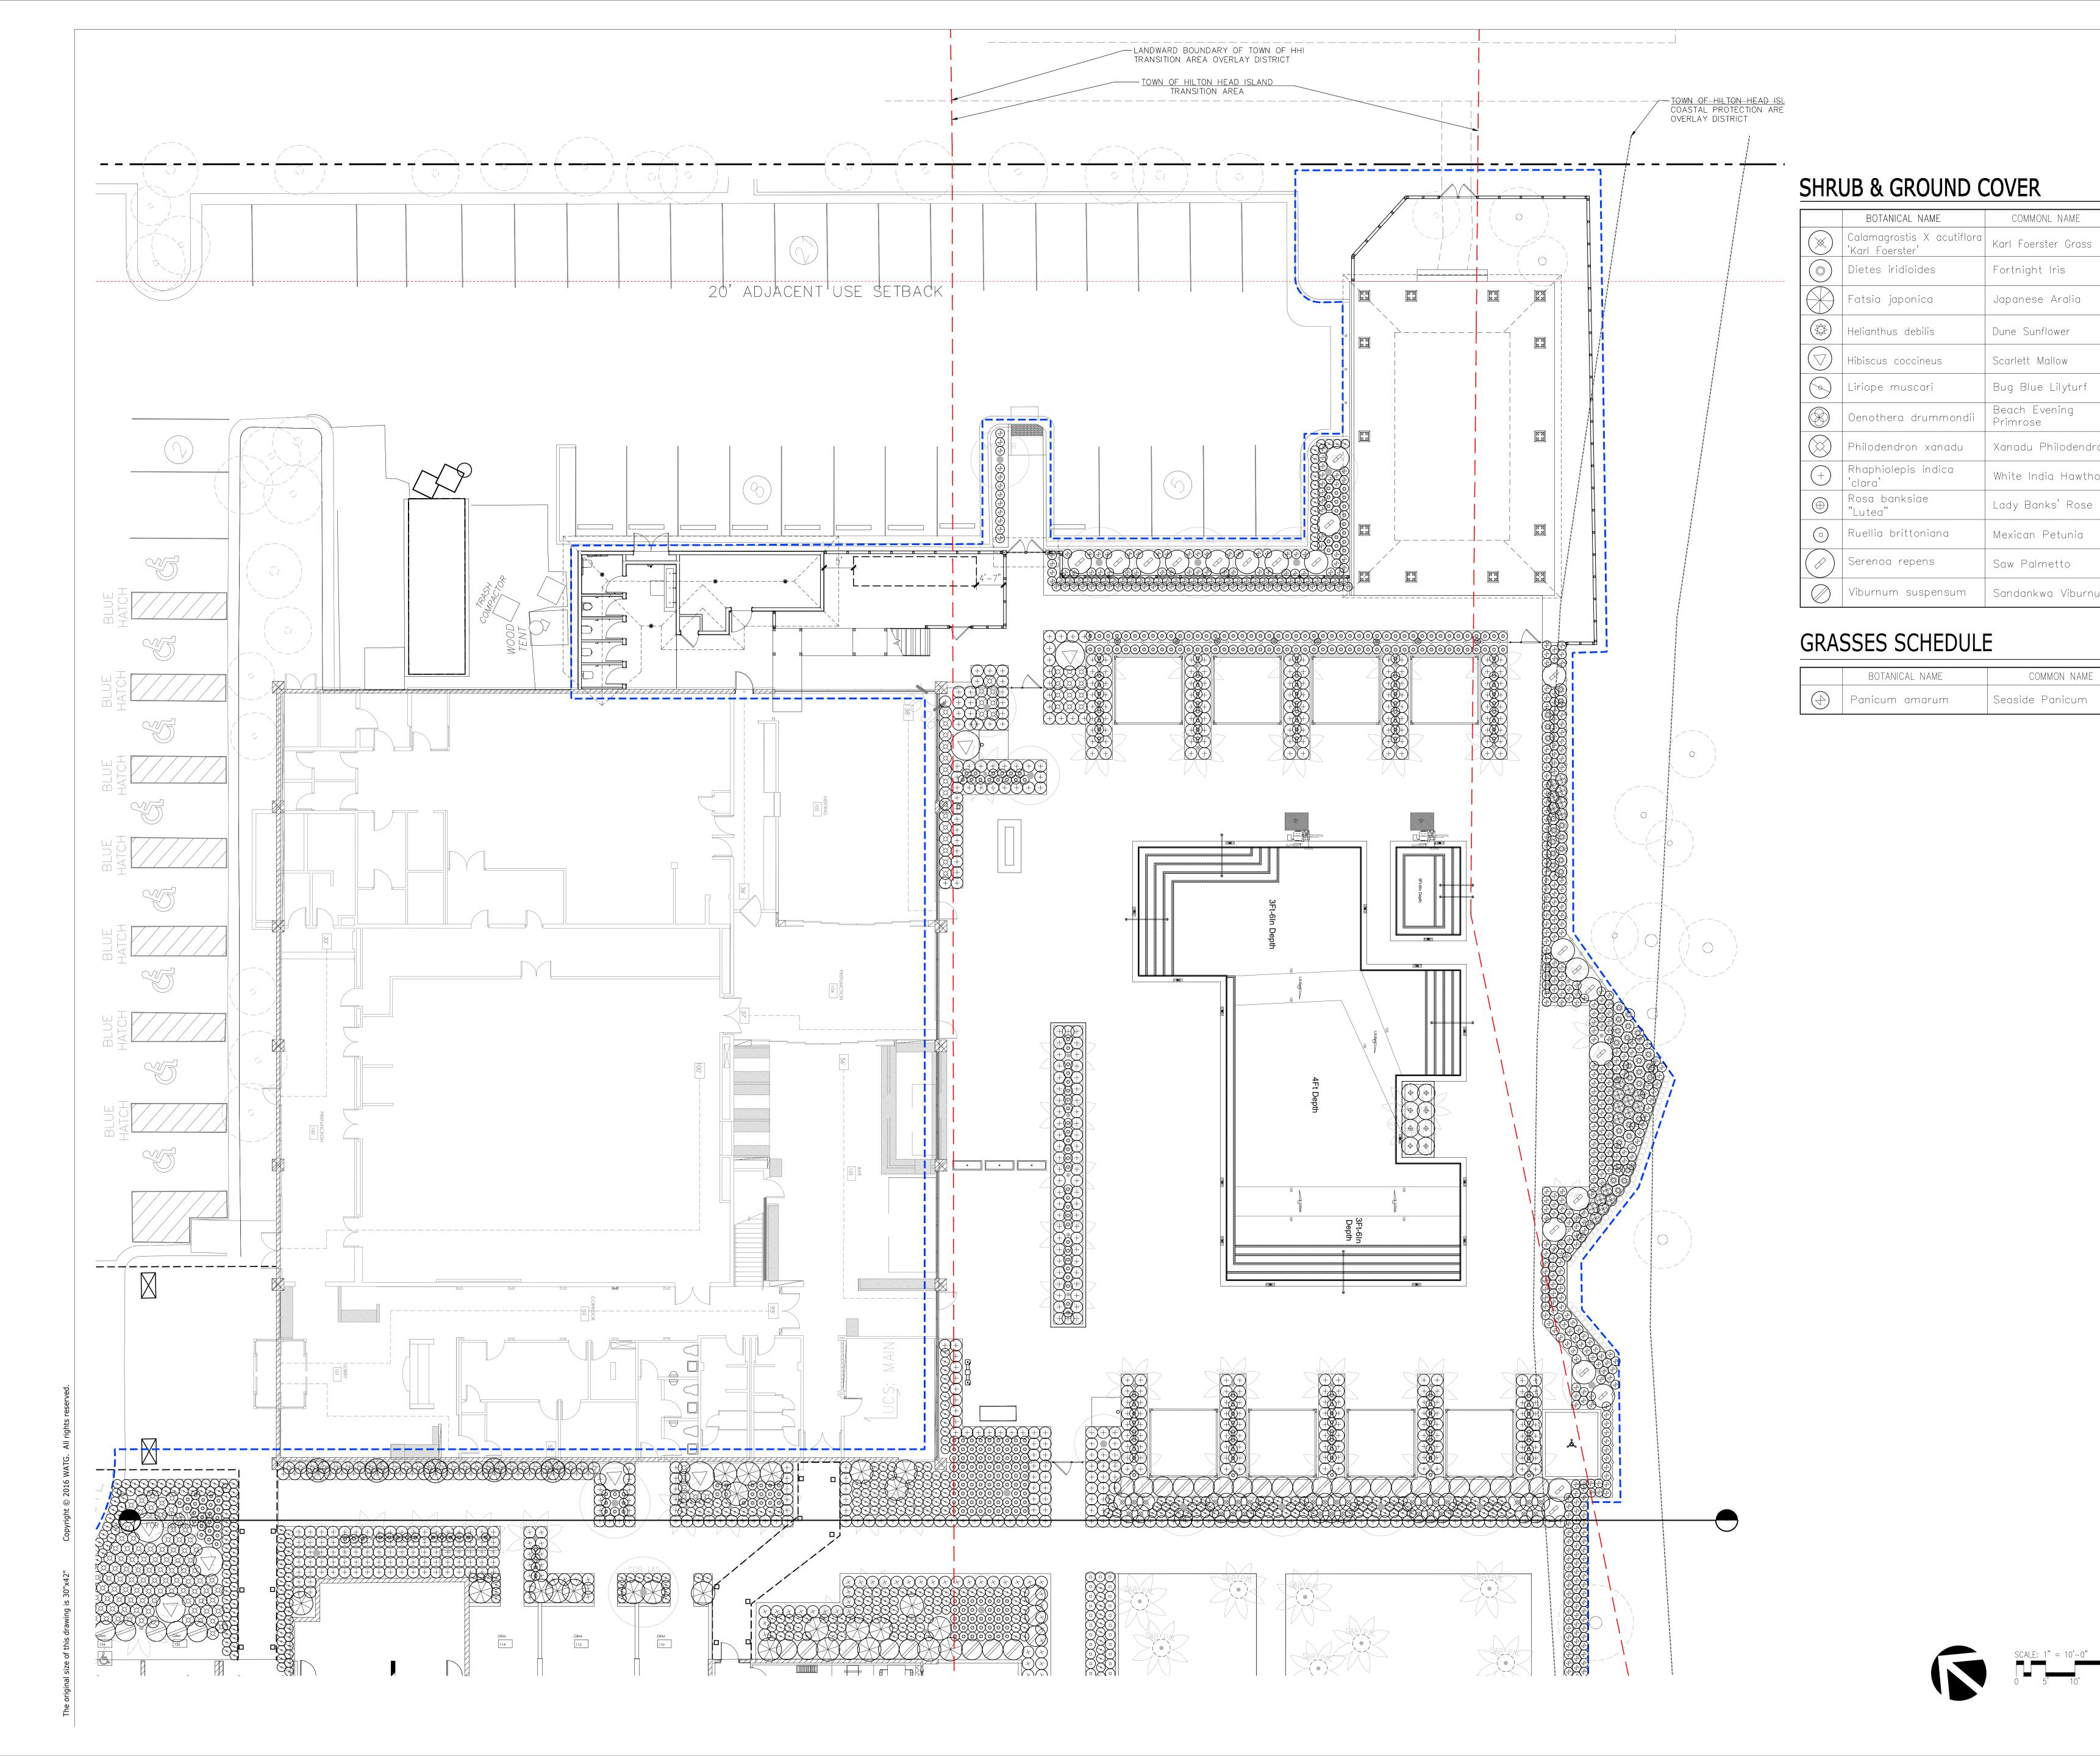


Beach House
HILTON HEAD ISLAND

1 SOUTH FOREST BEACH DRIVE HILTON HEAD, SC 29928

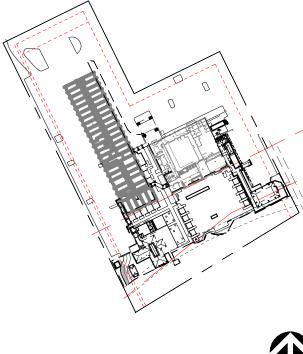TREE ENLARGEMENT PLANTING PLAN-PORTE COCHERE

checked by:



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COMMONL NAME

Fortnight Iris

Dune Sunflower

Scarlett Mallow

Bug Blue Lilyturf

| Beach Evening

Xanadu Philodendron

White India Hawthorn

Lady Banks' Rose

Mexican Petunia

Saw Palmetto

Sandankwa Viburnum


COMMON NAME

Seaside Panicum

Japanese Aralia


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1 SOUTH FOREST BEACH DRIVE HILTON HEAD, SC 29928

SHRUB ENLARGEMENT PLANTING PLAN-POOL DECK

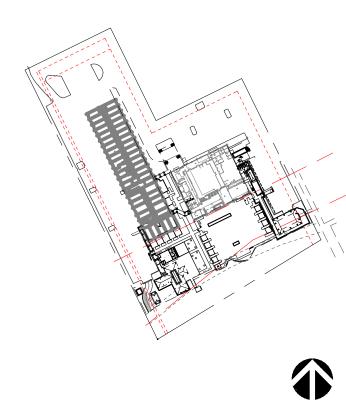

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COMMONL NAME

Karl Foerster Grass

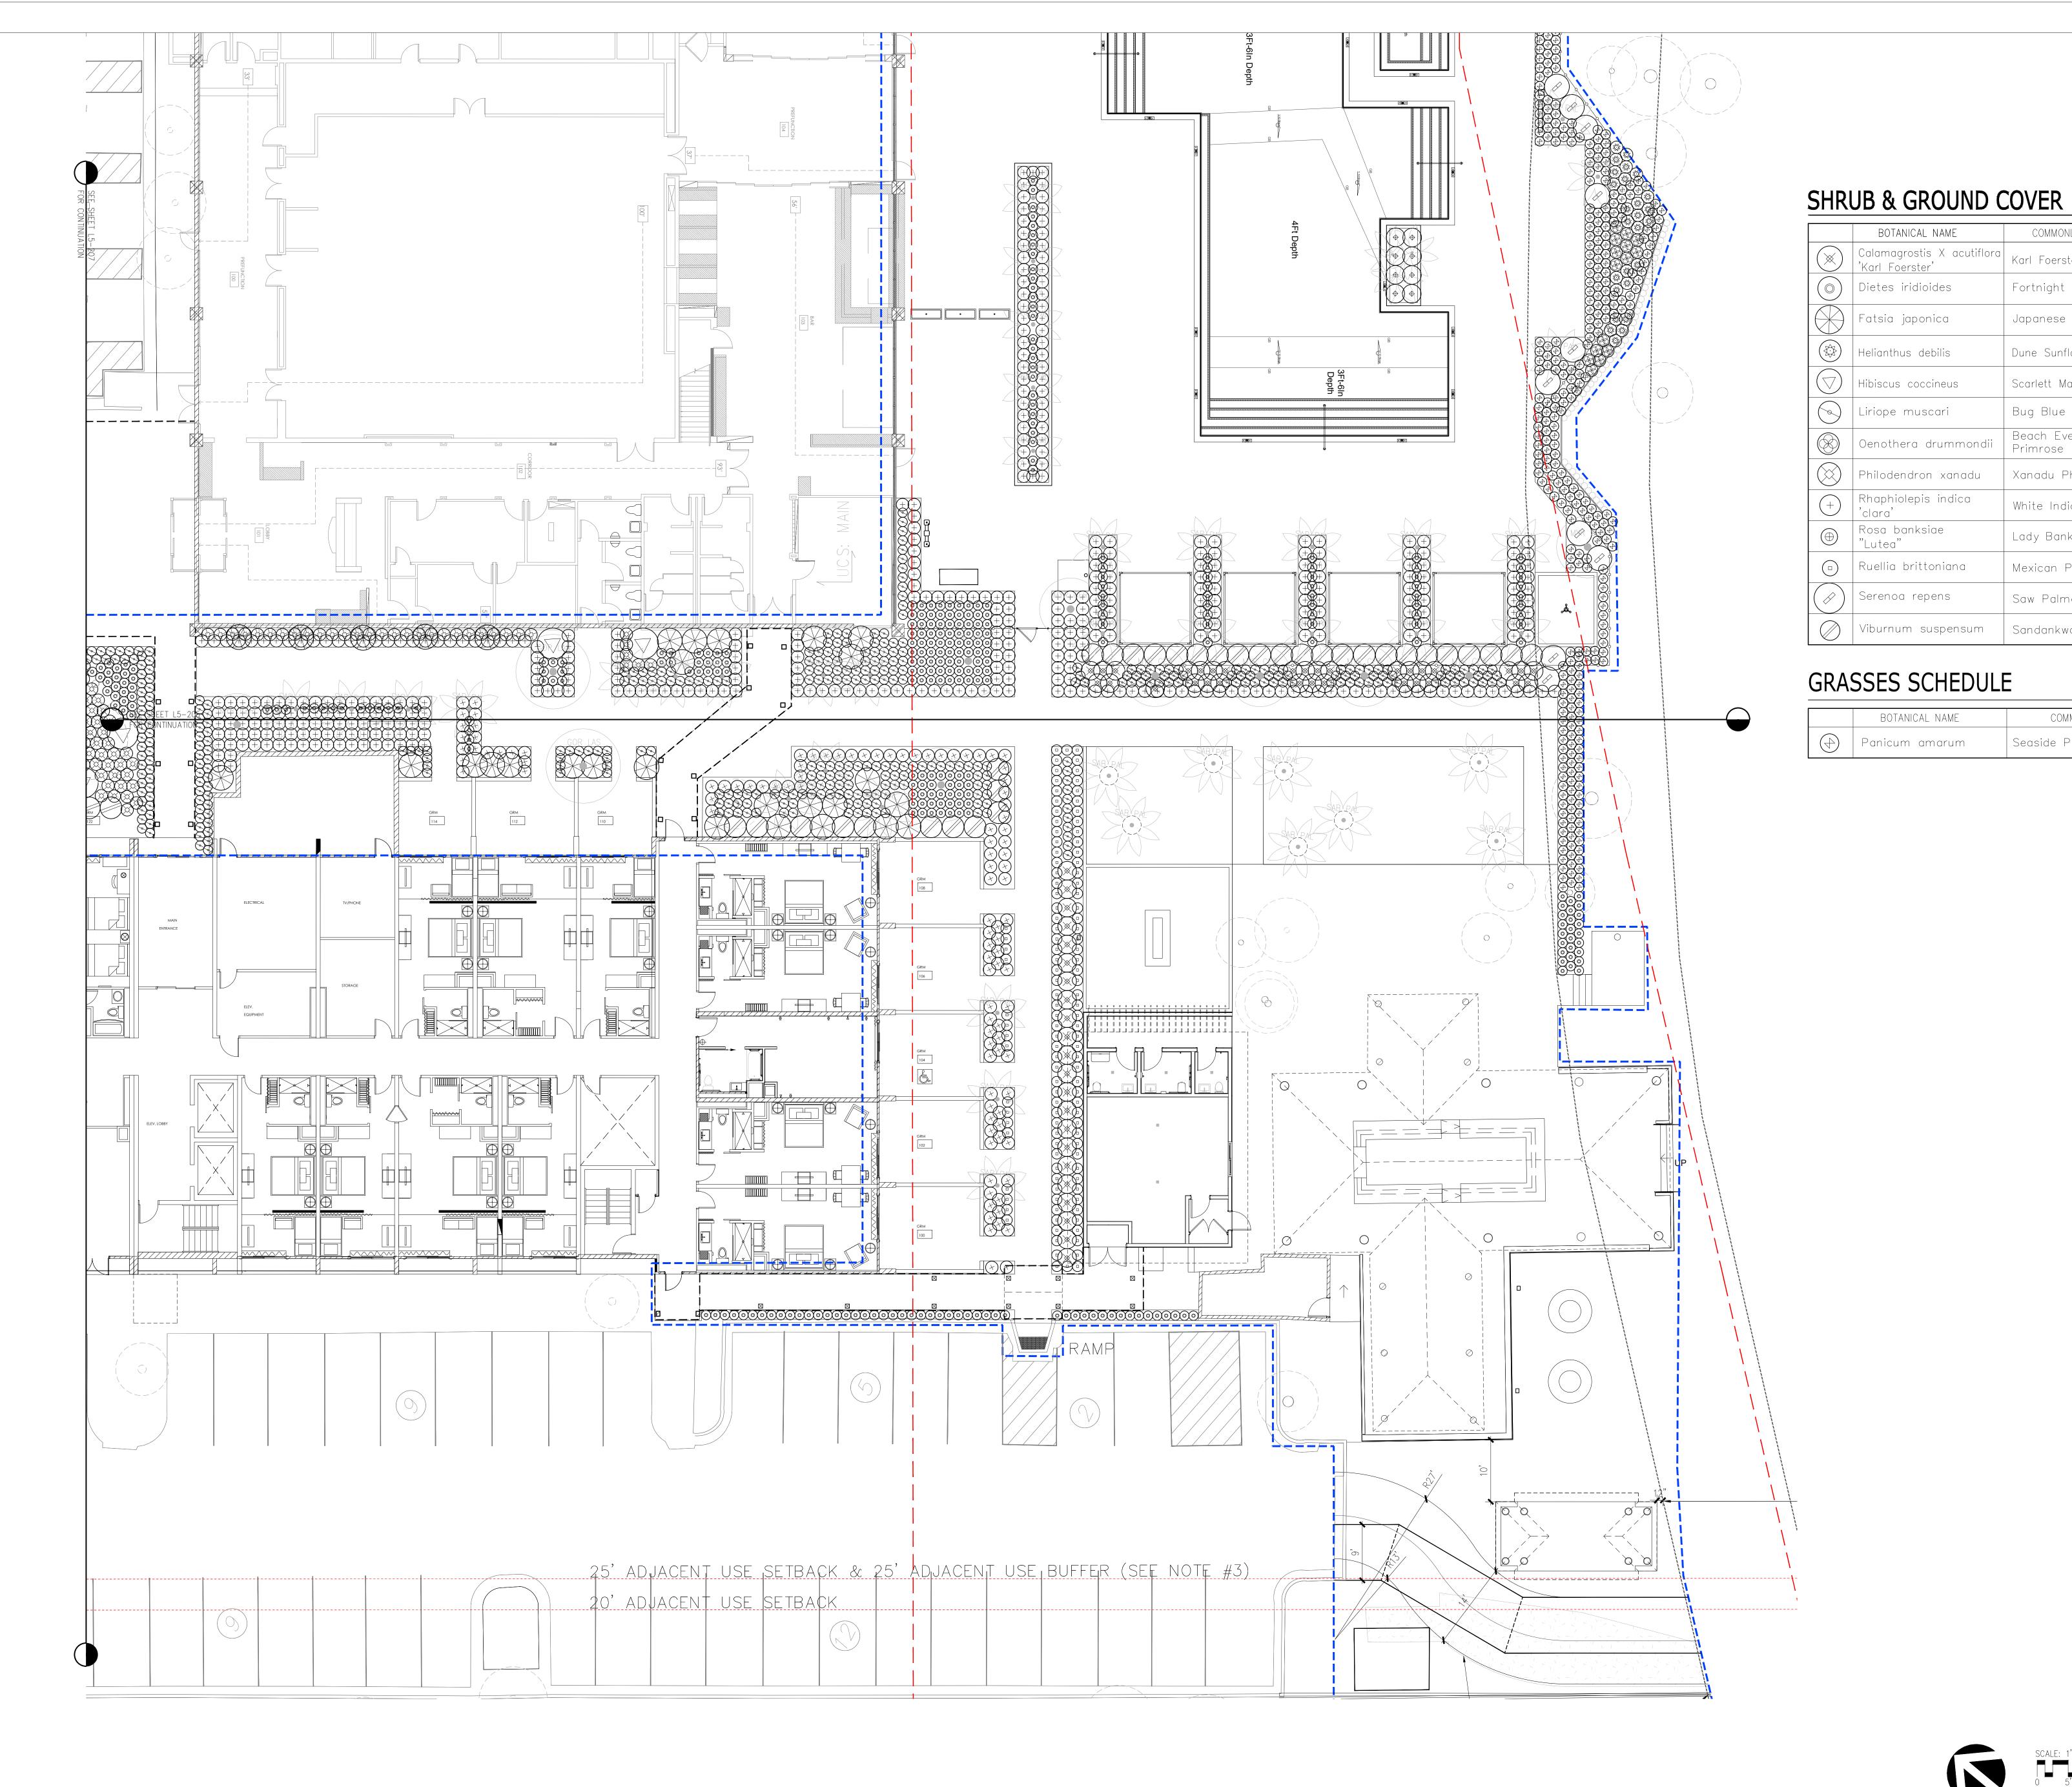Japanese Aralia

Fortnight Iris

Dune Sunflower

Scarlett Mallow

Bug Blue Lilyturf

Xanadu Philodendron

White India Hawthorn

Lady Banks' Rose

Mexican Petunia


Saw Palmetto

Sandankwa Viburnum

COMMON NAME


Seaside Panicum



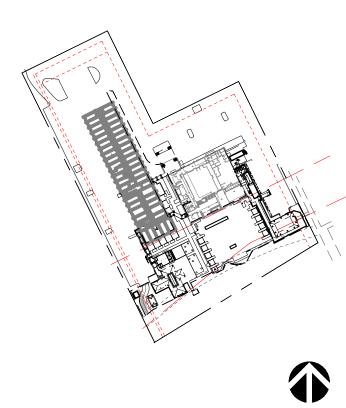

HILTON HEAD, SC 29928

SHRUB ENLARGEMENT PLANTING PLAN-TIKI BAR

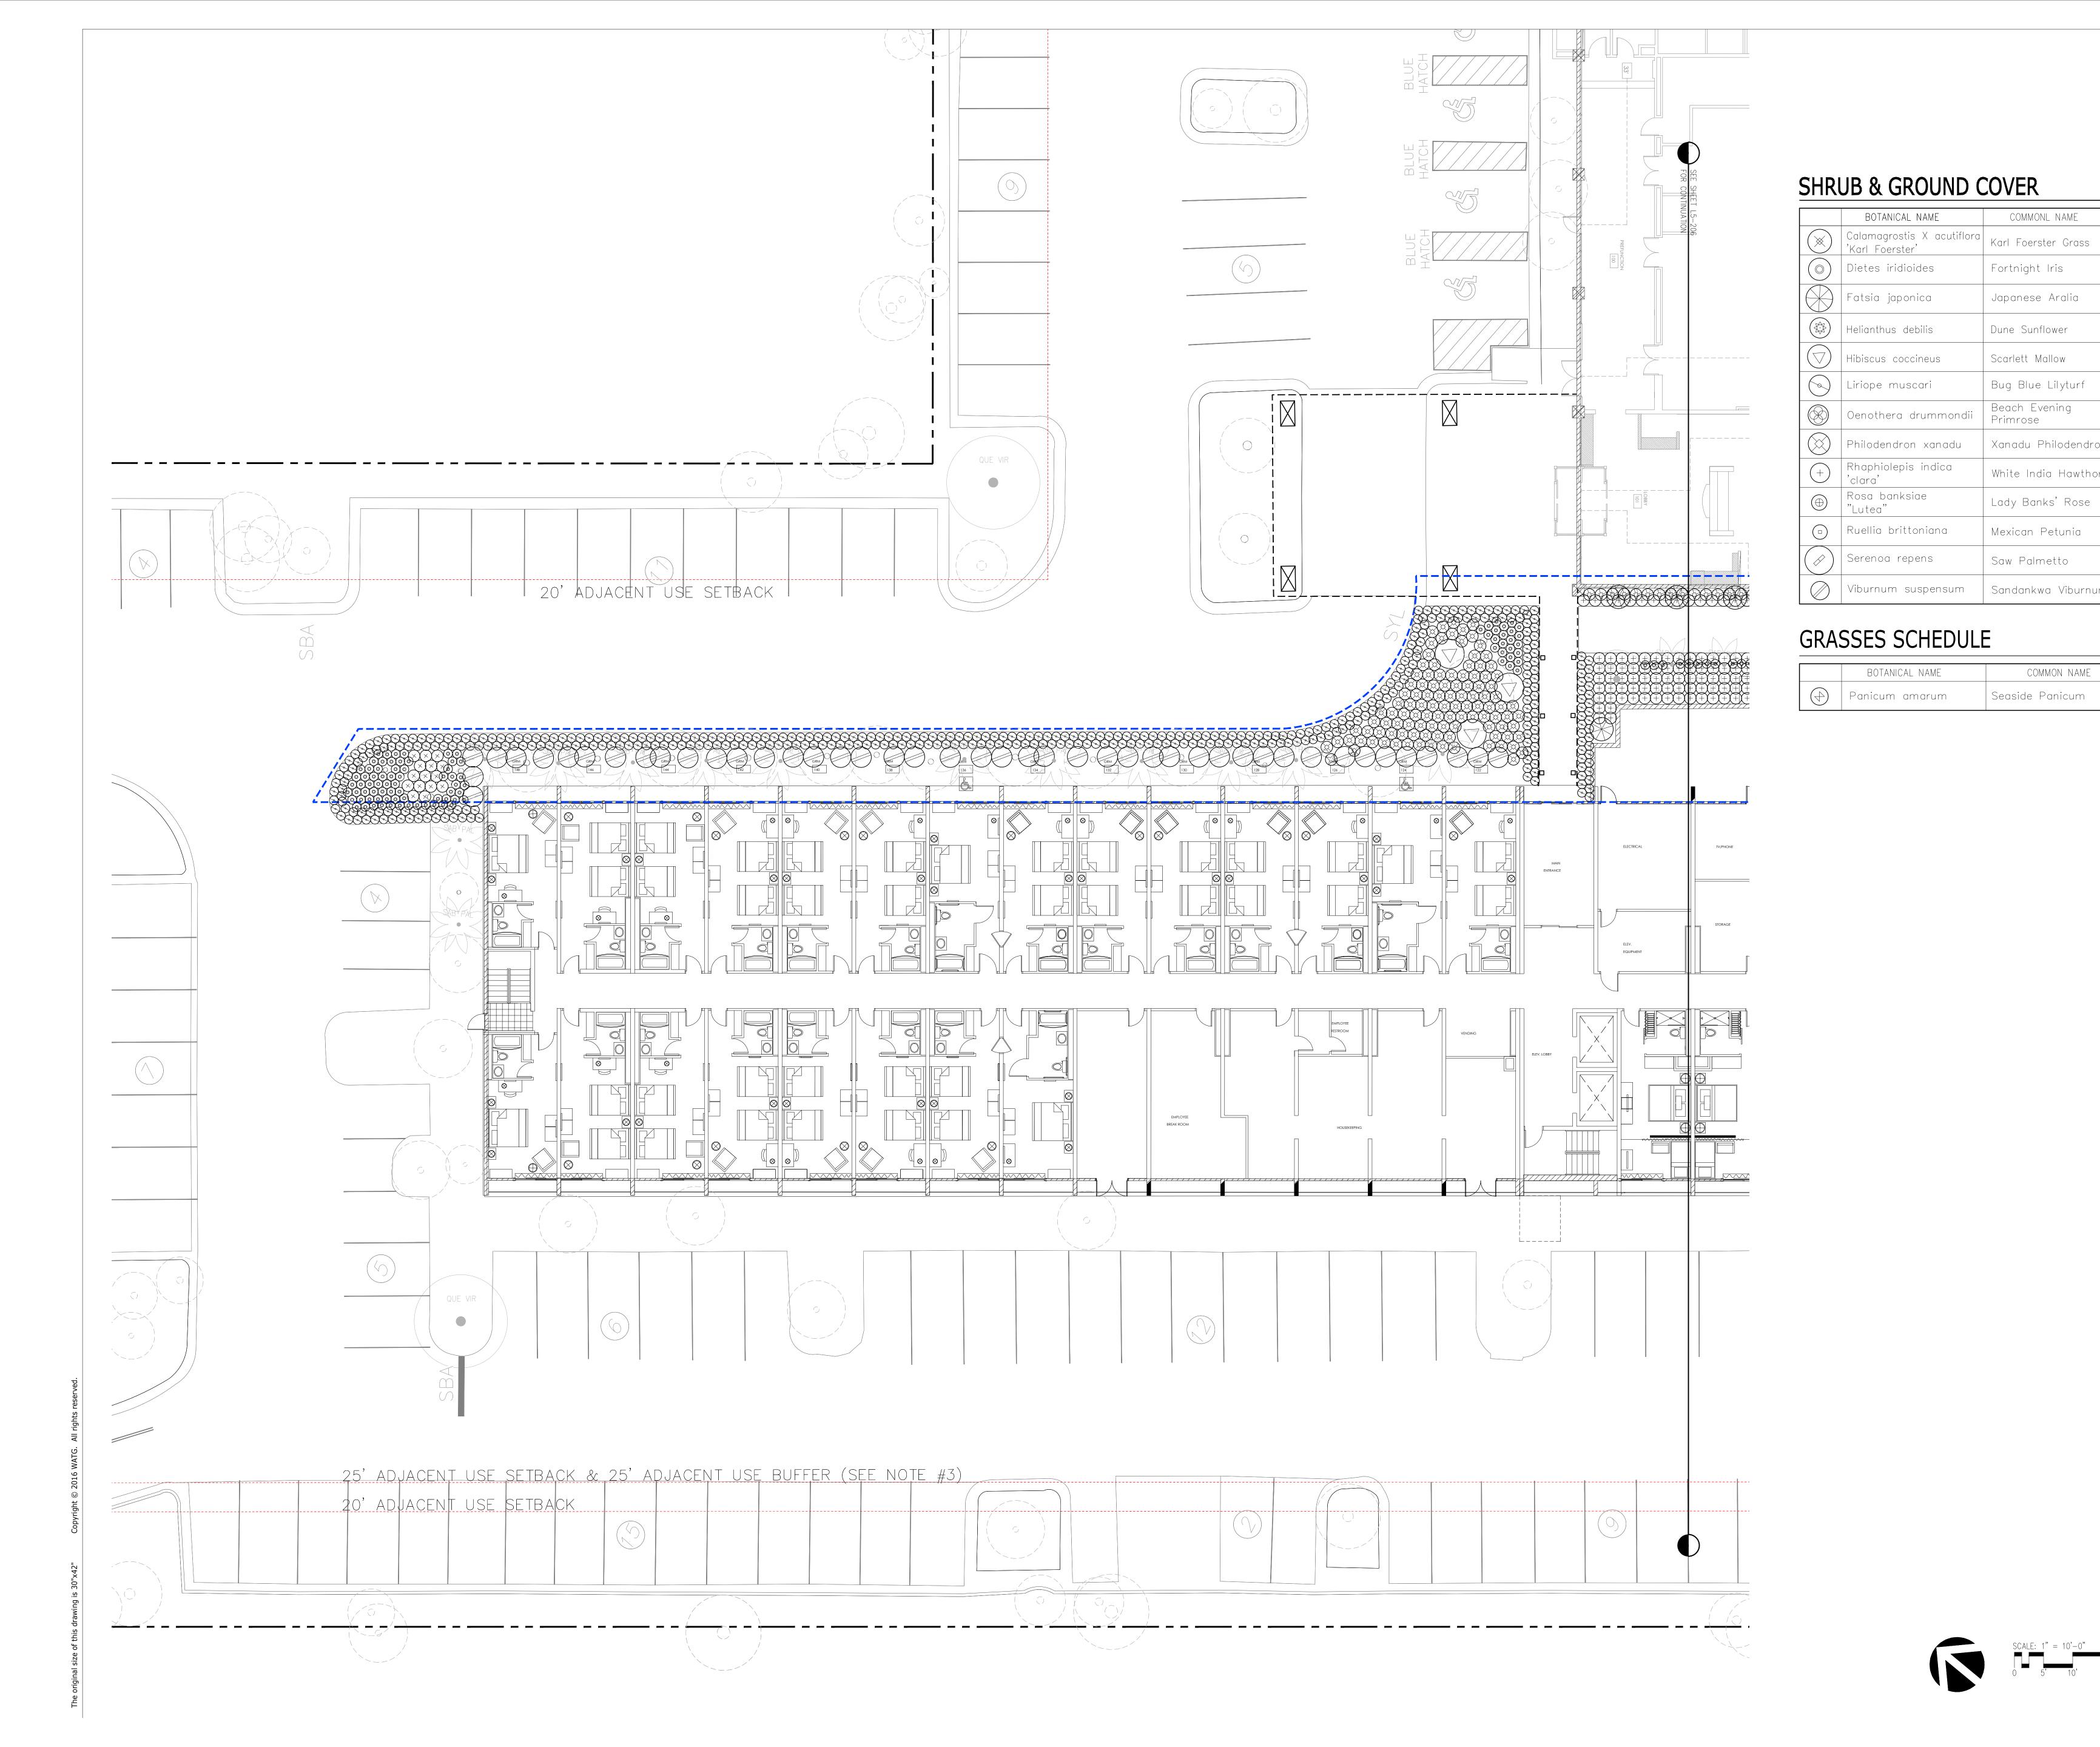

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COMMONL NAME

Fortnight Iris

Dune Sunflower

Scarlett Mallow

Bug Blue Lilyturf

Beach Evening

Xanadu Philodendron

White India Hawthorn

Sandankwa Viburnum

COMMON NAME

Seaside Panicum

Lady Banks' Rose

Mexican Petunia


Saw Palmetto

Japanese Aralia



consultant

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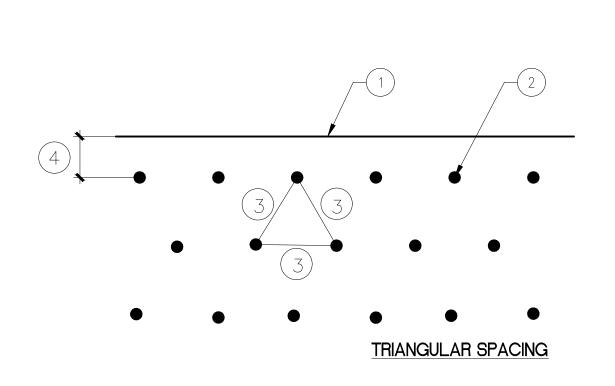


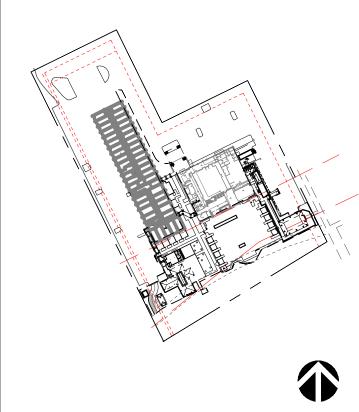HILTON HEAD, SC 29928

TREE ENLARGEMENT

PLANTING PLAN-PARKING

- EDGE OF PAVING, SIDEWALK, WALL OR CURB.
   SHRUB OR GROUND COVER PLANT.
- 3. LOCATE PLANT EQUAL DISTANCE FROM EACH OTHER. SPACING PER PLANT LEGEND.
- 4. 1/2 OF PLANT SPACING DISTANCE-18"MIN.




#### SHRUB/GROUND COVER SPACING

#### **LEGEND**

- 1. SHRUB CENTER IN PIT.
- 2. 2" DEEP WATER BASIN. 3. FINISH GRADE.
- 4. AMENDED BACKFILL PER HORTICULTURAL SOILS REPORT AND
- 5. PLANT TABLETS QUANTITY PER HORTICULTURAL SOILS REPORT
- AND MANUFACTURER'S RECOMMENDATIONS.

  6. 3" HEIGHT UNAMENDED SITE SOIL PEDESTAL FOR 15 GAL SHRUBS.
- 7. UNAMENDED SITE SOIL.

A. REFER TO PLANTING NOTES ON THIS SHEET FOR ADDITIONAL INFORMATION. B. SET ROOT BALL 1" ABOVE FINISH GRADE.

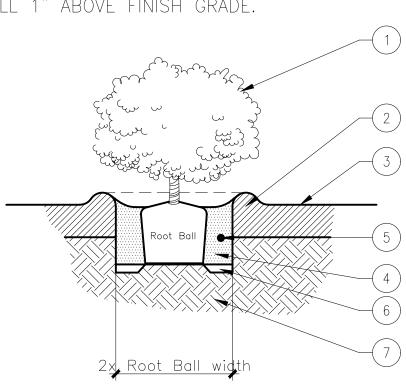

PL-02 A PALM PLANTING SHRUB PLANTING


#### **LEGEND**

- 1. TRIM PALM TREE FRONDS AND TIE WITH ORGANIC STRING PRIOR TO DELIVERY TO SITE. REMOVE TIES ONLY WHEN APPROVED BY PALM TREE
- SUPPLIER AND LANDSCAPE ARCHITECT. 2. PINEAPPLE — CLEAN AND UNDAMAGED.
- 3. FINISH GRADE OF PALM ROOTBALL CENTER IN PIT. DO NOT BURY
- ROOTBALL OR TRUNK. 4. WATERING BASIN — 3" MIN. DEPTH.
- 5. PALM TRUNK STRAIGHT, CLEAN, AND UNDAMAGED.

- 6. BACKFILL MIX 100% WASHED SILICA SAND #16. 7. 12" LAYER OF 3/4" CRUSHED GRAVEL. 8. 4" PLASTIC ATRIUM DRAIN COVER (TURF GREEN, SHRUB AREAS BLACK).
- 9. 12" DÍA. X 5' DEEP AUGERED HOLE BELOW PALM PIT.
- 10. BOTTOM OF PIT TO SUMP. 4" DIA. PERFORATED PVC SUMP STANDPIPE
- 11. CONNECT PVC STANDPIPE TO ADJACENT DRAINLINE SYSTEM. REFER TO CIVIL ENGINEERING DRAWINGS.
- 12. 4" PVC TEE.
- 13. 3/4" CRUSHED DRAIN ROCK AROUND STANDPIPE.
- 14. UNDISTURBED NATIVE SOIL. 15. SCARIFY SIDES OF PALM PIT.

#### **NOTES**

A. REFER TO PALM TREE SPECIFICATION FOR ADDITIONAL INFORMATION. B. AUGERED HOLE AND CONNECTION TO STORM DRAIN SYSTEM IS REQUIRED FOR PHOENIX DACTYLIFERA ("DATE PALM") AND ARCONTOPHOENIX ALEXANDRAE ("KING PALM"). REFER TO SHEET L5—101, PLANTING PLAN FOR LOCATIONS. WASHINGTONIA ROBUSTA ("MEXICAN FAN PALM") REQUIRES AUGERED HOLE ONLY.

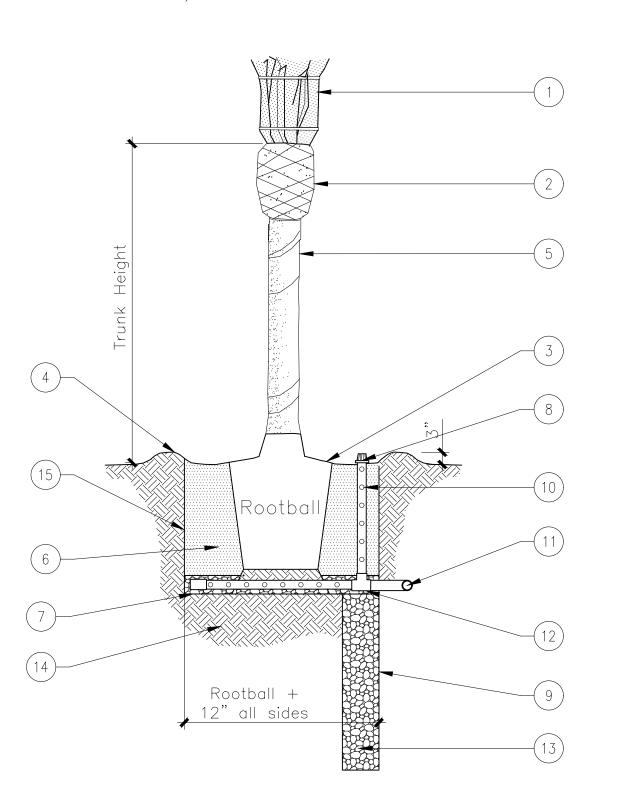


#### **LEGEND**

- 1. TREE CENTER IN PIT.
- 2. TREE TIES. 3. 2" DIAMETER X 10' LODGEPOLE PINE STAKE - KEEP
- CLEAR OF ROOTBALL. 4. 3" DEEP WATER BASIN.
- 5. FINISH GRADE.
- 6. PLANT TABLETS QUANTITY PER HORTICULTURAL SOILS REPORT AND MANUFACTURER'S RECOMMENDATIONS.
- 7. SITE SOIL.
- 8. ROOTBALL SET TOP 2" ABOVE FINISH GRADE. 9. AMENDED BACKFILL SOIL PER HORTICULTURAL SOILS
- REPORT AND RECOMMENDATIONS. 10. 3" HIGH UNAMENDED SITE SOIL PEDESTAL.

#### **NOTES**

- A. REFER TO PLANTING NOTES FOR ADDITIONAL
- INFORMATION. B. KEEP MULCH 3" CLEAR OF TRUNK.
- C. REFER TO PLANTING SPECIFICATION FOR ADDITIONAL
- INFORMATION.

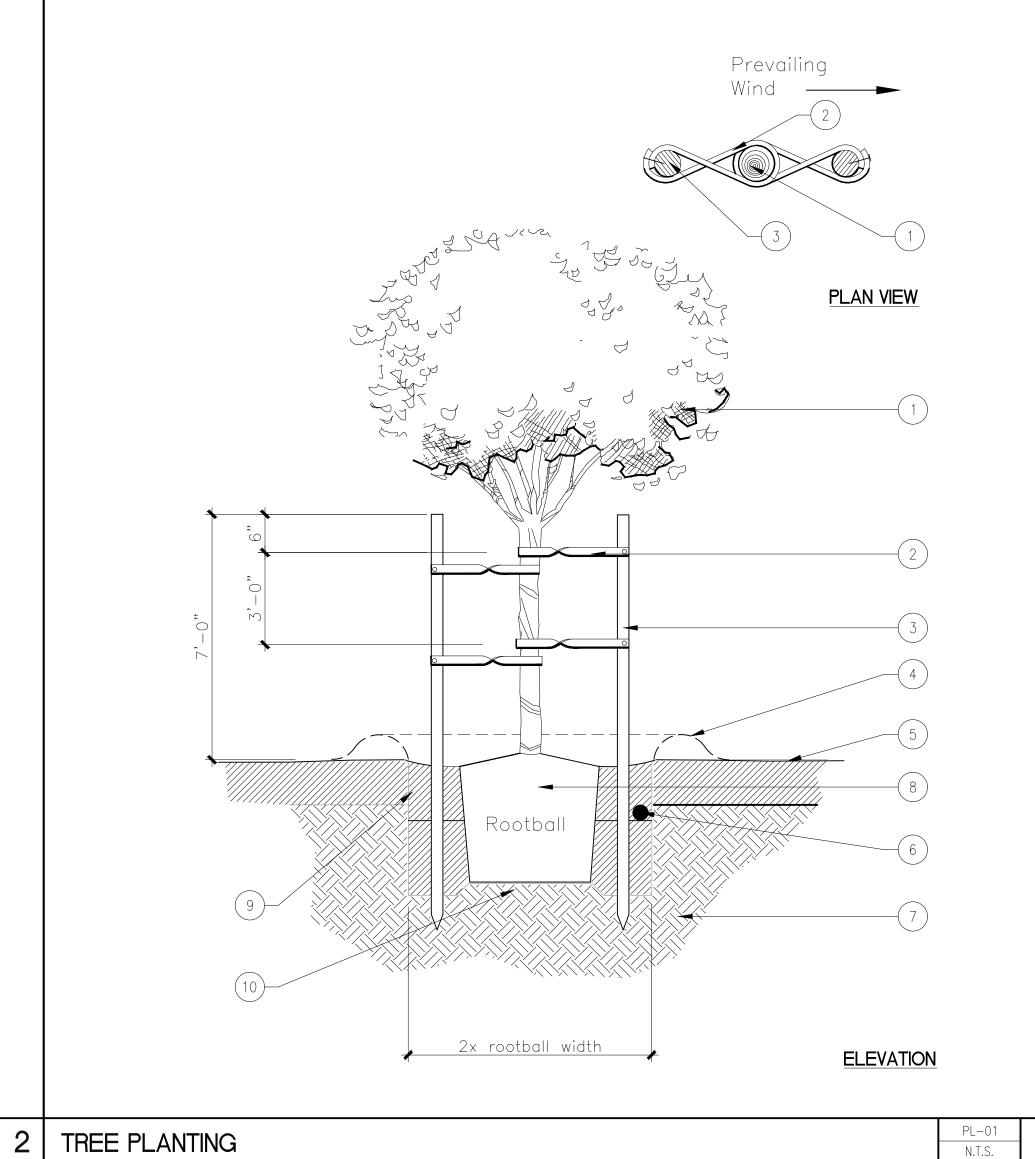


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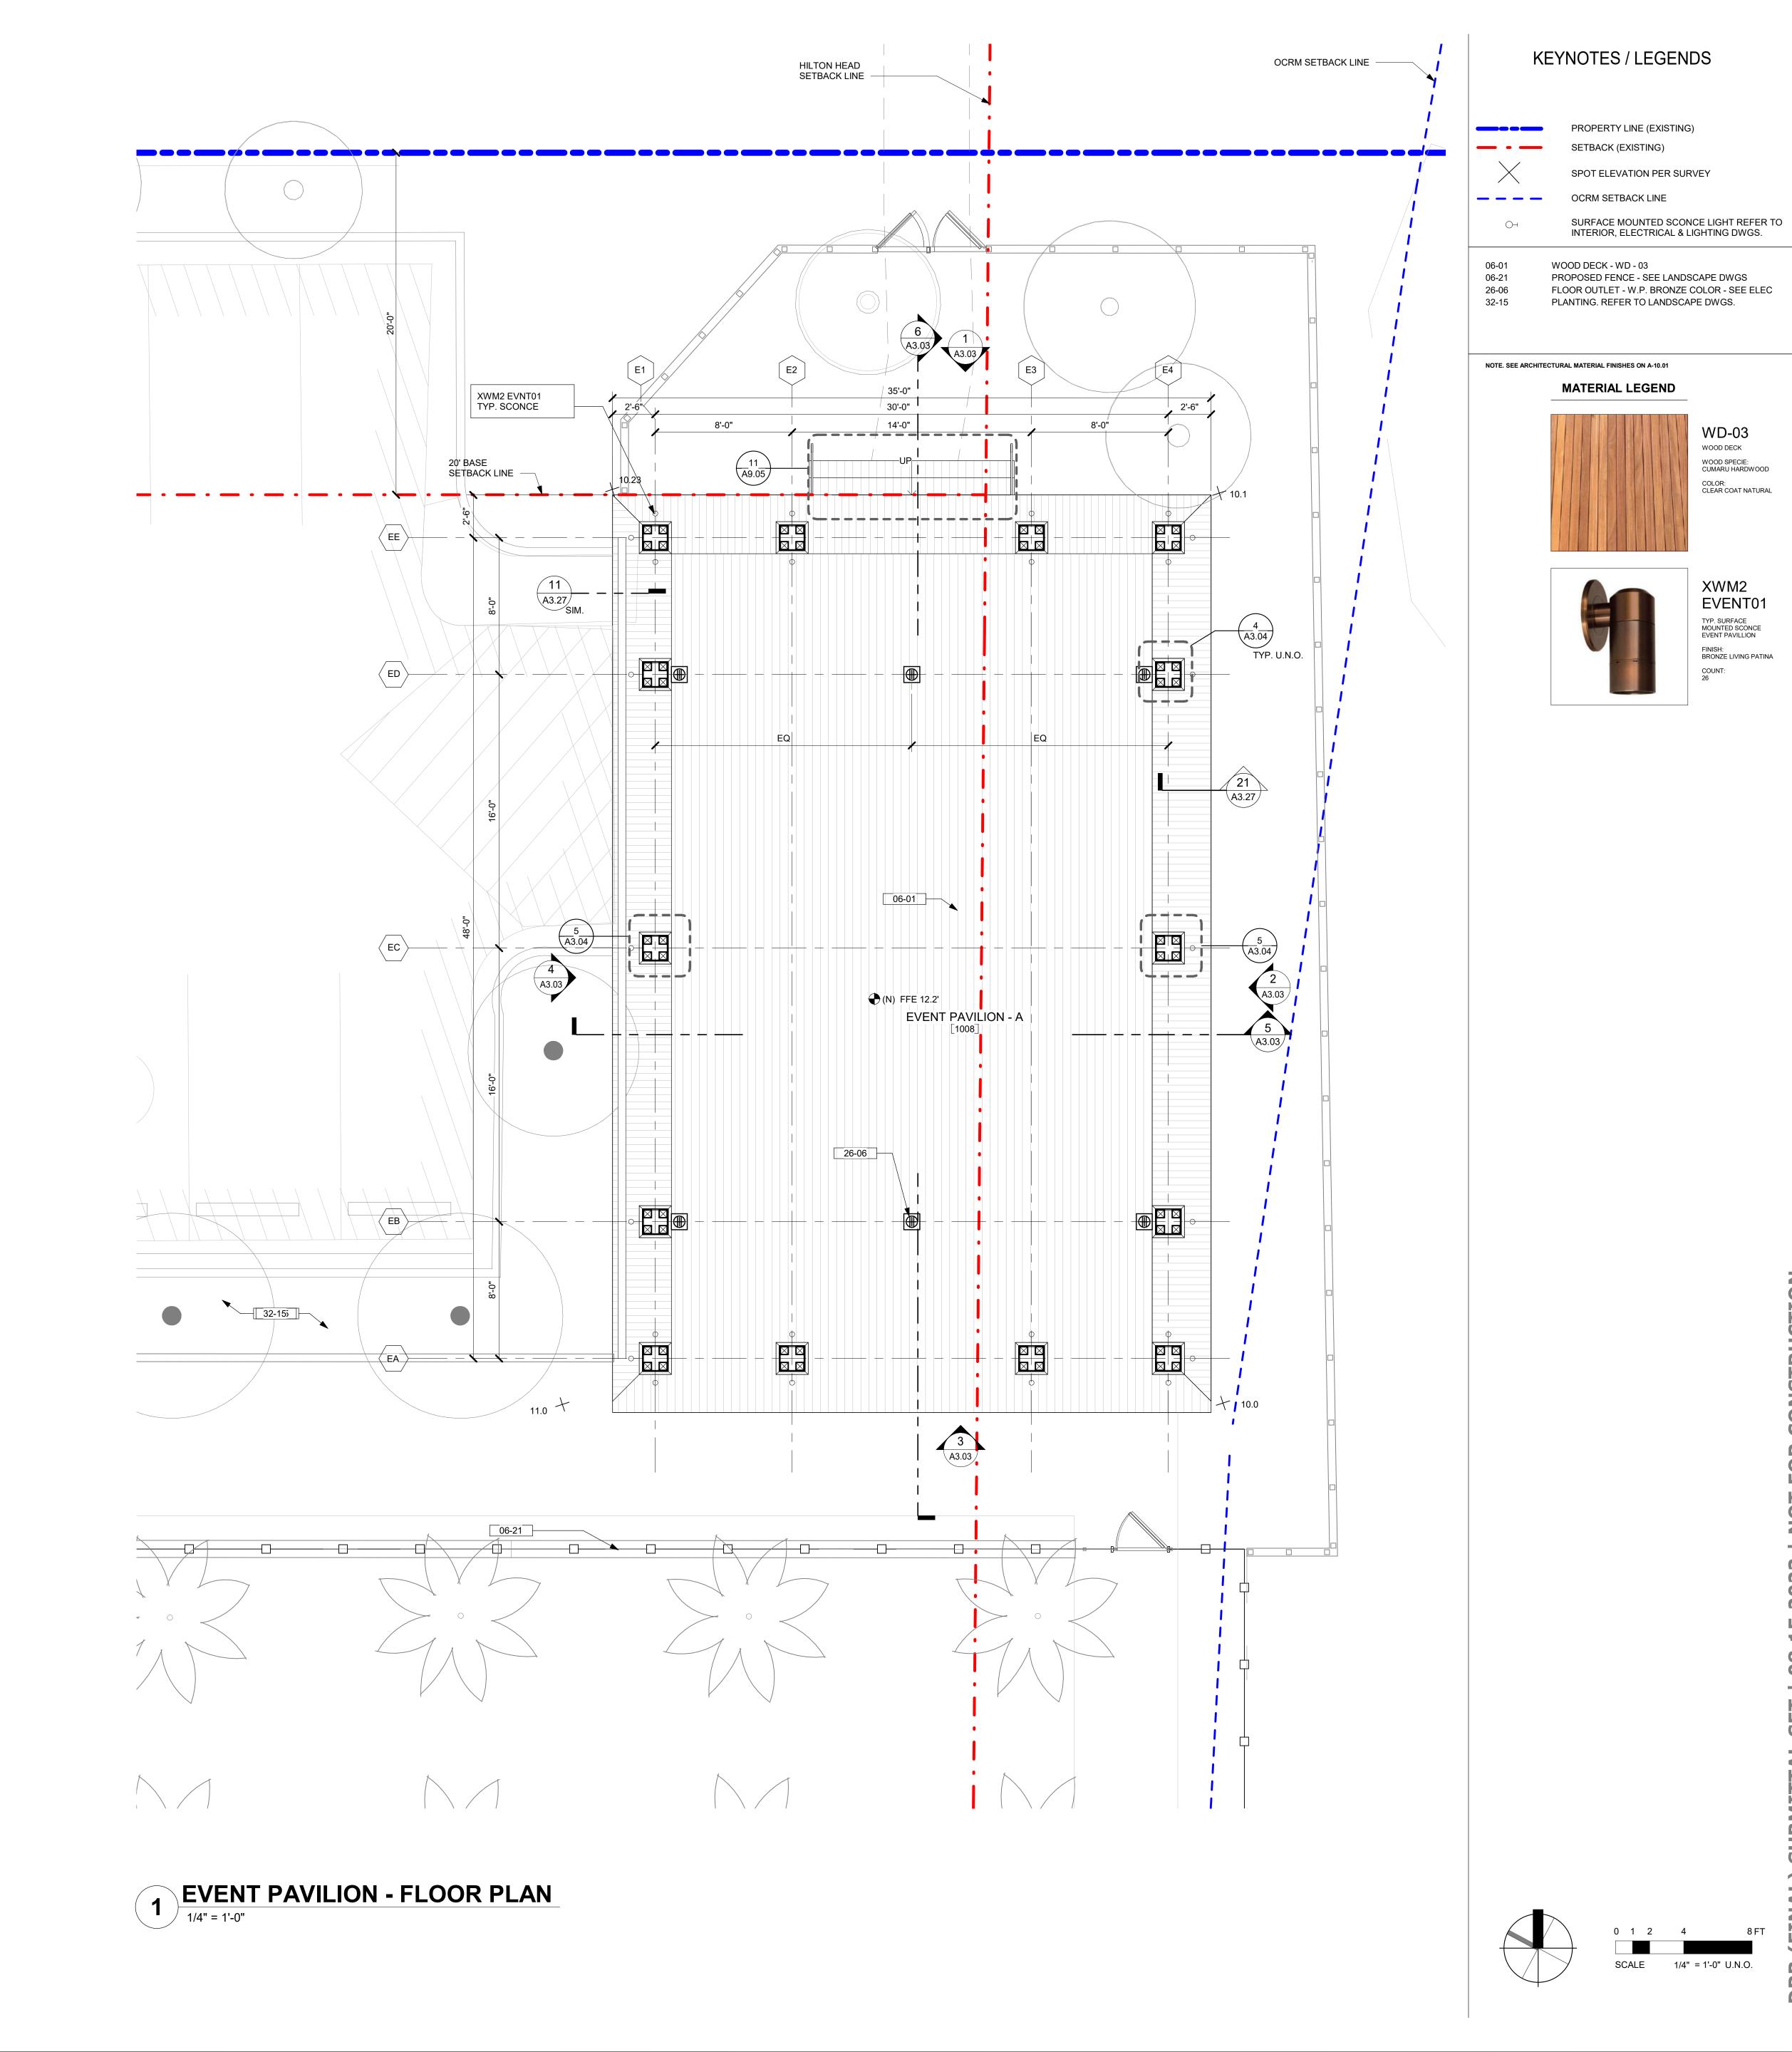
consultant

stamp | approval



HILTON HEAD ISLAND 1 SOUTH FOREST BEACH DRIVE HILTON HEAD, SC 29928

PLANTING DETAILS

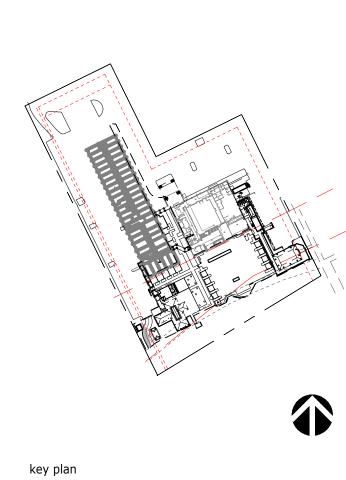

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**EOS** INVESTORS

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WD-03

WOOD DECK

WOOD SPECIE: CUMARU HARDWOOD

COLOR: CLEAR COAT NATURAL

EVENT01

TYP. SURFACE MOUNTED SCONCE EVENT PAVILLION


FINISH: BRONZE LIVING PATINA


stamp | approval

key plan

**EVENT PAVILION - FLOOR** 

drawn by: IZ/NP/HM

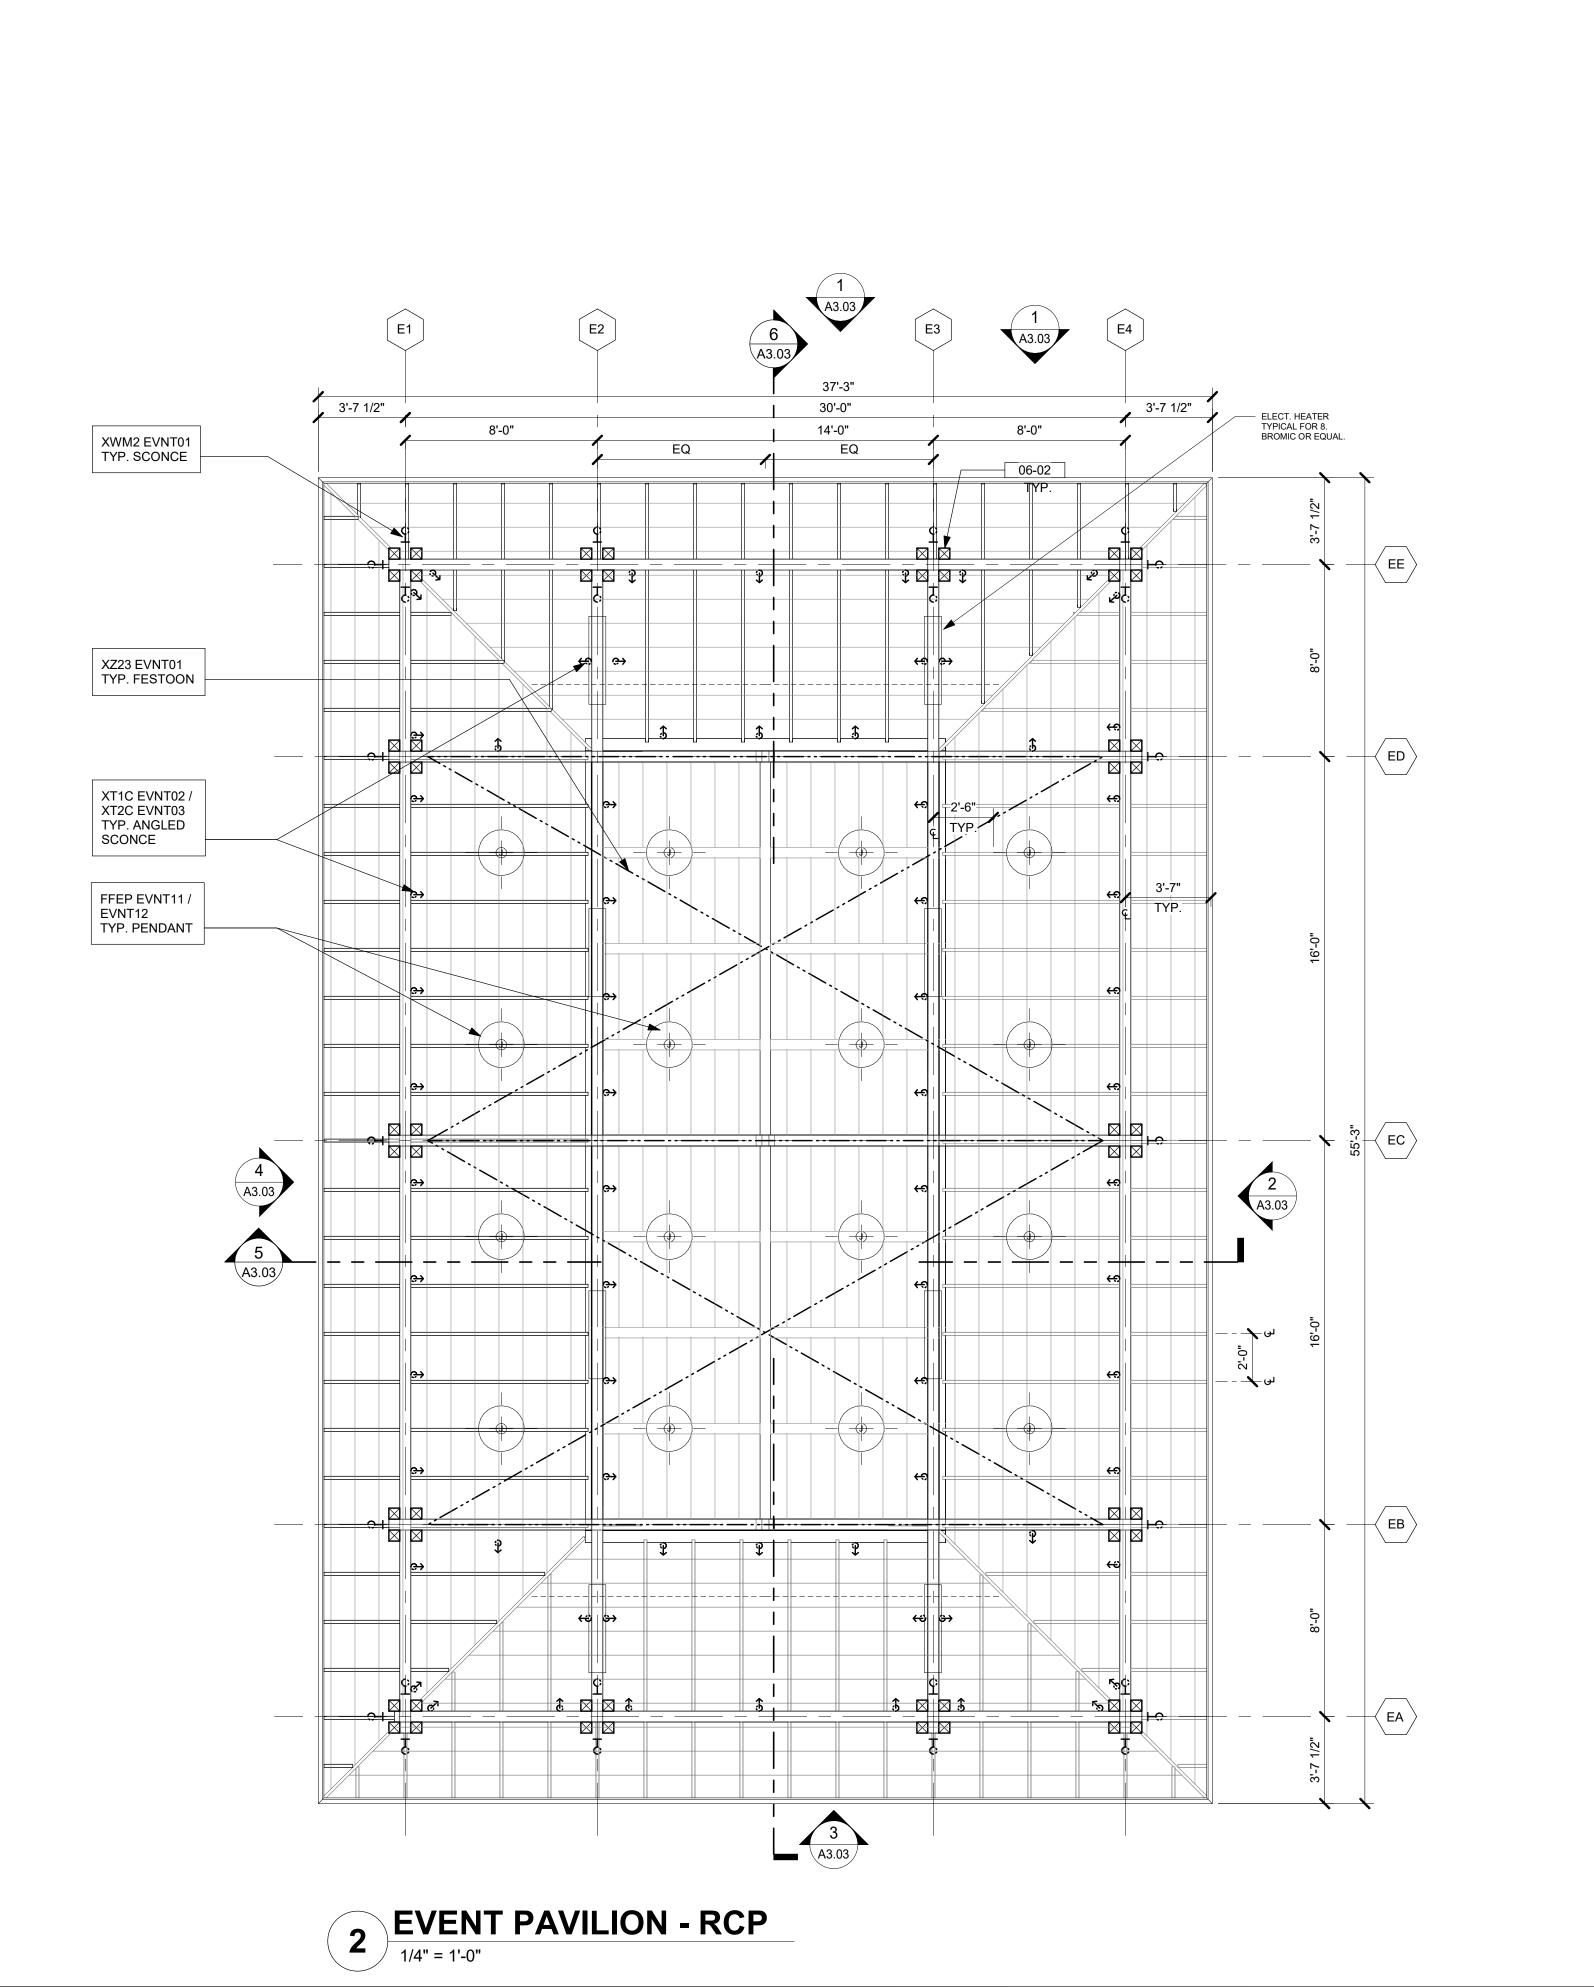

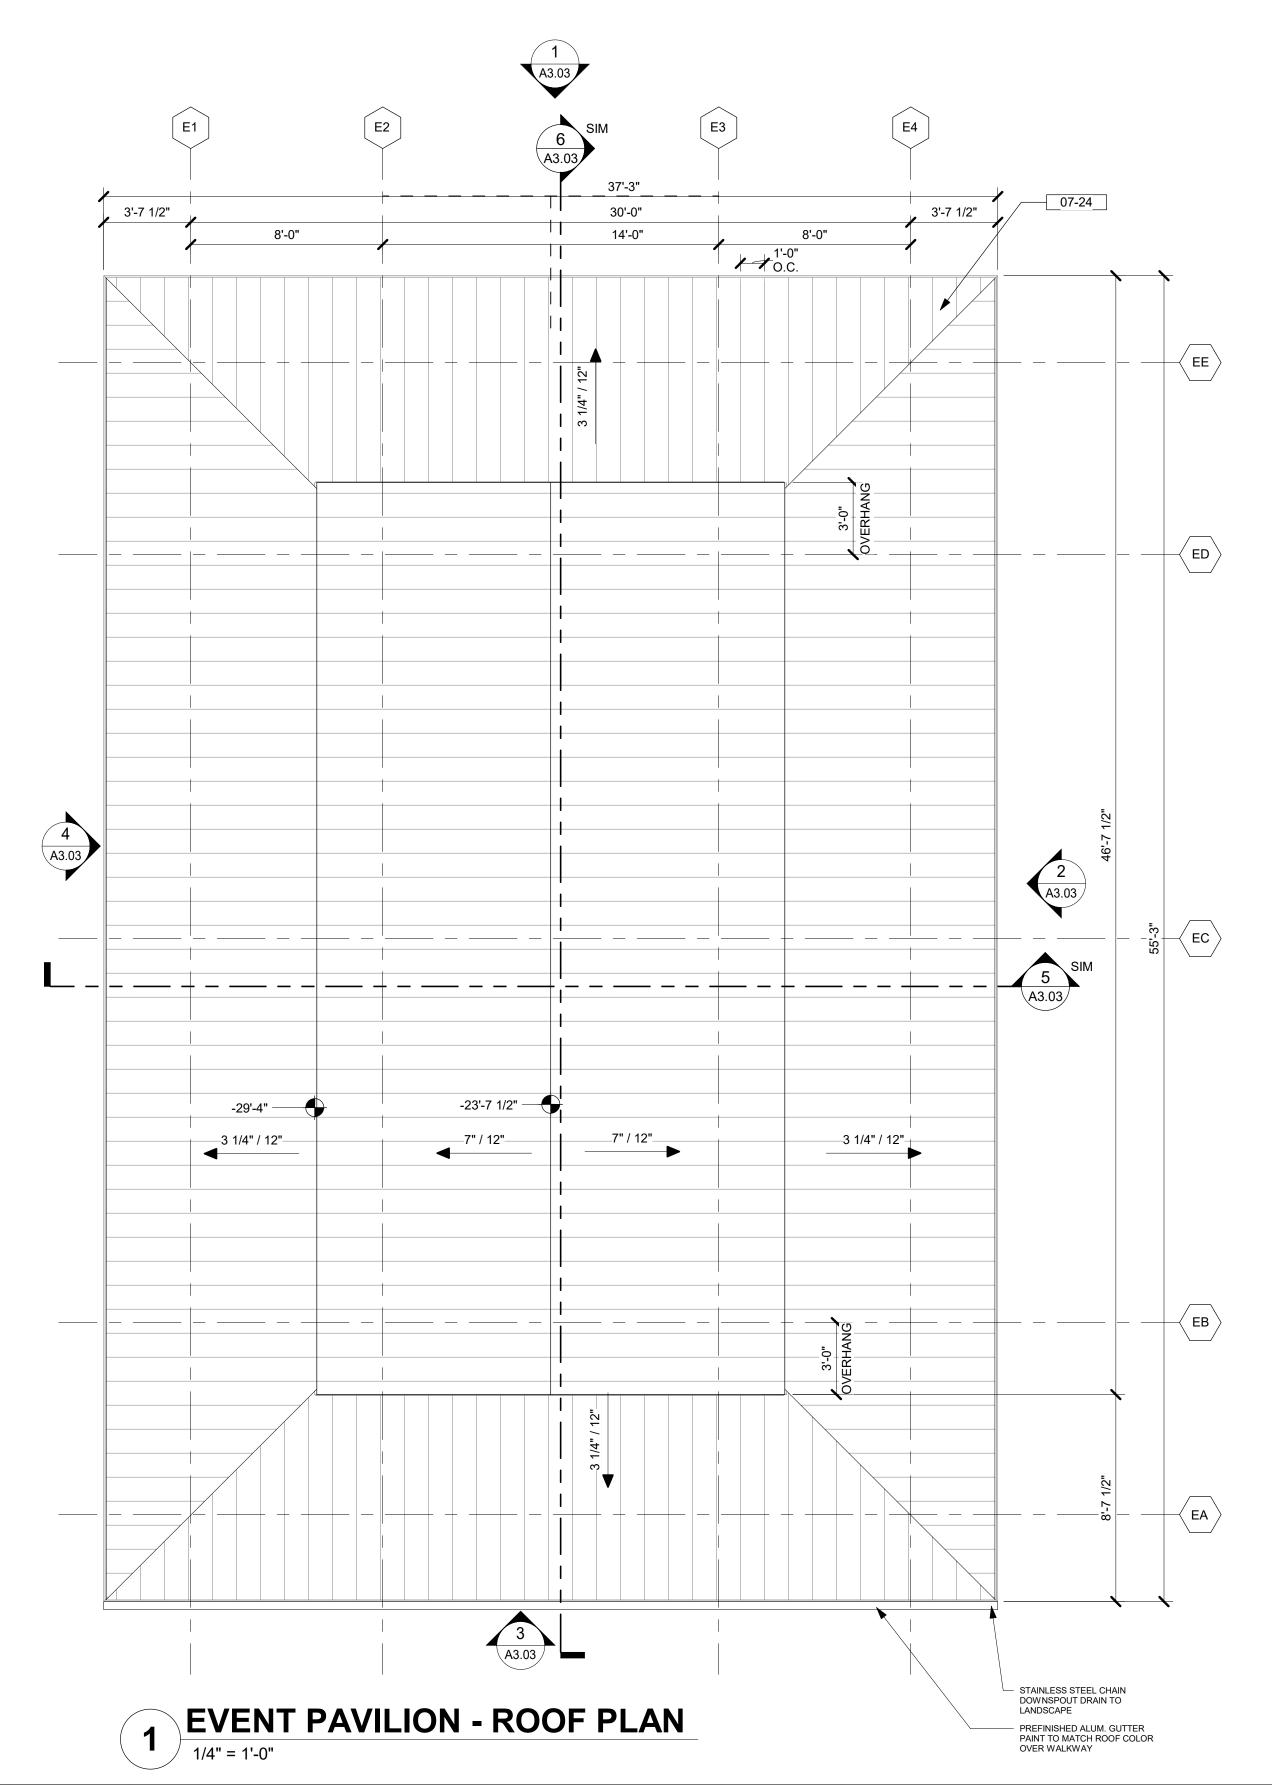

KEYNOTES / LEGENDS

SURFACE MOUNTED SCONCE LIGHT REFER TO INTERIOR, ELECTRICAL & LIGHTING DWGS.

PENDANT / CEILING MOUNTED REFER TO INTERIOR, ELECTRICAL, & LIGHTING DESIGN

STRING LIGHT PER LIGHTING CONSULTANT.

SURFACE MOUNTED UPLIGHT REFER TO INTERIOR, ELECTRICAL & LIGHTING DWGS.


SURFACE MOUNTED LIGHT REFER TO INTERIOR, ELECTRICAL & LIGHTING DWGS. — — GRID LINES

SLOPE ARROW

WOOD COLUMN - SEE STRUCT. DWGS - WD - 01

#### **MATERIAL LEGEND**

NOTE. SEE ARCHITECTURAL MATERIAL FINISHES ON A-10.01

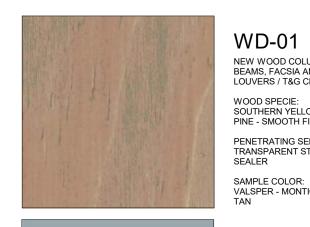


NEW WOOD COLUMN / BEAMS, FACSIA AND LOUVERS / T&G CEILING WOOD SPECIE: SOUTHERN YELLOW PINE - SMOOTH FINISH PENETRATING SEMI-TRANSPARENT STAIN & SEALER SAMPLE COLOR: VALSPER - MONTICELLO TAN

RF-02 STANDING SEAM METAL ROOFING MANUFACTURER: PAC-CLAD COLOR: CITY SCAPE

XWM2 EVNT01

TYP. SURFACE MOUNTED SCONCE EVENT PAVILLION

FINISH: BRONZE LIVING PATINA

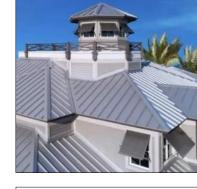











FFEP EVNT11/ EVNT12 TYP. CUSTOM MADE PENDANT FINISH: MATTE BRONZE FINISH AND BRASS METAL POWDER COATED INSIDE

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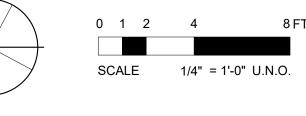
key plan


**EVENT PAVILION -**ENLARGED RCP AND ROOF

drawn by: IZ/NP/HM


A3.02

sheet no.




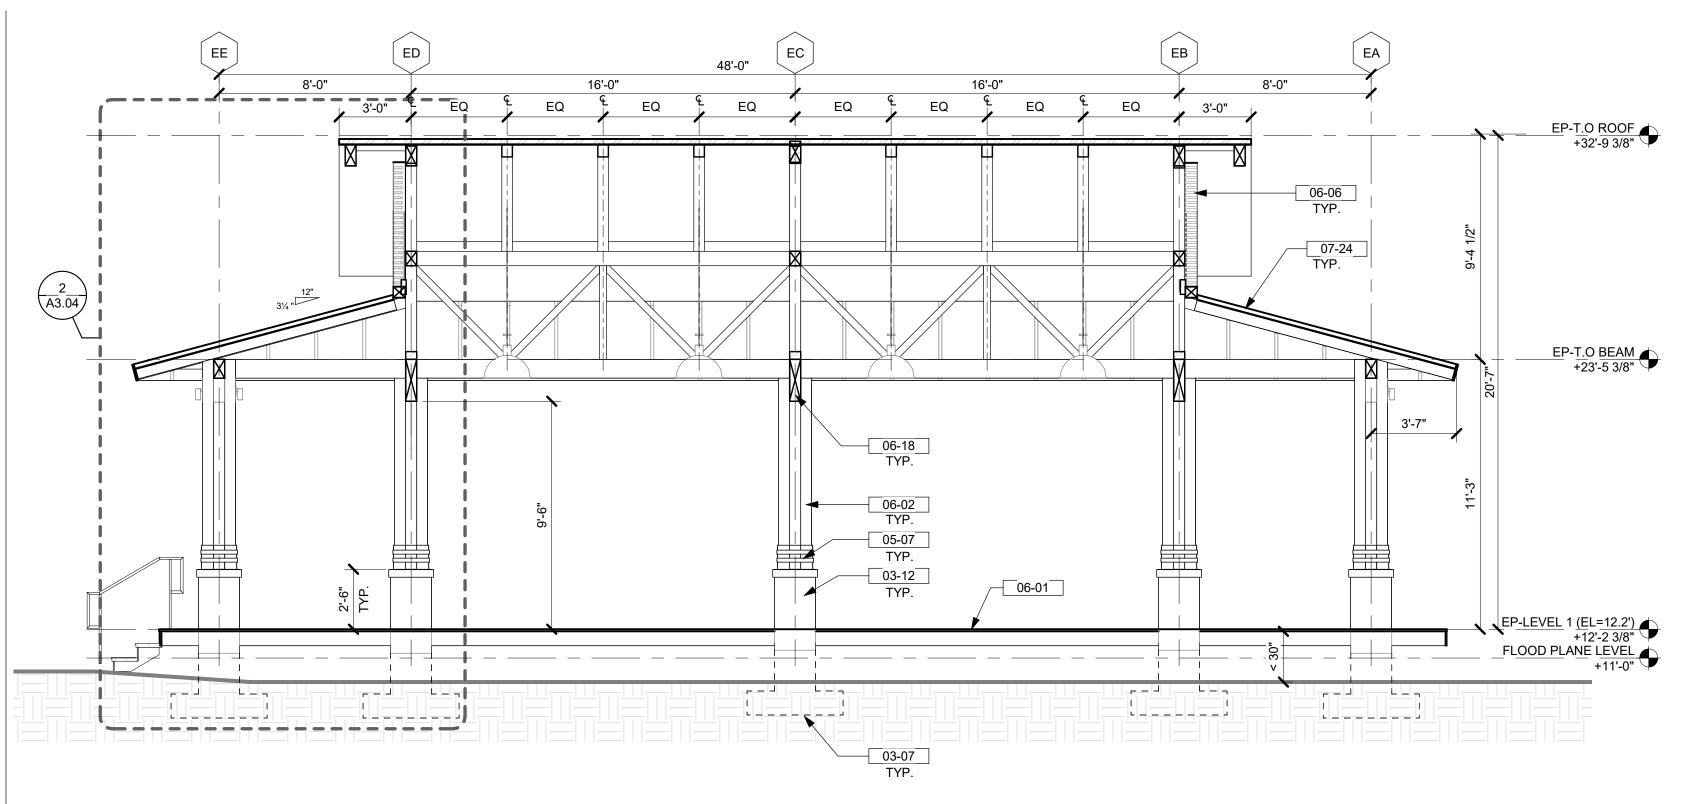

## 6 EVENT PAVILION - SECTION B 1/4" = 1'-0"

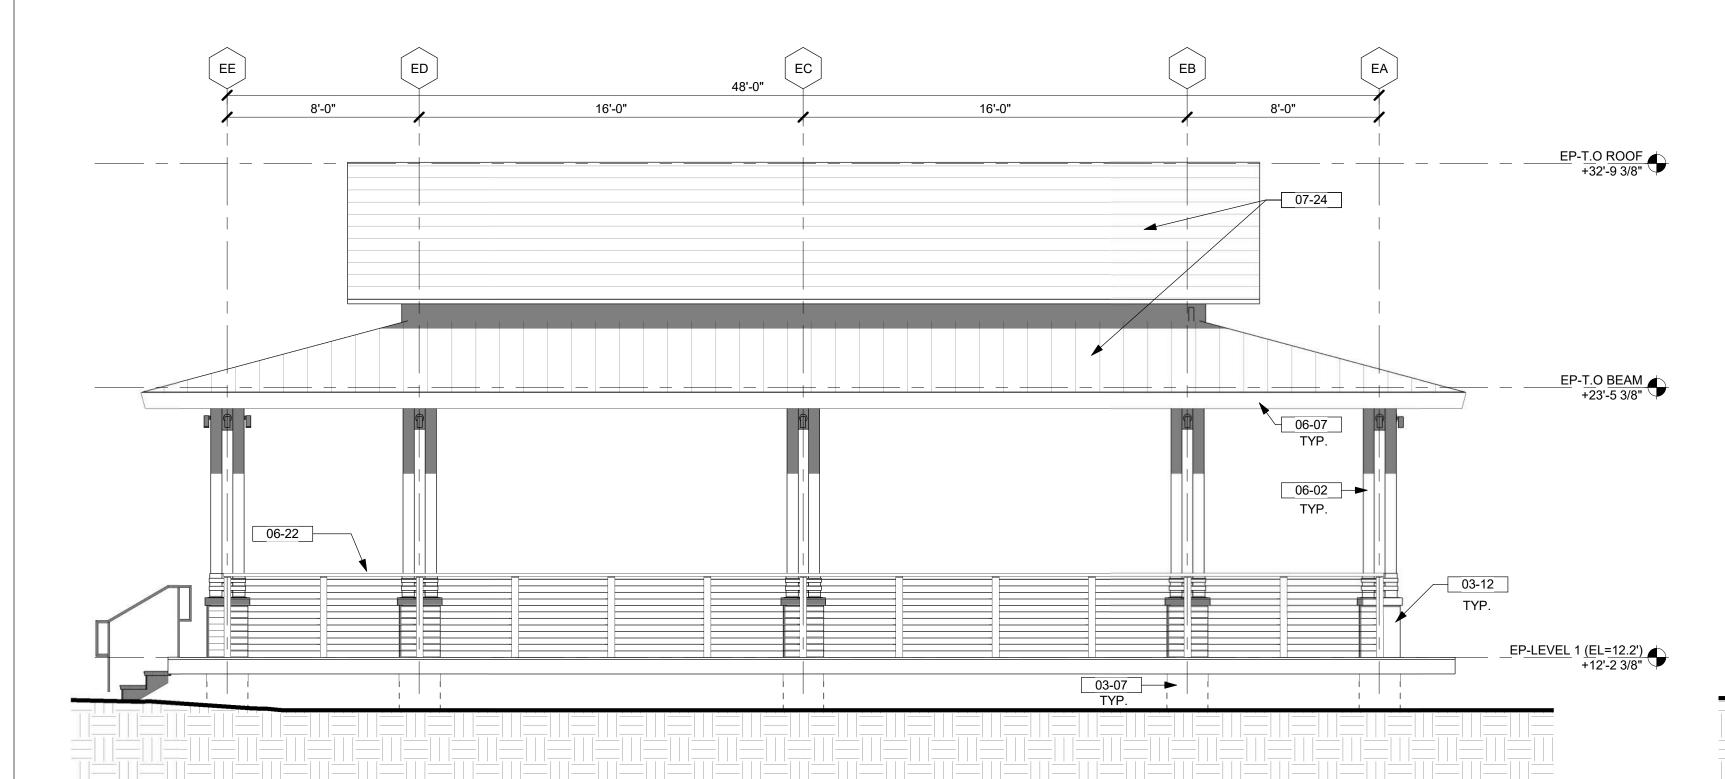


## 4 EVENT PAVILION - REAR ELEVATION 1/4" = 1'-0"

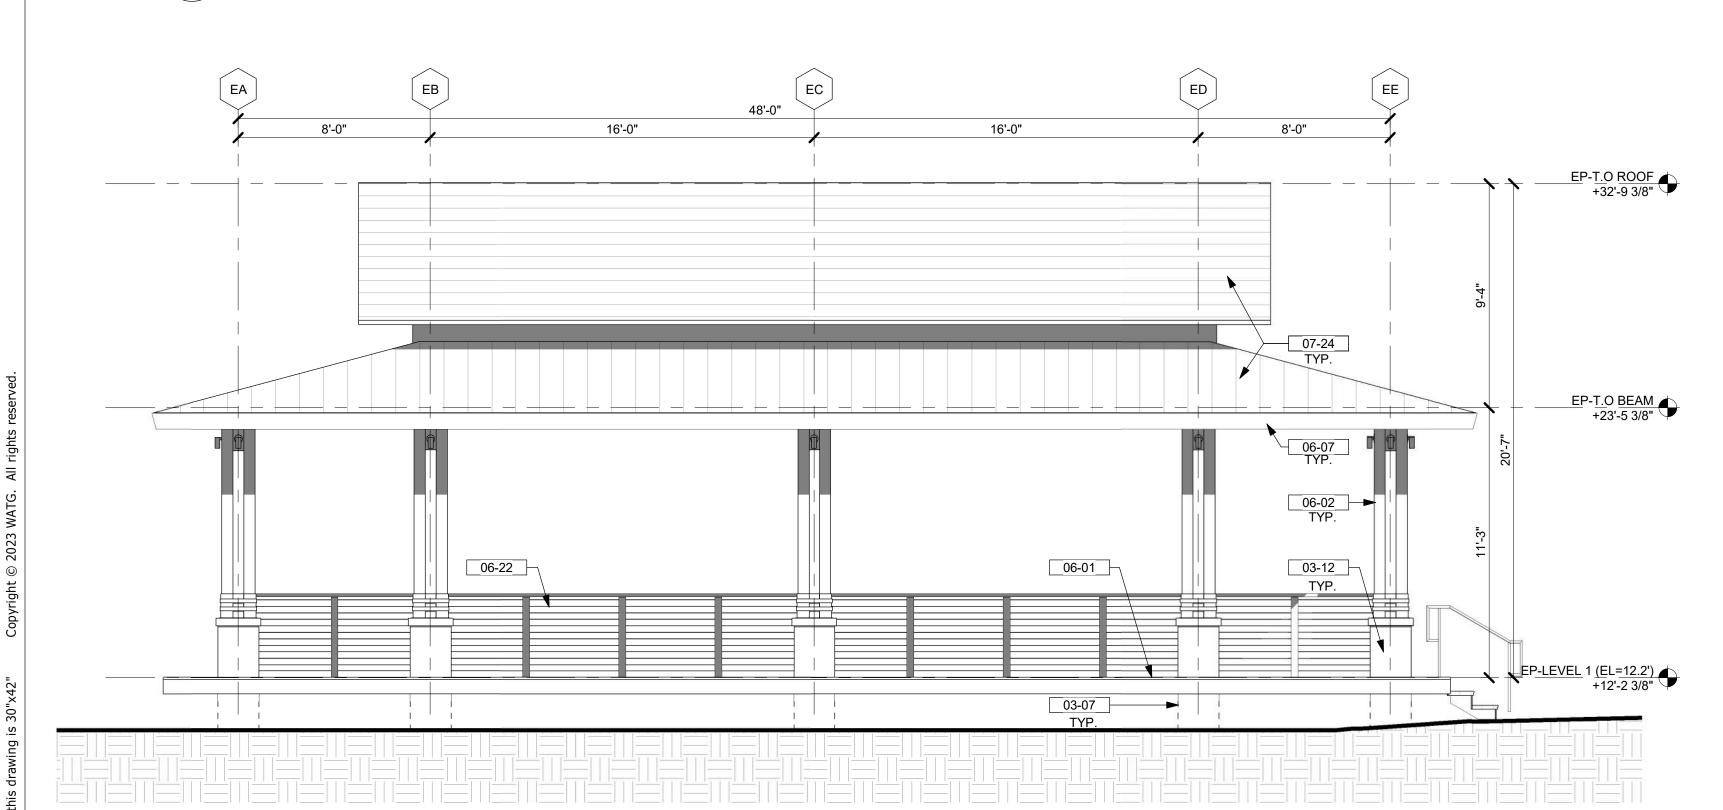


2 EVENT PAVILION - FRONT ELEVATION

1/4" = 1'-0"

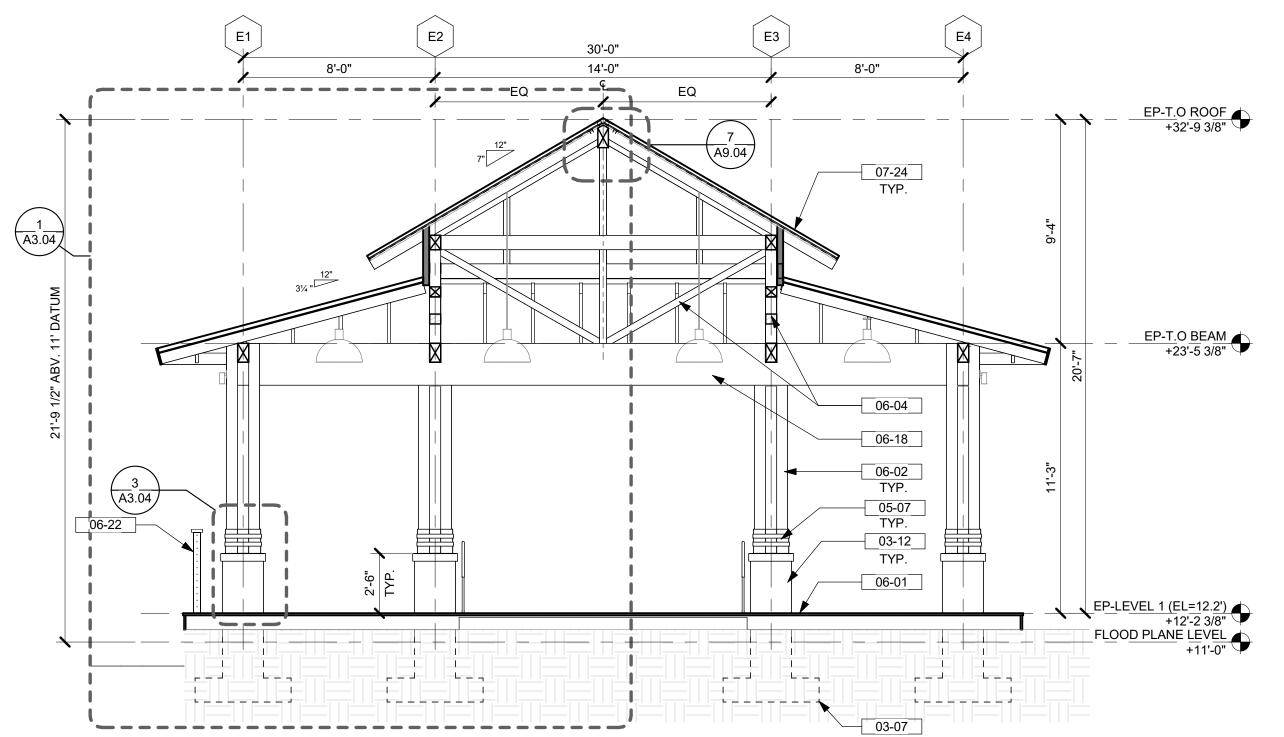


## 5 EVENT PAVILION - SECTION A 1/4" = 1'-0"

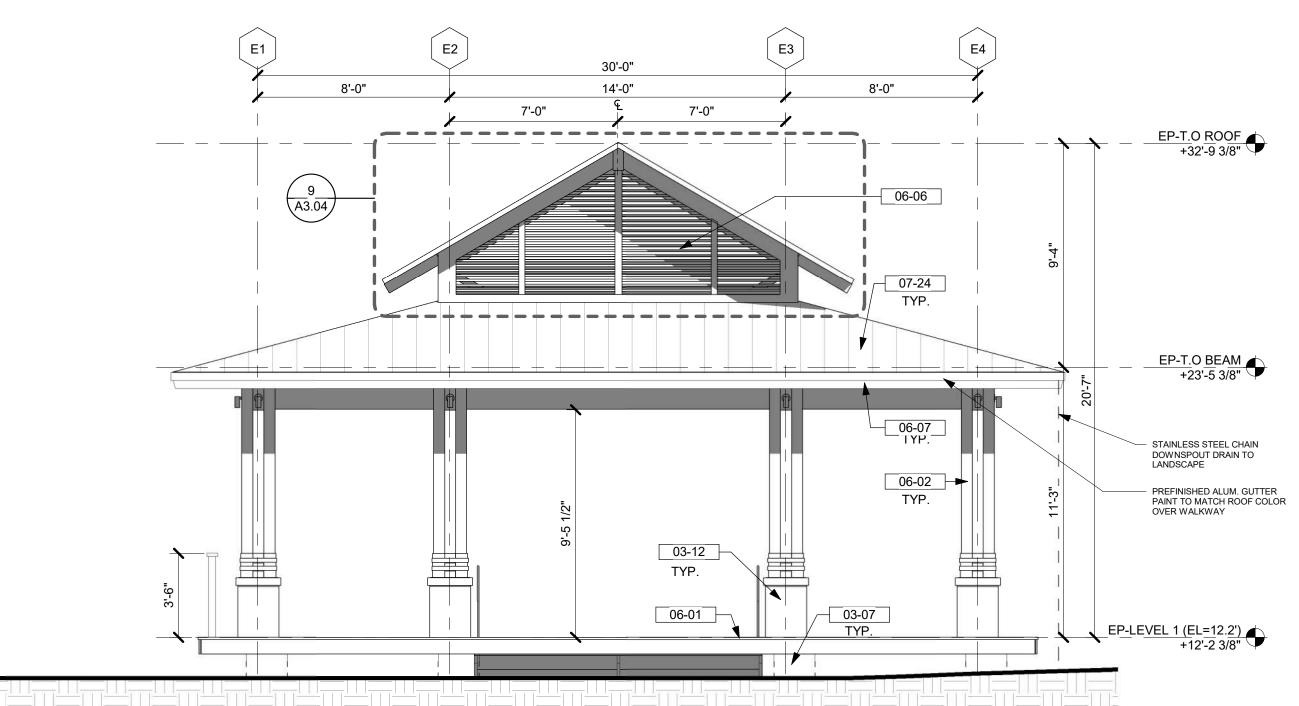

3 EVENT PAVILION - SIDE 1 ELEVATION

1/4" = 1'-0"

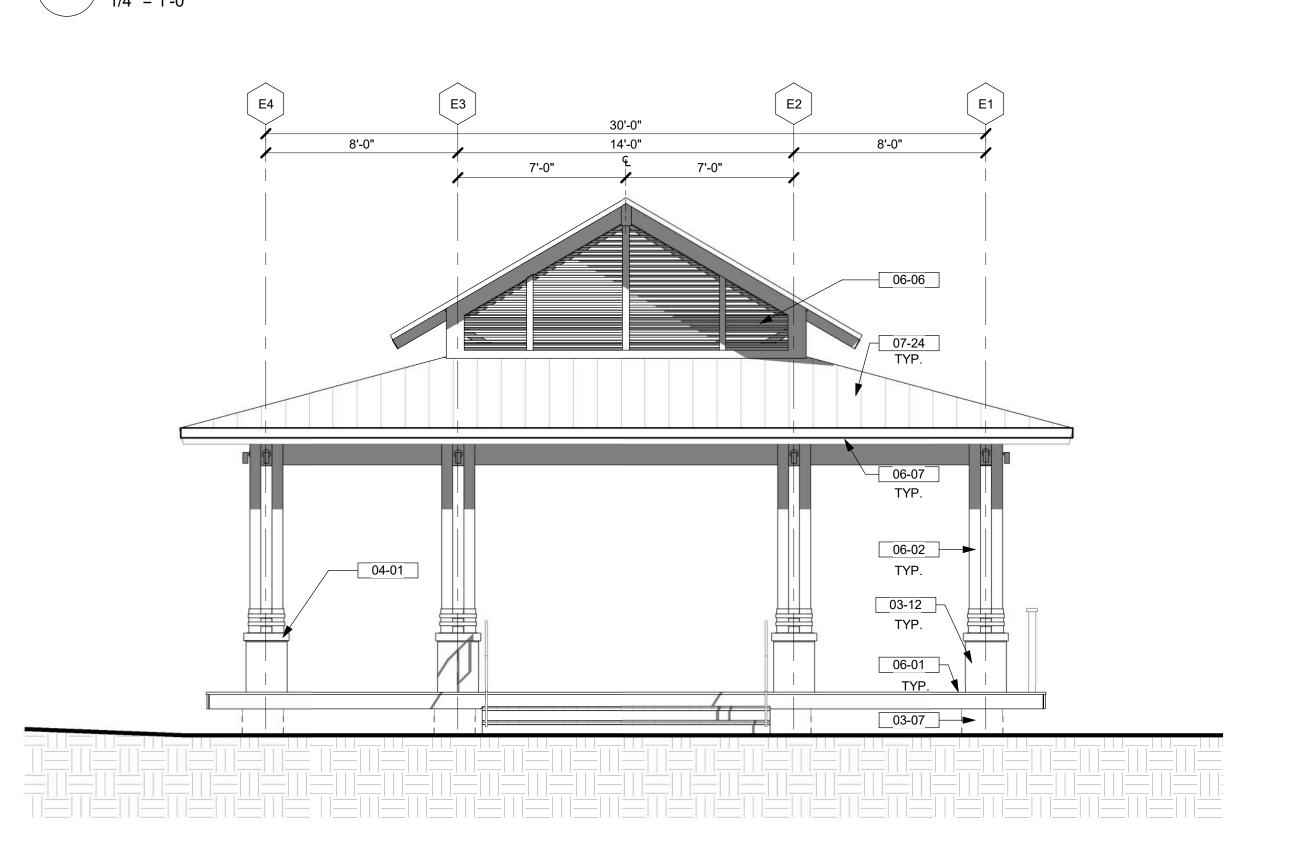

EVENT PAVILION - SIDE 2 ELEVATION

1/4" = 1'-0"

#### KEYNOTES / LEGENDS

TABBY PLASTER FINISH PILASTER - STU - 01 NATURAL LIMESTONE CAP TO MATCH TABBY STEEL CONNECTIONS TO WOOD MEMBERS - SEE WOOD DECK - WD - 03

WOOD COLUMN - SEE STRUCT. DWGS - WD - 01 WOOD BEAM - SEE STRUCT. DWGS - WD - 01 WOOD ROOF TRUST - SEE STRUCT. DWGS - WD - 01 WOOD FASCIA - WD - 01 GLUED LAMINATED WOOD BEAM - SEE STRUCT

HANDRAIL AND GUARDRAIL - WD - 02 METAL STANDING SEAM ROOF - RF - 02

NOTE: SEE ARCHITECTURAL MATERIAL FINISHES ON A-10.01

NOTE: 11'-0" DATUM IS BASED ON SURVEY 11.0' ELEVATION ABOVE SEA LEVEL USING MEAN SEA LEVEL NAVD88


#### MATERIAL LEGEND



STU-01 TABBY SHELL STUCCO LIGHT. TAN EARTH TONE



WOOD SPECIE: SOUTHERN YELLOW PINE - SMOOTH FINISH PENETRATING SEMI-TRANSPARENT STAIN & SEALER SAMPLE COLOR: VALSPER - MONTICELLO

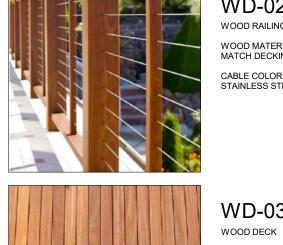


WOOD RAILING WOOD MATERIAL/COLOR: MATCH DECKING WD-03





COLOR: CLEAR COAT NATURAL



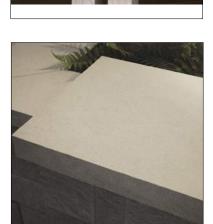

SPECIE: NATURAL LIMESTONE COLOR: NATURAL HONED FINISH TO MATCH TABBY PLASTER

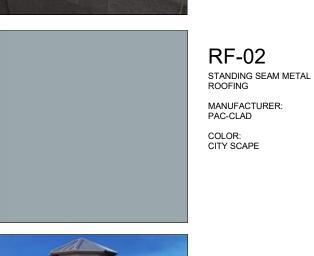

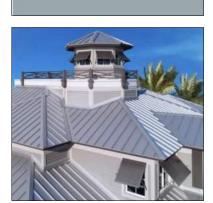

**EVENT PAVILION -**

**ELEVATION/SECTION** 

sheet no.

A3.03

SCALE 1/4" = 1'-0" U.N.O.

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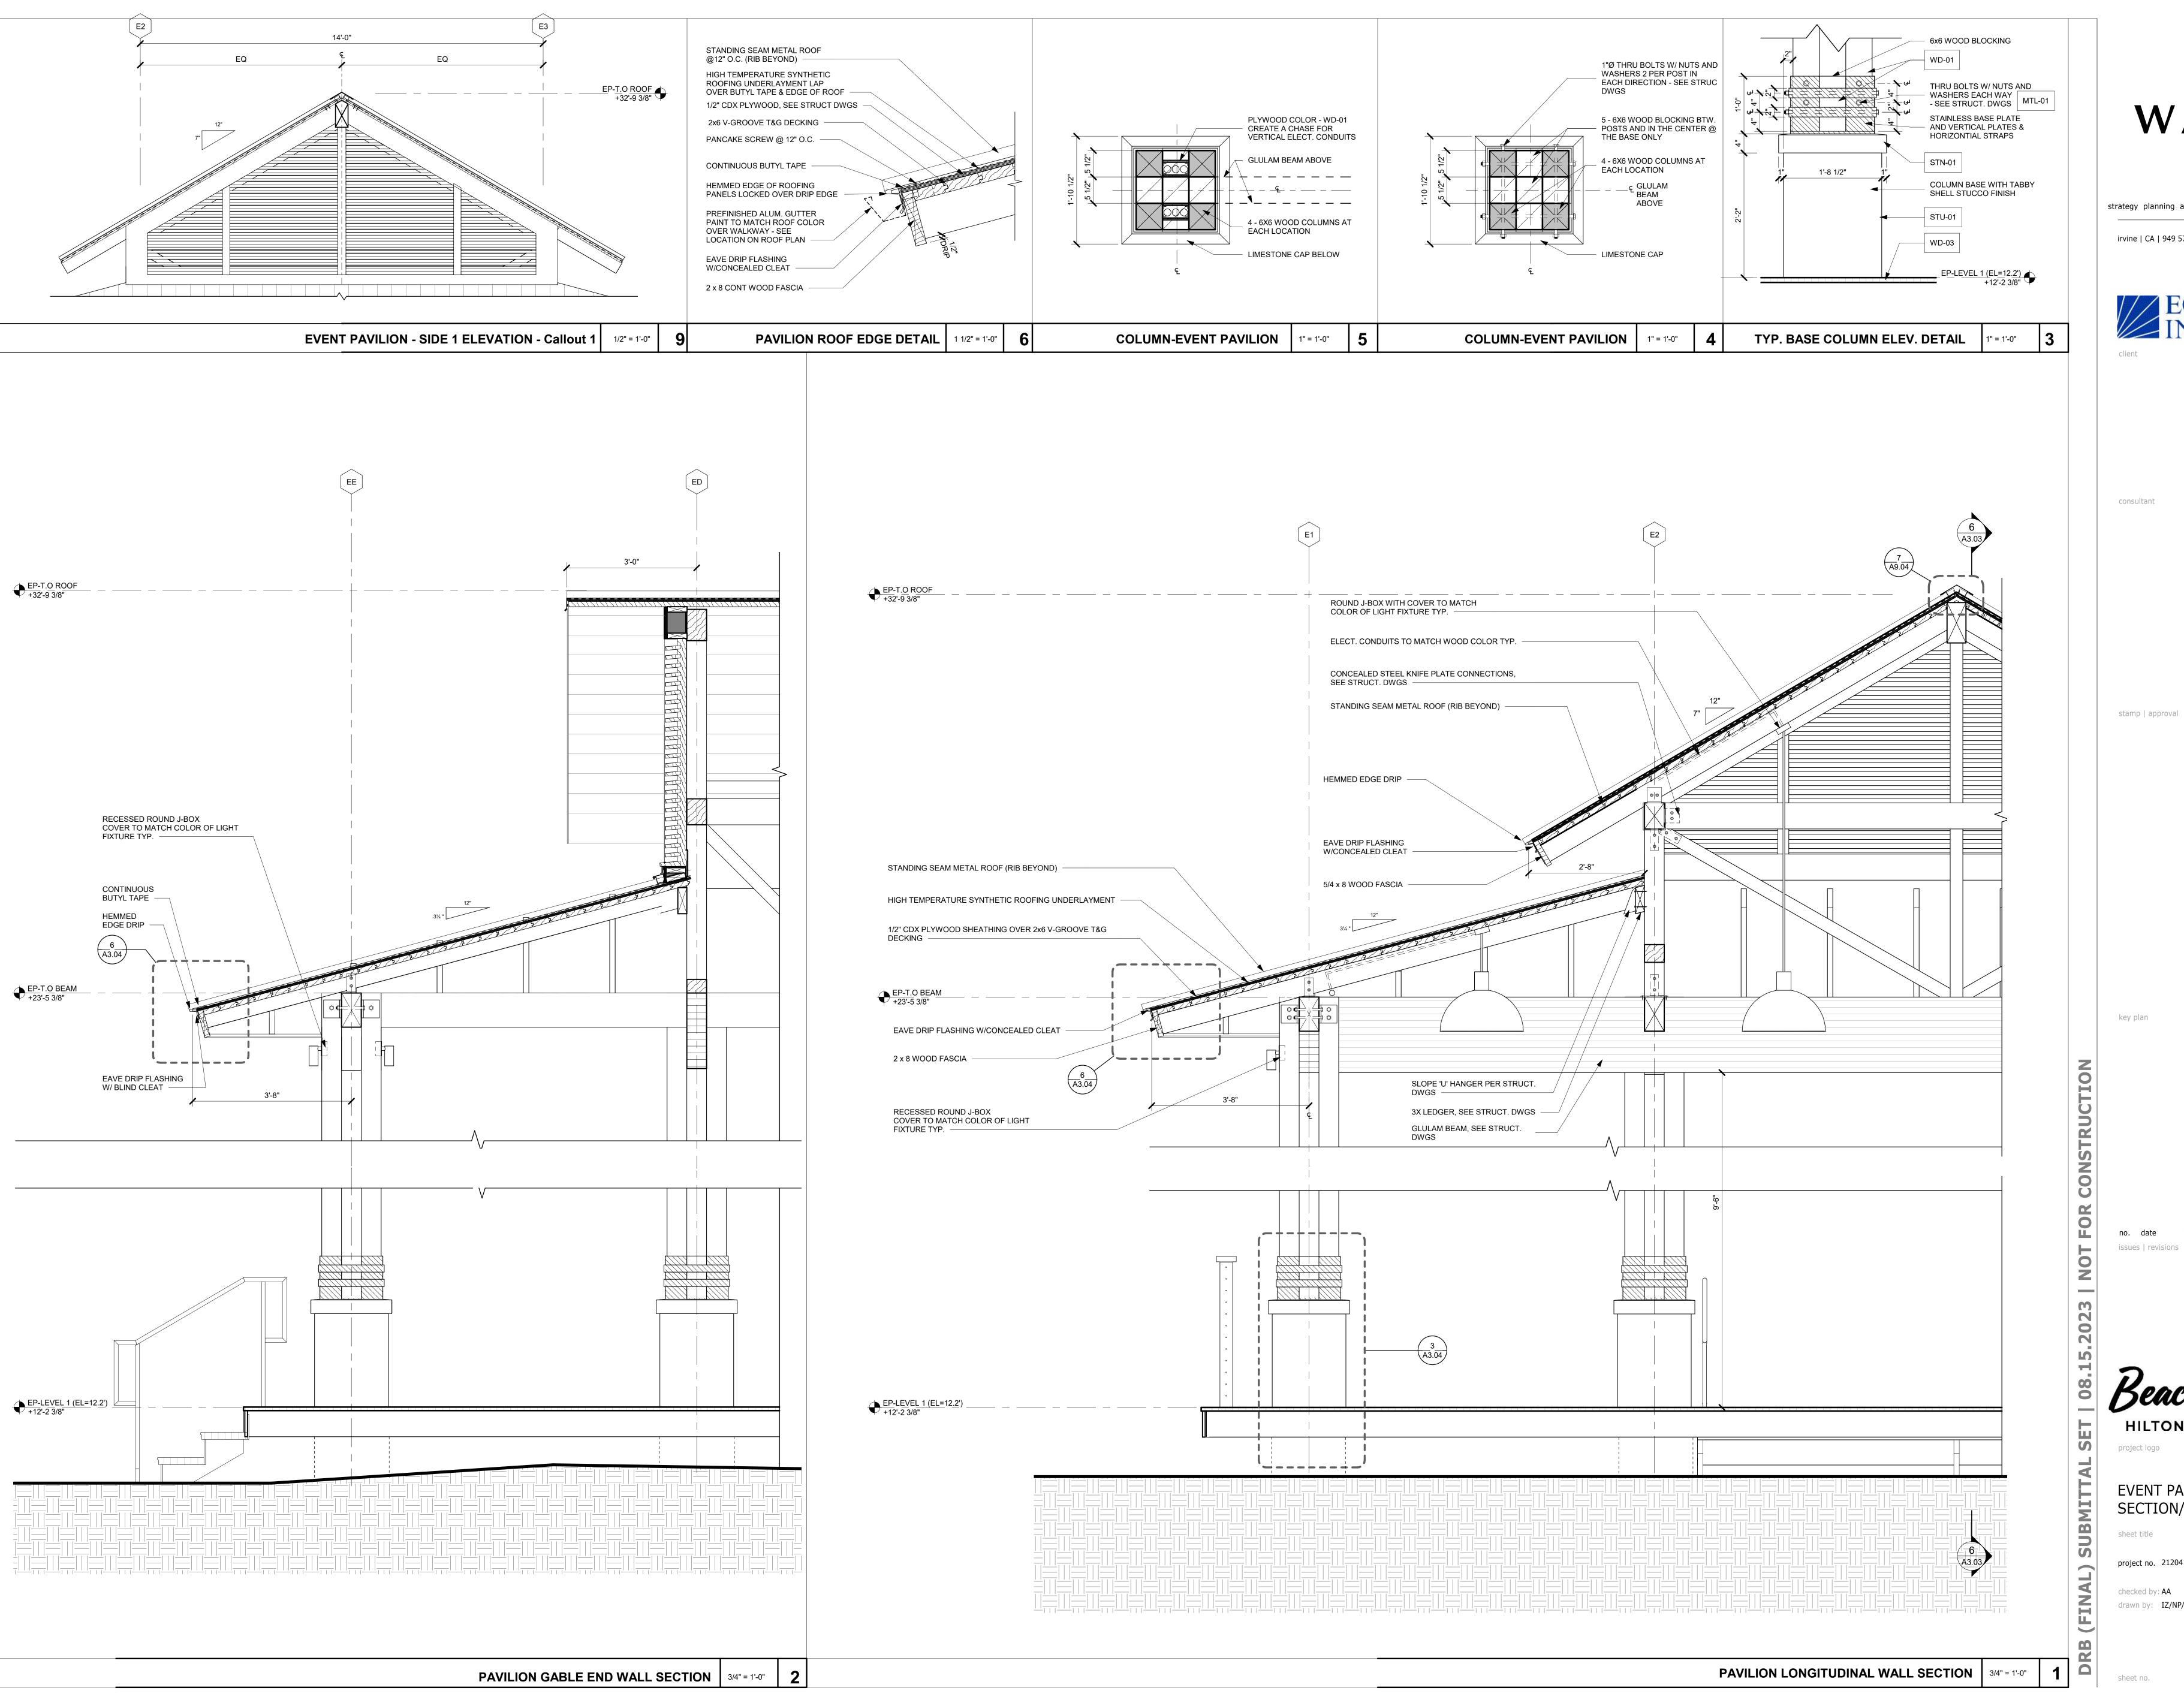
consultant

stamp | approval



key plan

0 1 2 4



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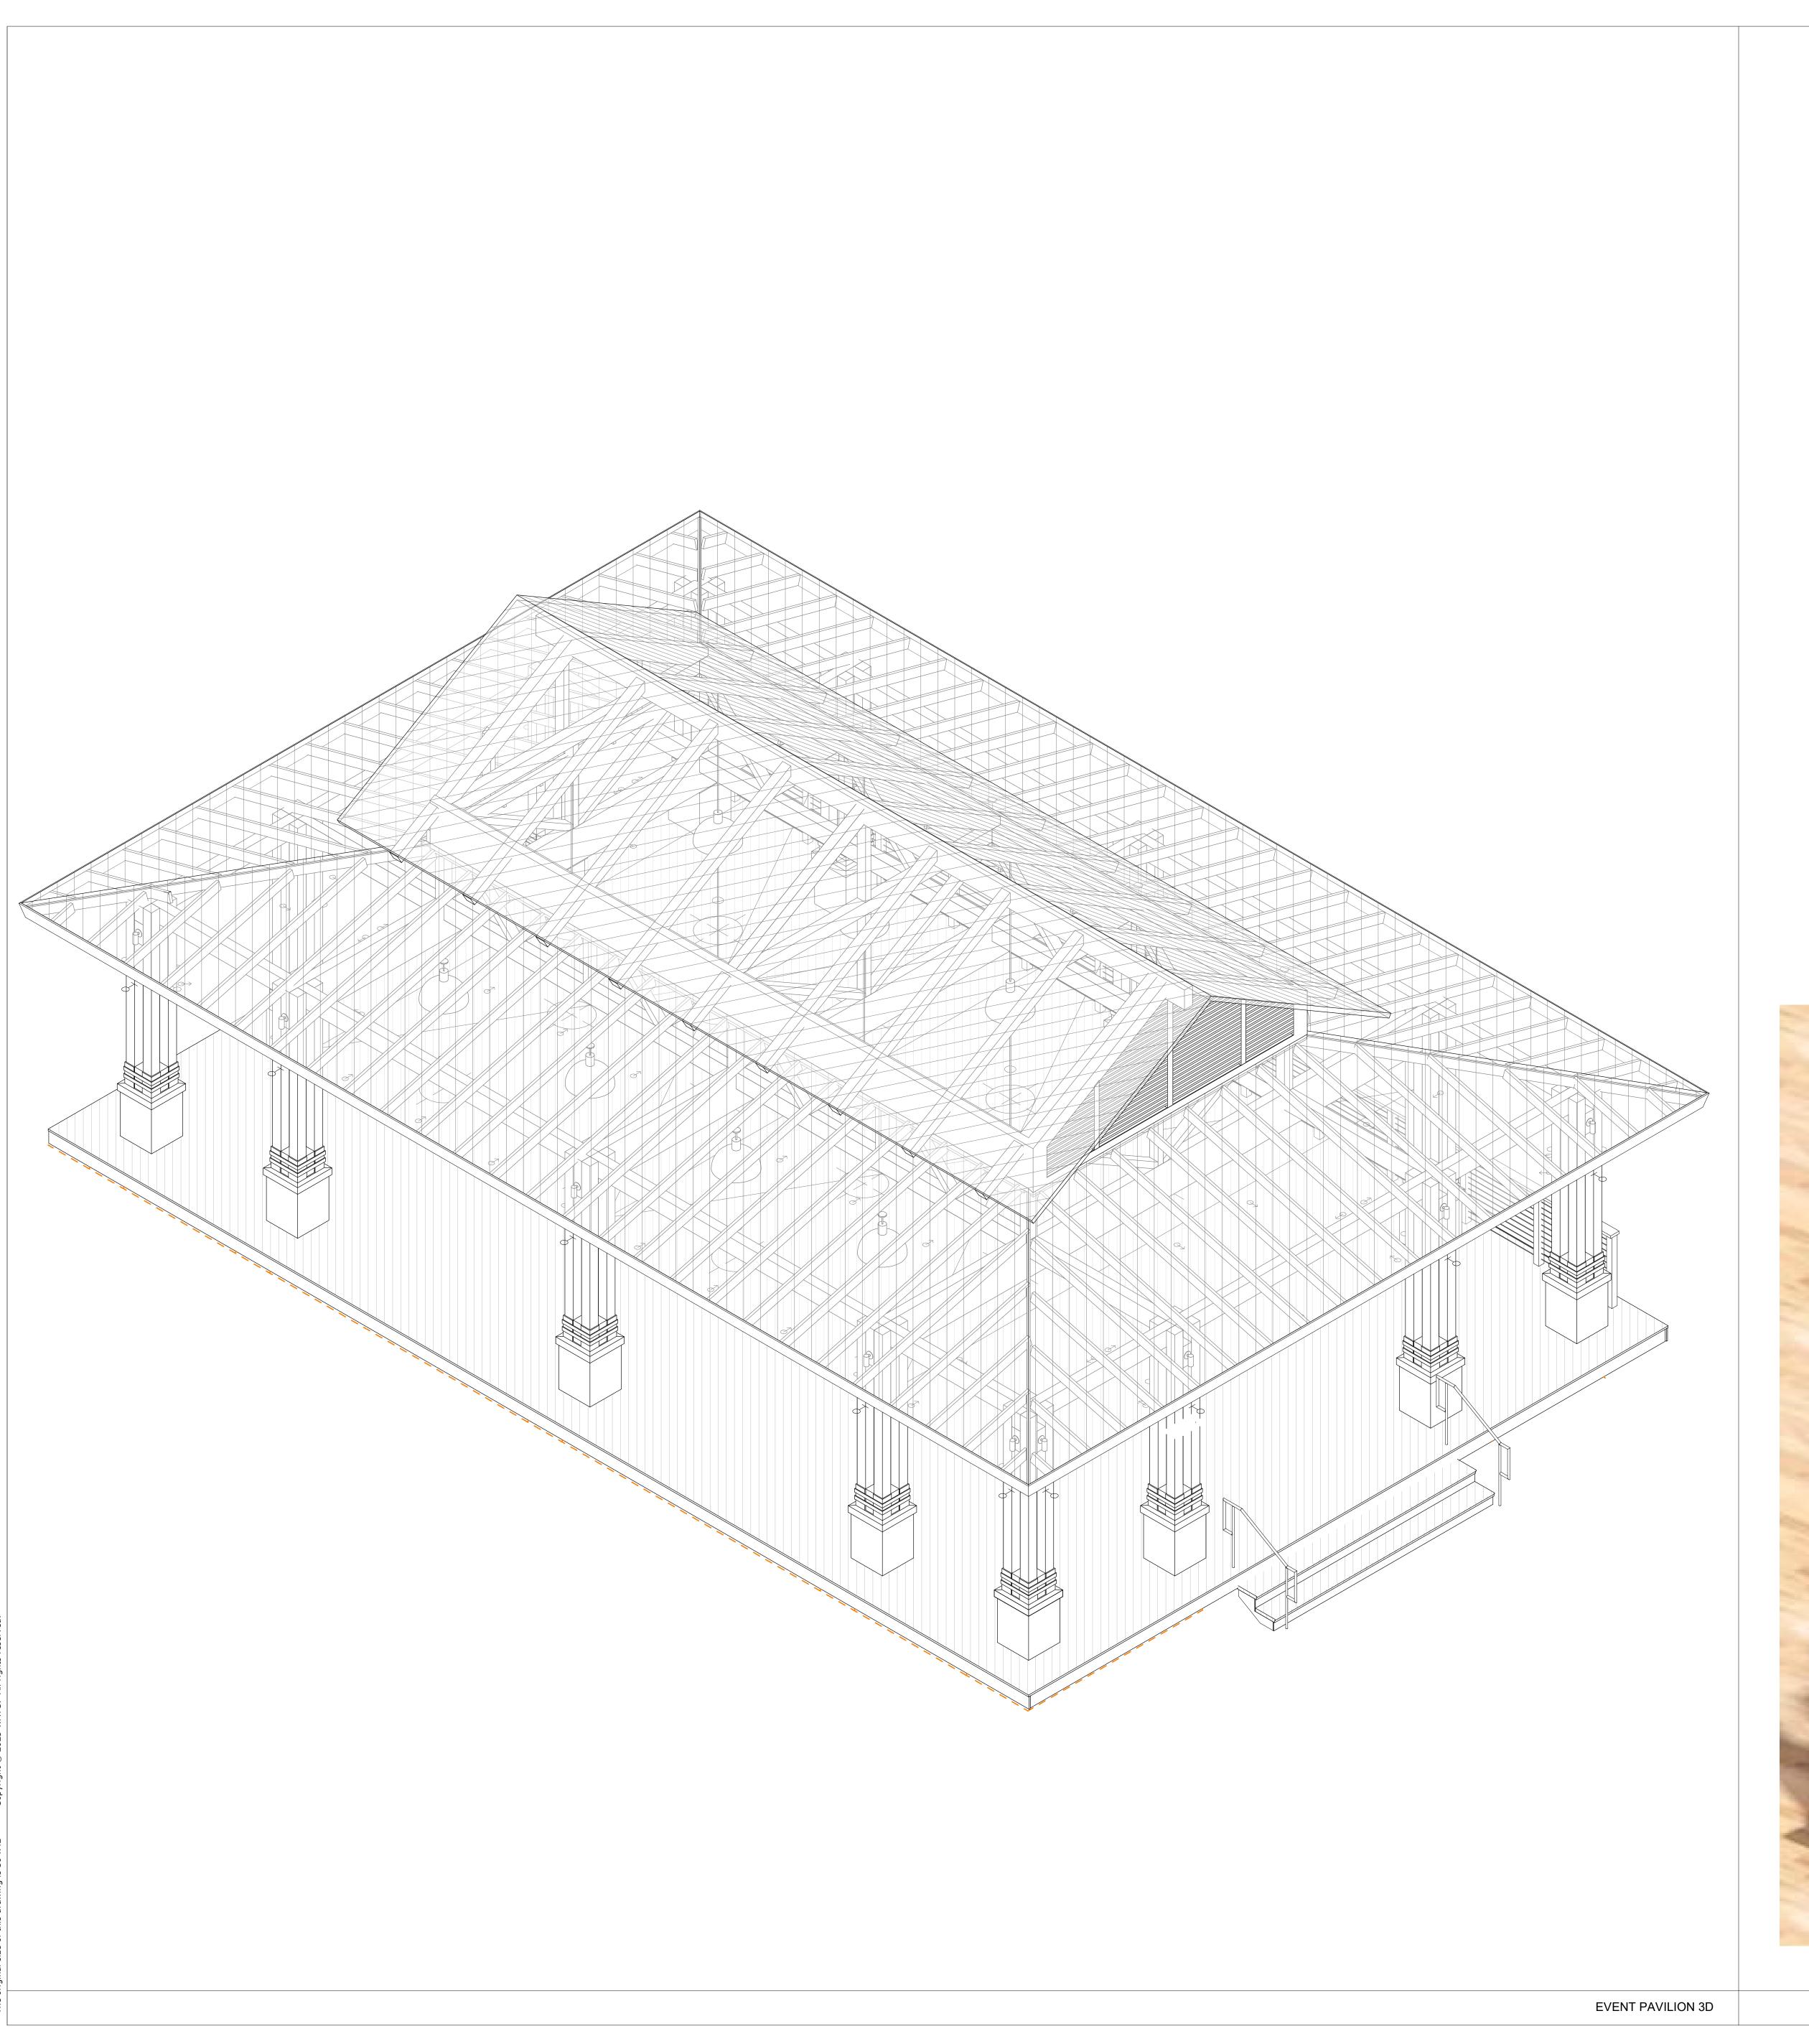
stamp | approval

key plan

**EVENT PAVILION -**SECTION/DETAILS

drawn by: IZ/NP/HM

A3.04





PREFERRED DESIGN

ALTERNATE STUDY (NOT PREFERRED)

COLUMN BASE STUDY OPTION

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key plan

no. date issue

Beach House
HILTON HEAD ISLAND
project logo

EVENT PAVILION - 3D VIEWS


VIEWS

sheet title


project no. 212041 date 08
checked by: AA
drawn by: IZ/NP/HM

n by: IZ/NP/HM compo

## 9 STAGE - SECTION B

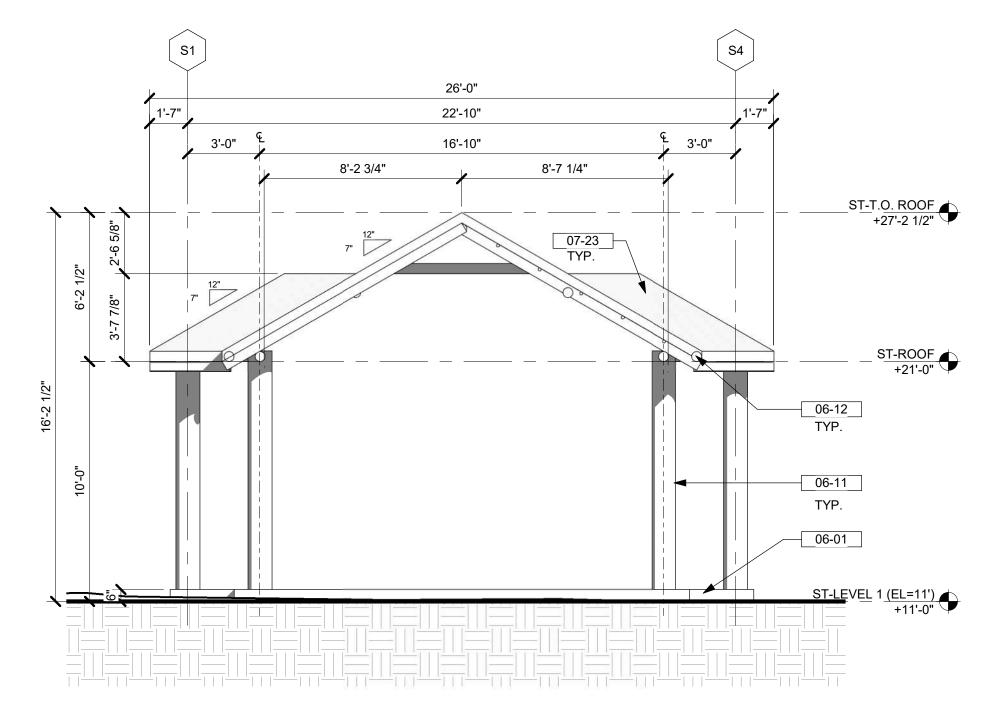


# 6 STAGE - SIDE 1 ELEVATION 1/4" = 1'-0"

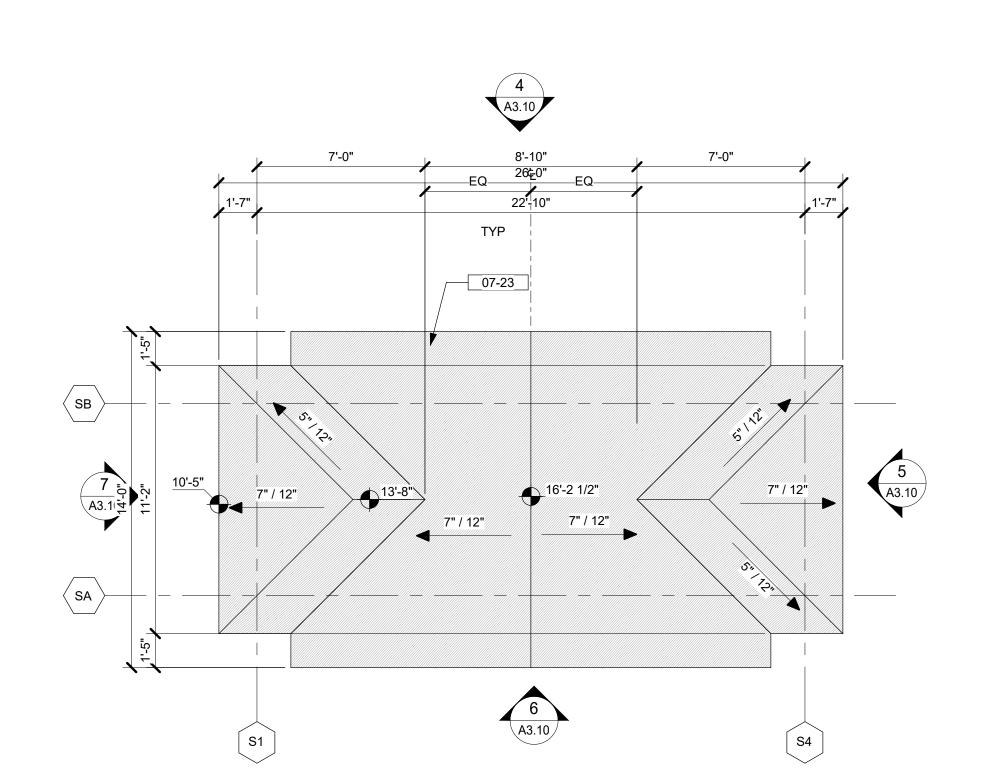


STAGE - ROOF PLAN

1/4" = 1'-0"

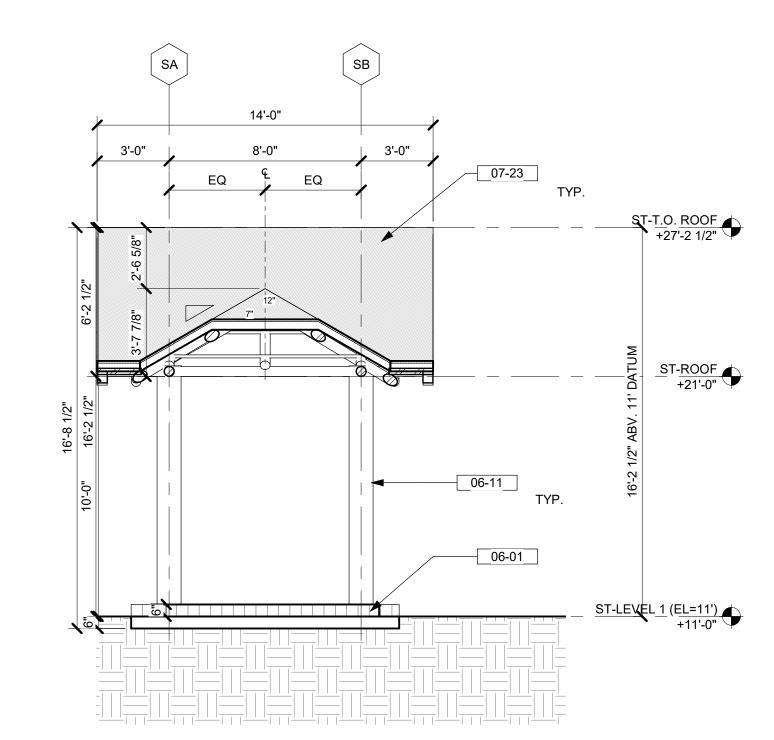


8 STAGE - SECTION A

1/4" = 1'-0"

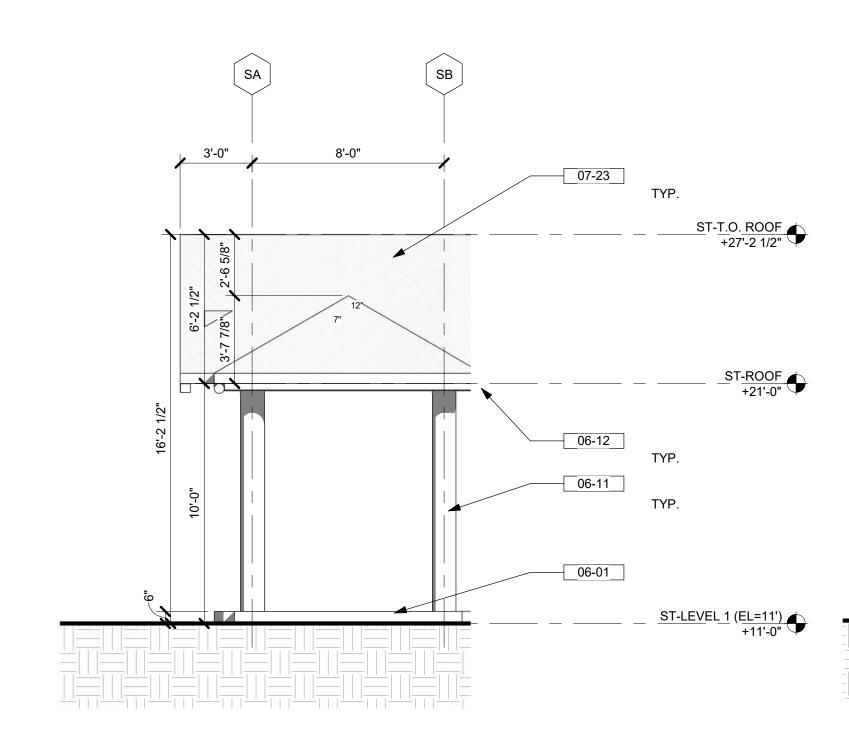


5 STAGE - FRONT ELEVATION


1/4" = 1'-0"

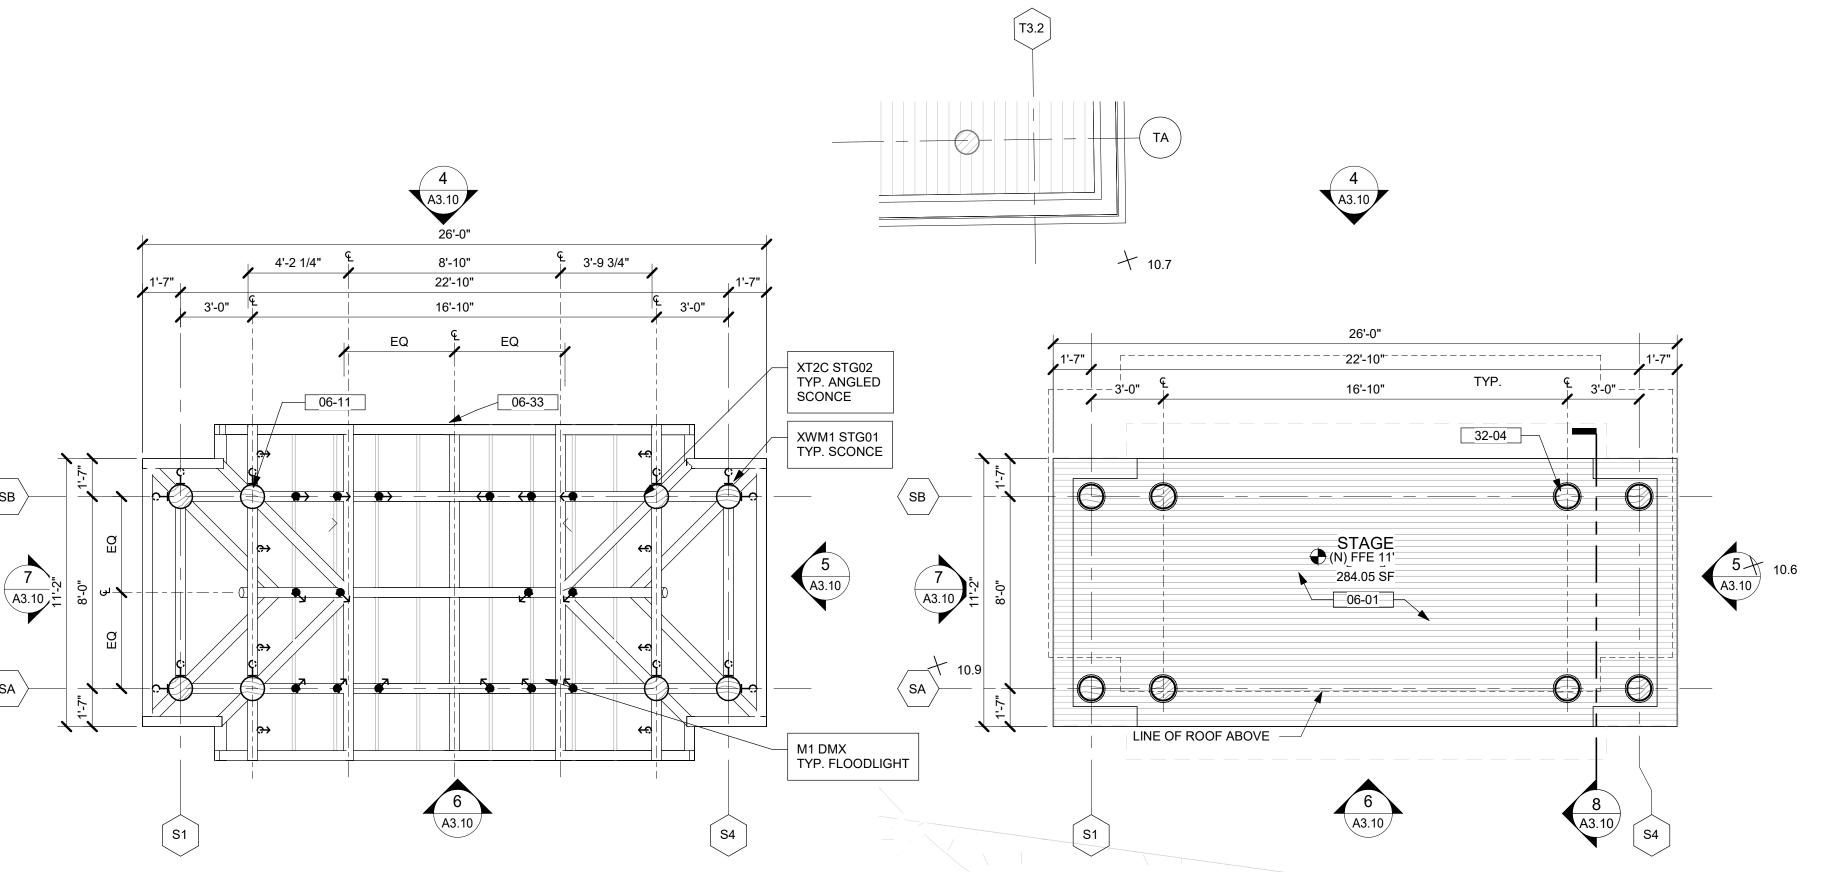



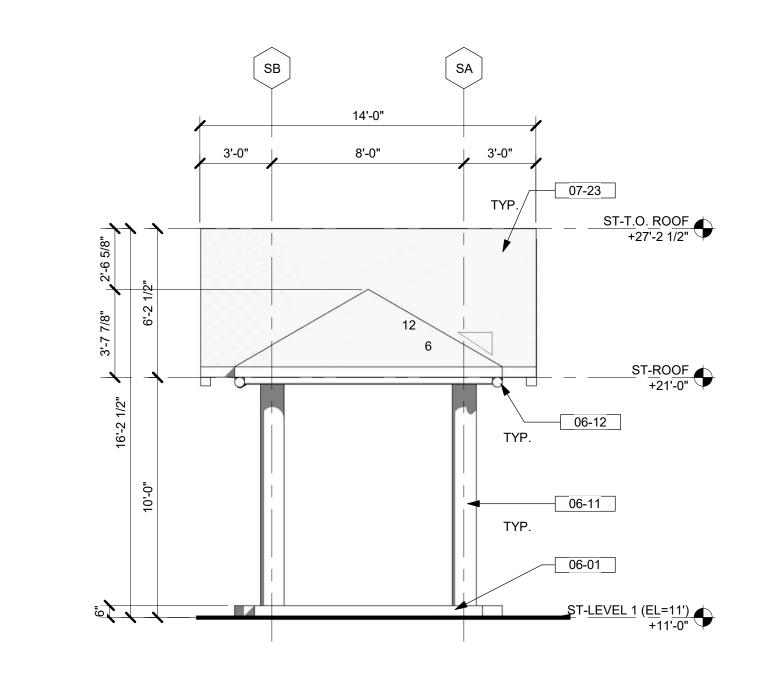

## 7 STAGE - REAR ELEVATION

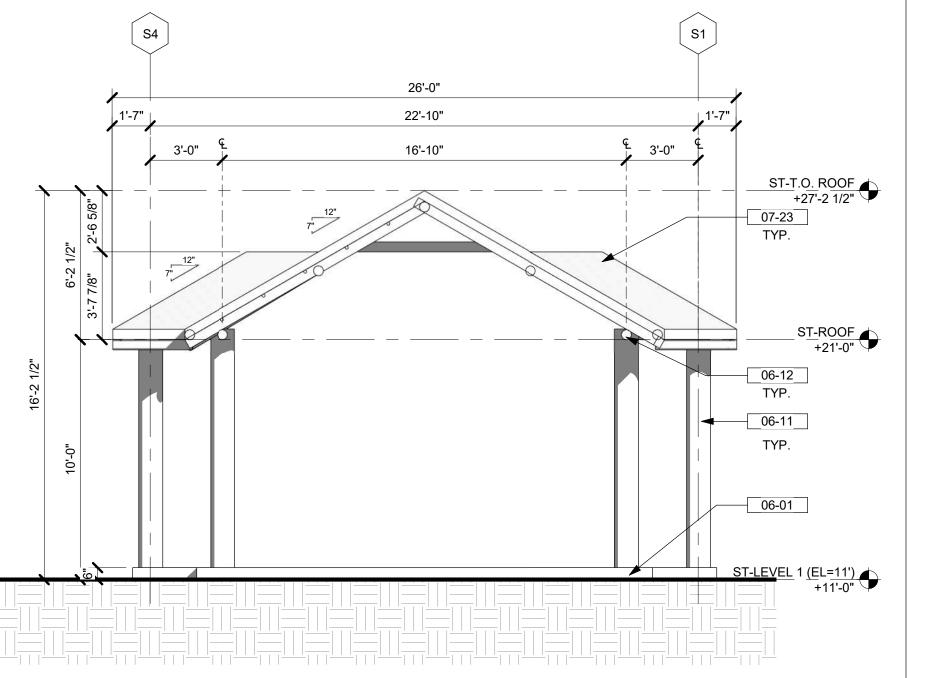

## 4 STAGE - SIDE 2 ELEVATION 1/4" = 1'-0"





strategy planning architecture landscape interiors PENDANT / CEILING MOUNTED REFER TO INTERIOR, ELECTRICAL, & LIGHTING DESIGN

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NOTE. SEE ARCHITECTURAL MATERIAL FINISHES ON A-10.01

**MATERIAL LEGEND** 



KEYNOTES / LEGENDS

**EXISTING TO REMAIN** 

NEW WALLS AND PARTITIONS -

SPOT ELEVATION PER SURVEY

SLOPE ARROW, SLOPE 1/8" PER FOOT @ INTERIOR AREAS & 1/4" PER FOOT @ EXTERIOR AREAS U.N.O.

SURFACE MOUNTED LIGHT REFER TO INTERIOR, ELECTRICAL & LIGHTING DWGS.

SURFACE MOUNTED LIGHT REFER TO INTERIOR,

WOOD COLUMN - SEE STRUCT. DWGS - WD - 06

WOOD BEAM - SEE STRUCT. DWGS - WD - 07 WOOD ROOF TRUST - SEE STRUCT. DWGS - WD - 06

1/2" ROUND OFFSET FOR OPENINGS AROUND

ELECTRICAL & LIGHTING DWGS.

WOOD DECK - WD - 03

THATCH ROOF - RF - 01

REFER TO WALL TYPES

**GRID LINES** 

NEW THATCH ROOF TO MATCH EXISTING



WOOD DECK WOOD SPECIE: CUMARU HARDWOOD

WD-03



WD-06

NEW WOOD COLUMN
(@ TIKI BAR) WOOD SPECIE: PRESSURE TREATED SOUTHERN YELLOW PINE



WD-07

NEW WOOD BEAM AND RAFTERS COLOR: CLEAR COAT NATURAL



XWM1 STG01




XT2C STG02 💆



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STAGE - ENLARGED FLOOR/RCP/ROOF/ELV/SEC

SCALE 1/16" = 1'-0" U.N.O.



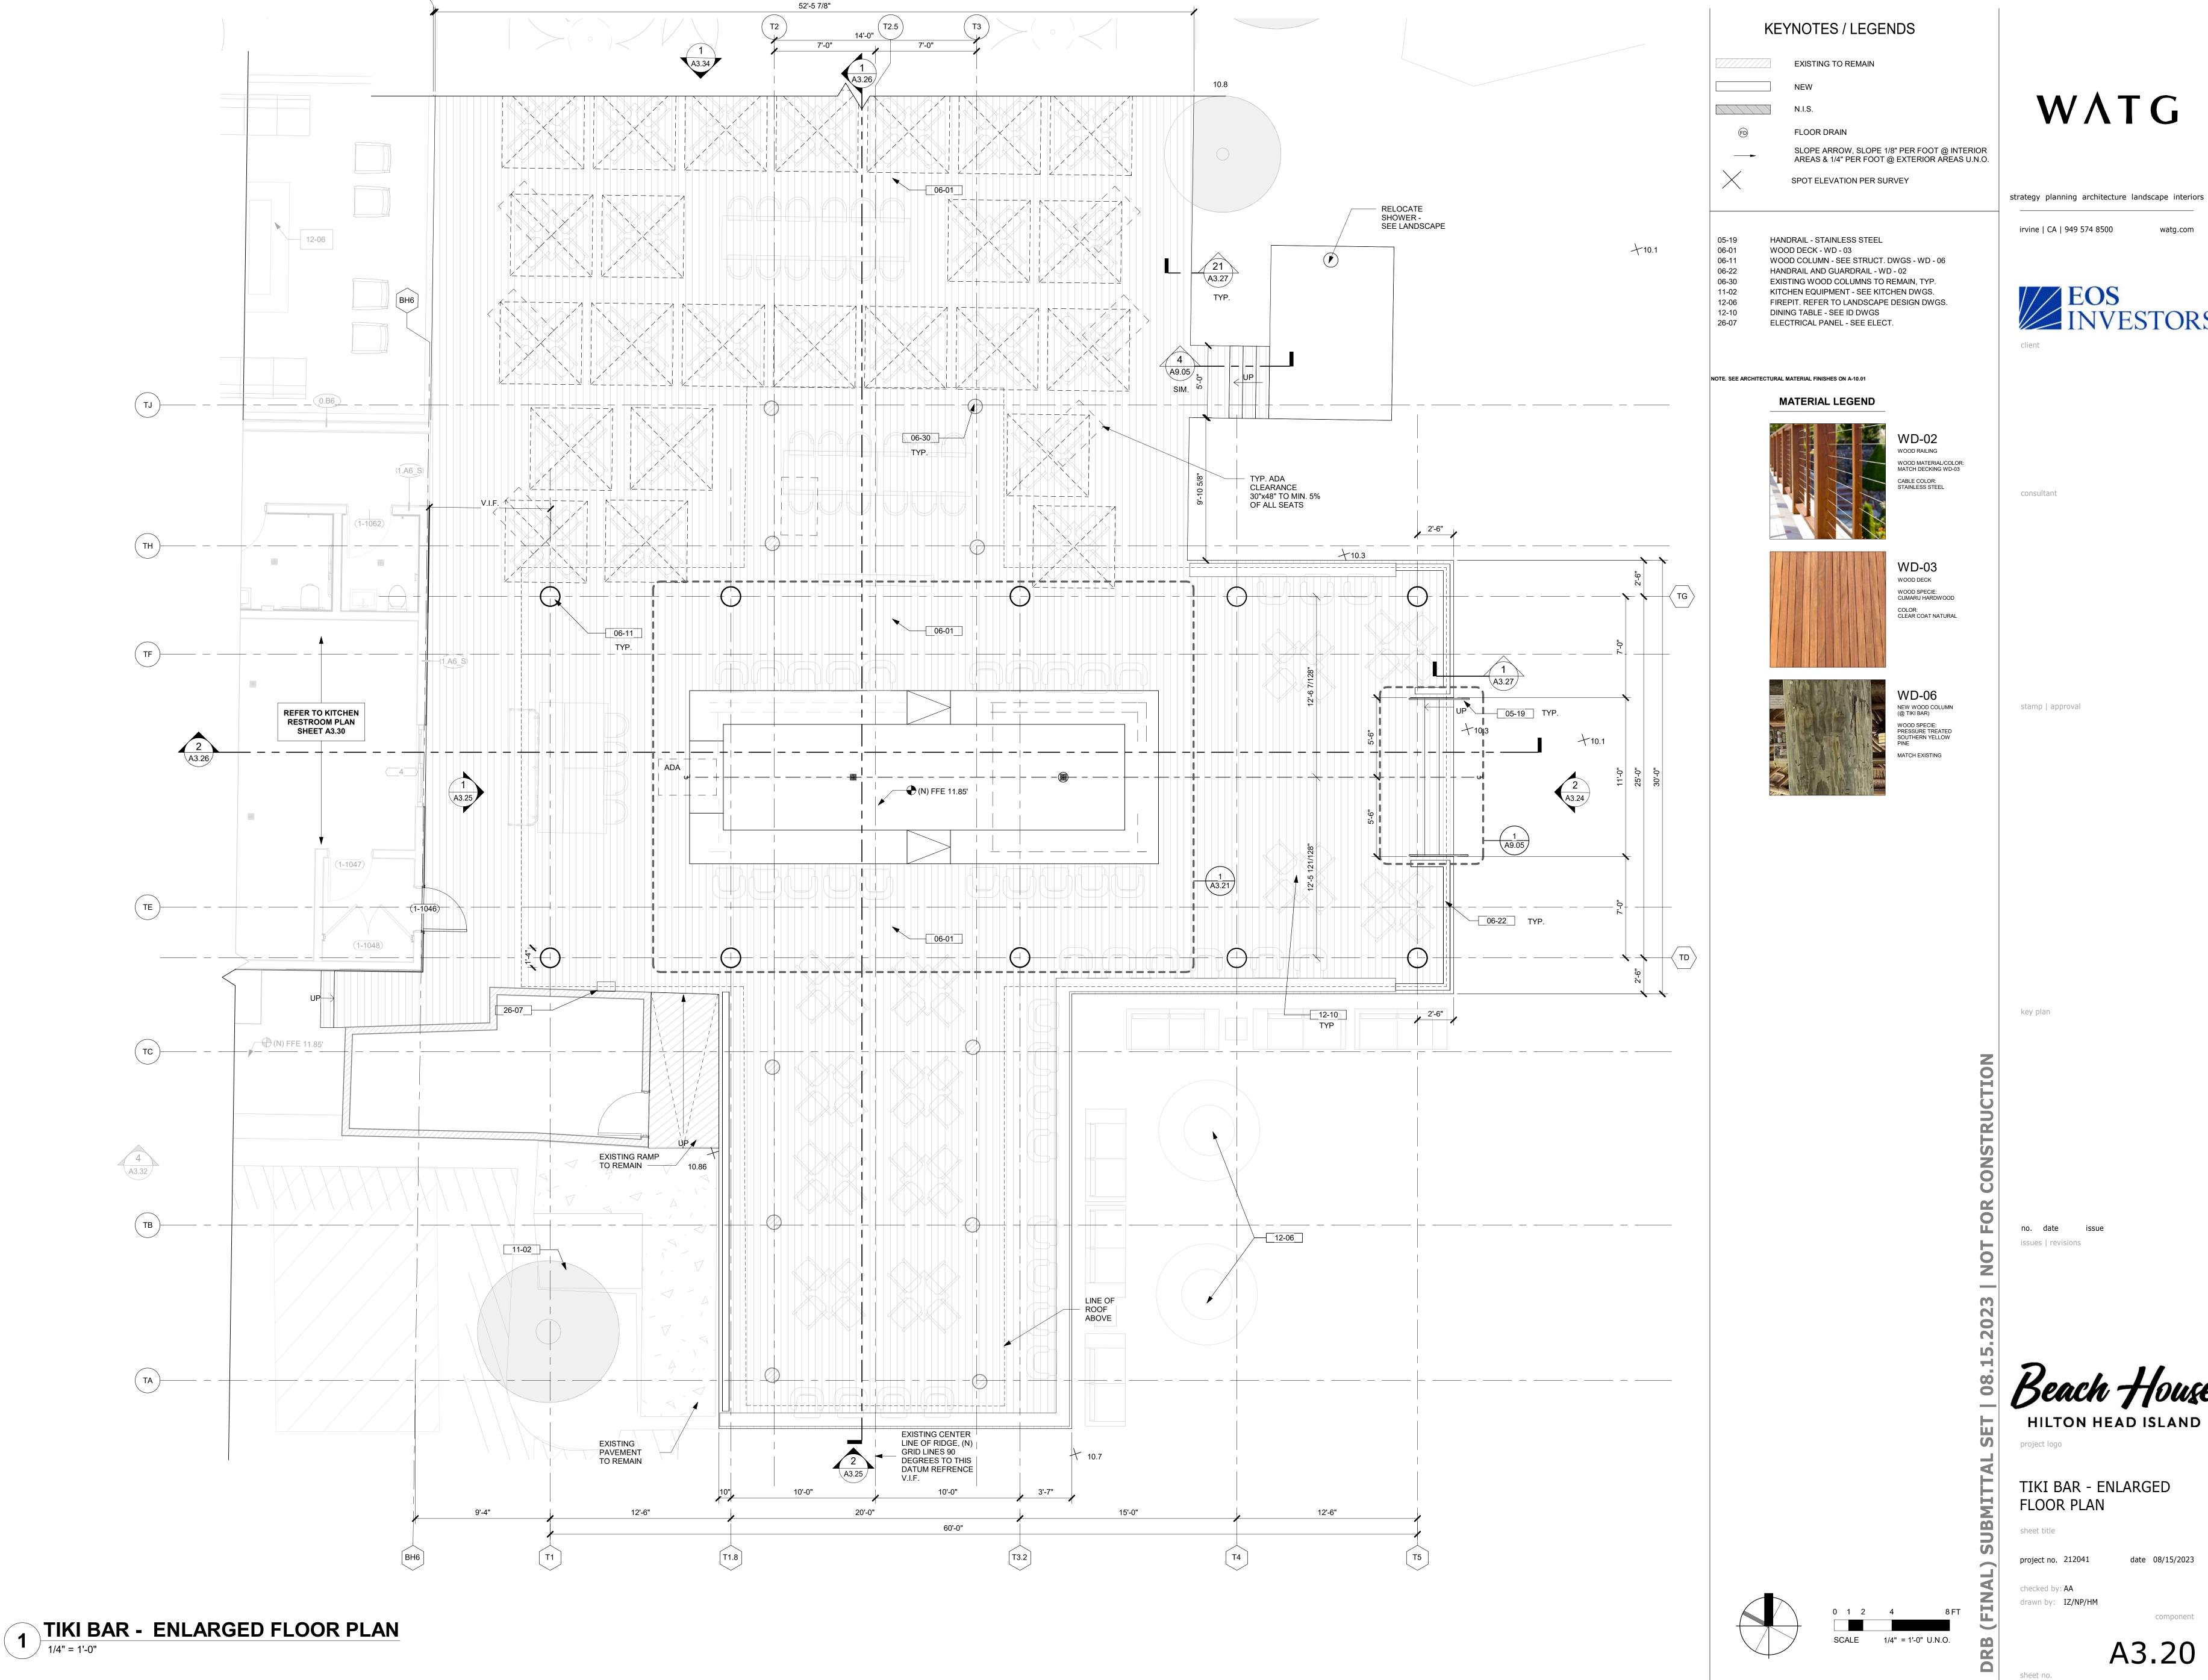



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EXISTING STORAGE SHED. WOOD COLUMN - SEE STRUCT. DWGS - WD - 06 EXISTING TIKI BAR STRUCTURAL MEMBERS TO REMAIN. PROTECT IN PLACE, U.N.O. WOOD STRUCTURE - SEE STRUCT. DWGS - WD - 06

**MATERIAL LEGEND** 

KEYNOTES / LEGENDS

EXISTING TO REMAIN

ELECTRICAL & LIGHTING DWGS.

ELECTRICAL & LIGHTING DWGS.

ELECTRICAL & LIGHTING DWGS.

DESIGN DWGS.

**NEW WALLS AND PARTITIONS -**REFER TO WALL TYPES

PENDANT / CEILING MOUNTED
REFER TO INTERIOR, ELECTRICAL, & LIGHTING

SURFACE MOUNTED LIGHT REFER TO INTERIOR,

SURFACE MOUNTED LIGHT REFER TO INTERIOR,

SURFACE MOUNTED LIGHT REFER TO INTERIOR,

SURFACE MOUNTED SCONCE LIGHT REFER TO INTERIOR, ELECTRICAL & LIGHTING DWGS.

NOTE. SEE ARCHITECTURAL MATERIAL FINISHES ON A-10.01



WD-06 NEW WOOD COLUMN (@ TIKI BAR) WOOD SPECIE: PRESSURE TREATED SOUTHERN YELLOW PINE MATCH EXISTING




XWM1 BAR01 TYP. SURFACE MOUNTED SCONCE



XT2C BAR02 / XT1C BAR03 / XT1B BAR04 FINISH: BRONZE LIVING PATINA COUNT: 44 + 41 + 10 = 95



FFEF BAR12

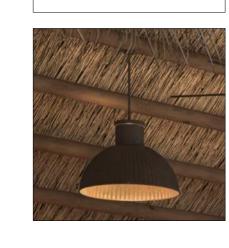

FFEP BAR11 FINISH: MATTE BRONZE FINISH AND BRASS METAL POWDER COATED INSIDE


SCALE 1/4" = 1'-0" U.N.O.

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key plan

TIKI BAR - ENLARGED REFLECTED CEILING PLAN

drawn by: IZ/NP/HM

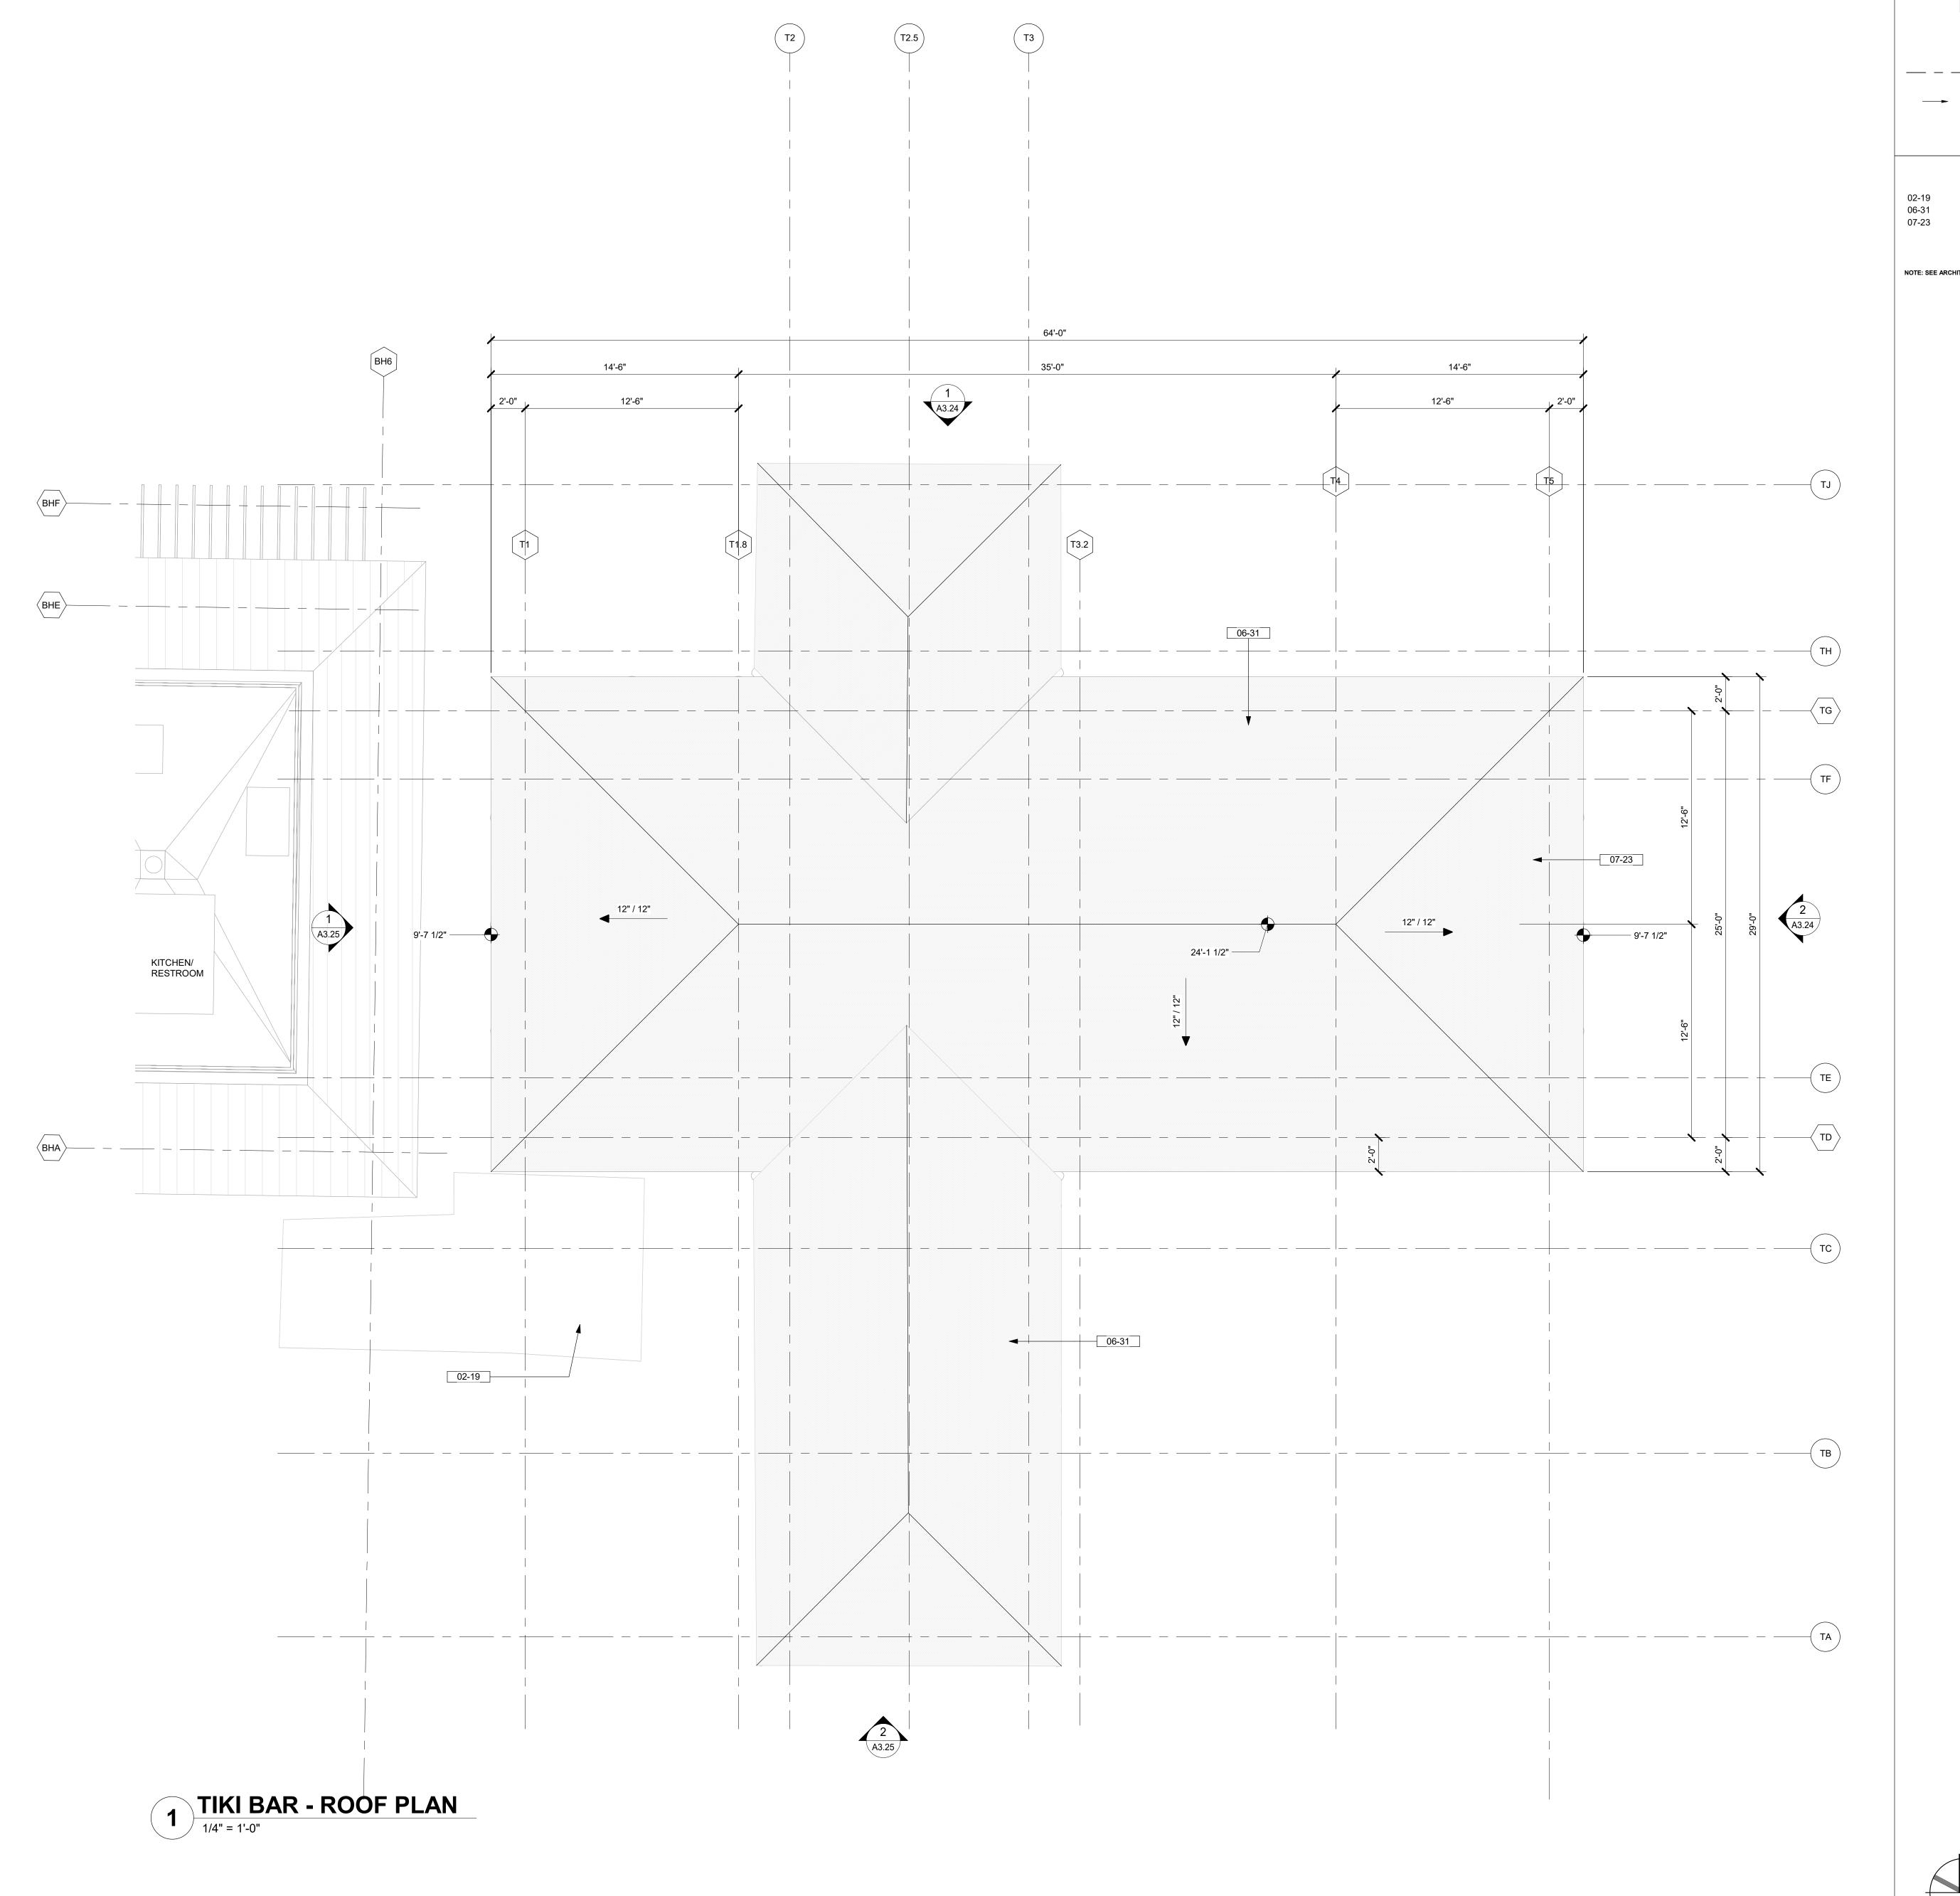

— — GRID LINES


SLOPE ARROW

WATG

EXISTING STORAGE SHED. EXISTING TIKI BAR STRUCTURE TO REMAIN. THATCH ROOF - RF - 01

NOTE: SEE ARCHITECTURAL MATERIAL FINISHES ON A-10.01

**MATERIAL LEGEND** 

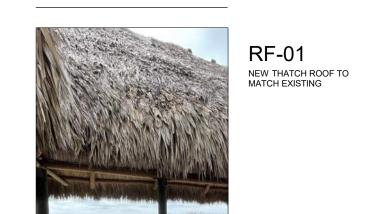

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TIKI BAR - ROOF PLAN


drawn by: IZ/NP/HM

A3.23

0 0.5 1 2 4 FT

SCALE 1/2" = 1'-0" U.N.O.

## TIKI BAR - FRONT ELEVATION

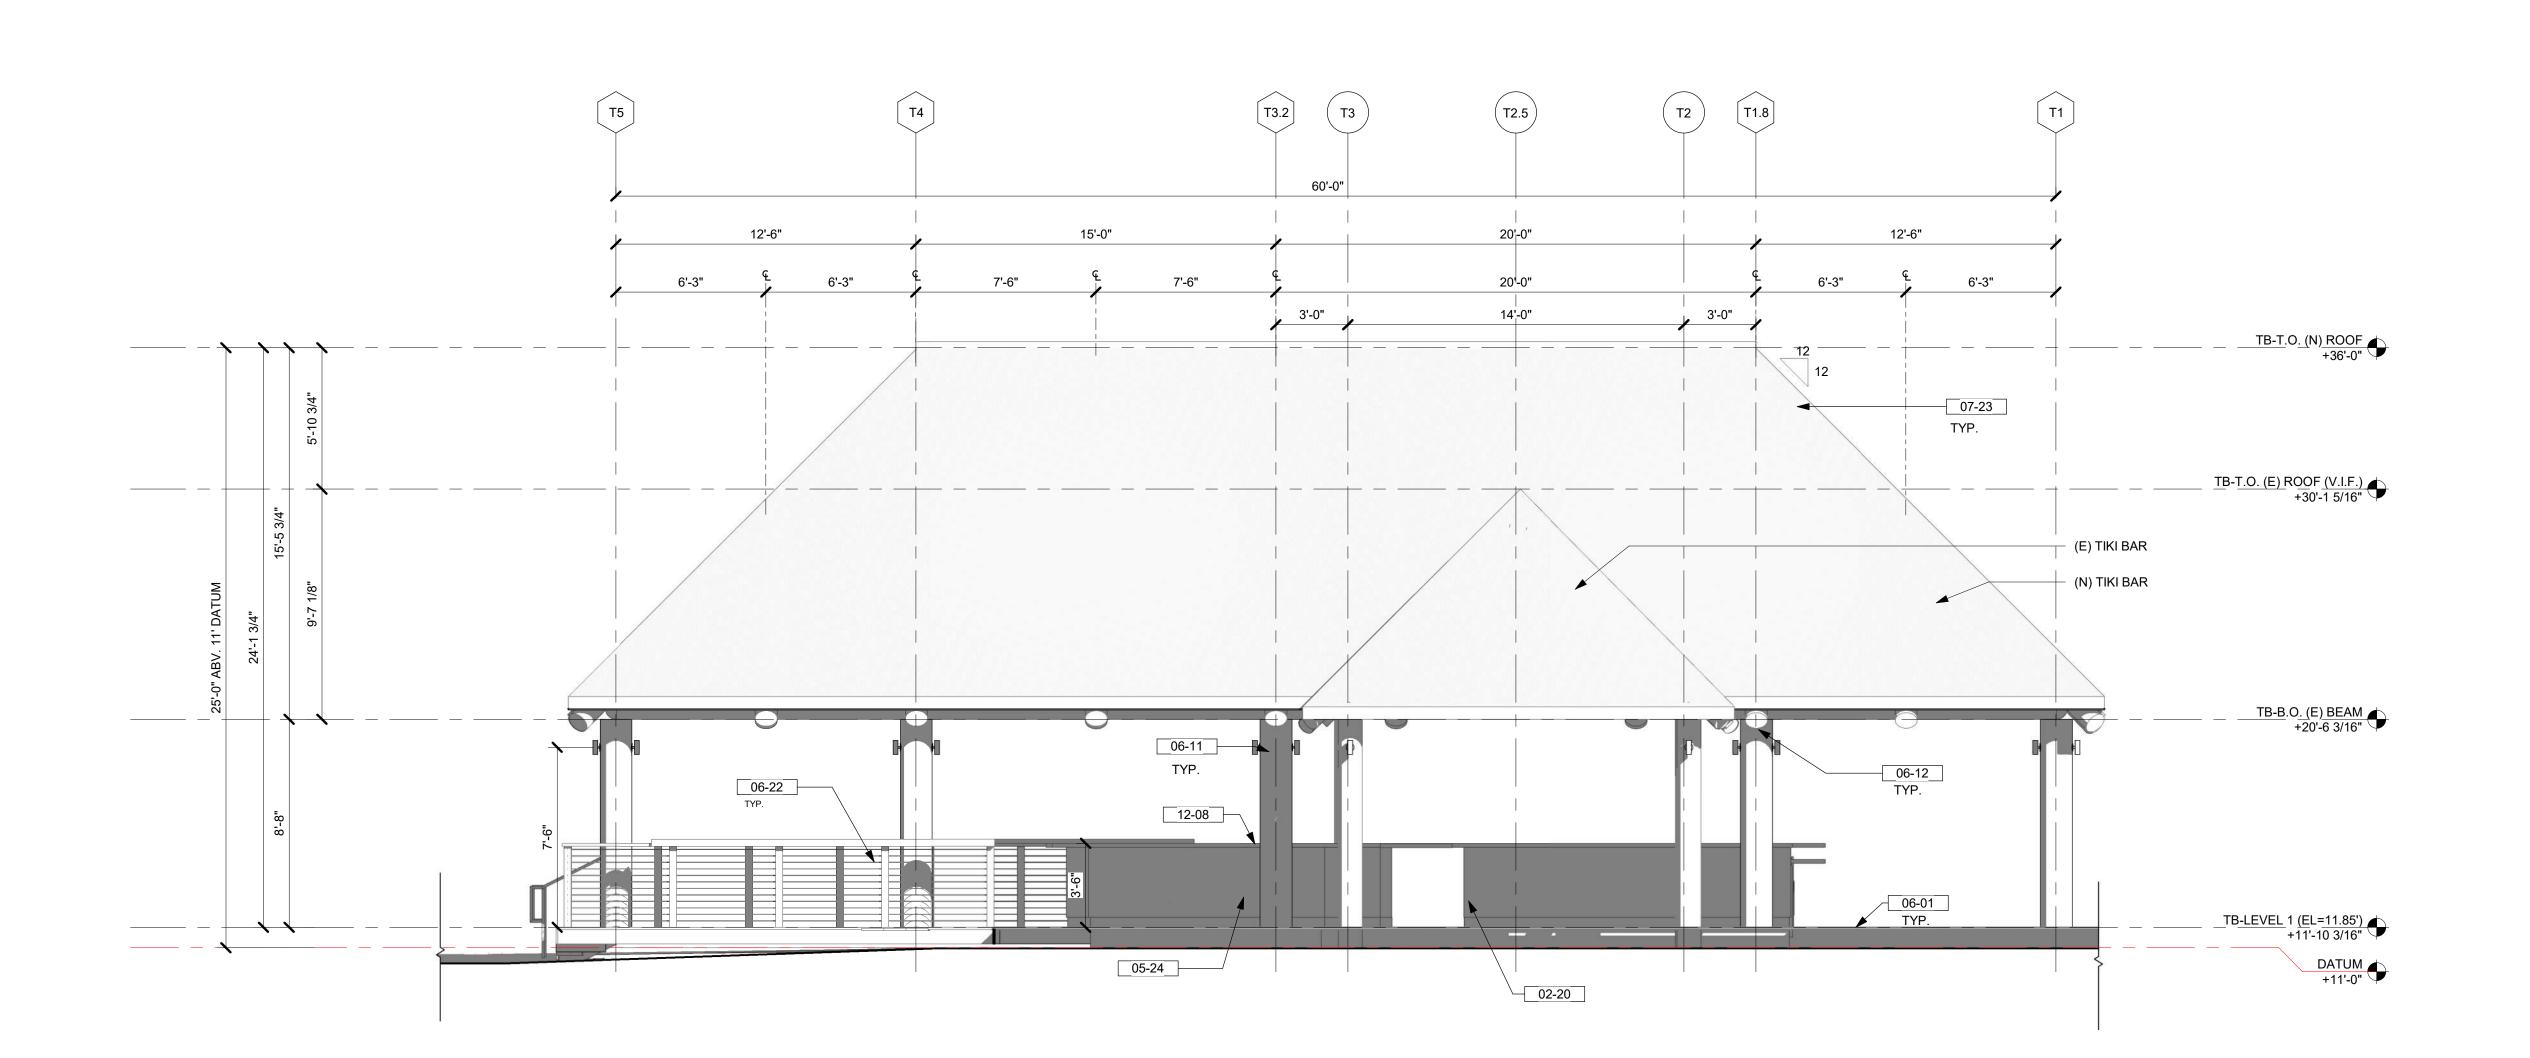

1 TIKI BAR - SIDE 1 ELEVATION

1/4" = 1'-0"

KEYNOTES / LEGENDS

NOTE: 11'-0" DATUM IS BASED ON SURVEY 11.0' ELEVATION ABOVE SEA LEVEL USING MEAN SEA LEVEL NAVD88

(E): EXISTING (N): NEW

EXISTING BAR DIE WALL. REFURBISH AS NEEDED TO MATCH NEW FINISHES. RAMP HANDRAIL - STAINLESS STEEL HANDRAIL - STAINLESS STEEL 05-19

05-24 DIE WALL. VERIFY EXISTING WALL CONSTRUCTION / ASSEMBLY TO MATCH EXISTING. WOOD DECK - WD - 03 06-11 WOOD COLUMN - SEE STRUCT. DWGS - WD - 06 06-12 WOOD BEAM - SEE STRUCT. DWGS - WD - 07 HANDRAIL AND GUARDRAIL - WD - 02

07-23 THATCH ROOF - RF - 01 BAR COUNTER. REFER TO INTERIOR DESIGN DWGS.

NOTE: SEE ARCHITECTURAL MATERIAL FINISHES ON A-10.01

### **MATERIAL LEGEND**







WD-07
NEW WOOD BEAM AND
RAFTERS

WD-06

NEW WOOD COLUMN (@ TIKI BAR)

WOOD SPECIE: PRESSURE TREATED SOUTHERN YELLOW PINE



MTL-01 WOOD STRUCTURAL STEEL CONNECTIONS FINISH: STAINLESS STEEL

COLOR: CLEAR COAT NATURAL

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sheet no.

drawn by: IZ/NP/HM

0 1 2 4 SCALE 1/4" = 1'-0" U.N.O.

NEW THATCH ROOF TO MATCH EXISTING WOOD RAILING WOOD MATERIAL/COLOR: MATCH DECKING WD-03 CABLE COLOR: STAINLESS STEEL WD-03 WOOD DECK WOOD SPECIE: CUMARU HARDWOOD COLOR: CLEAR COAT NATURAL

RF-01

WATG

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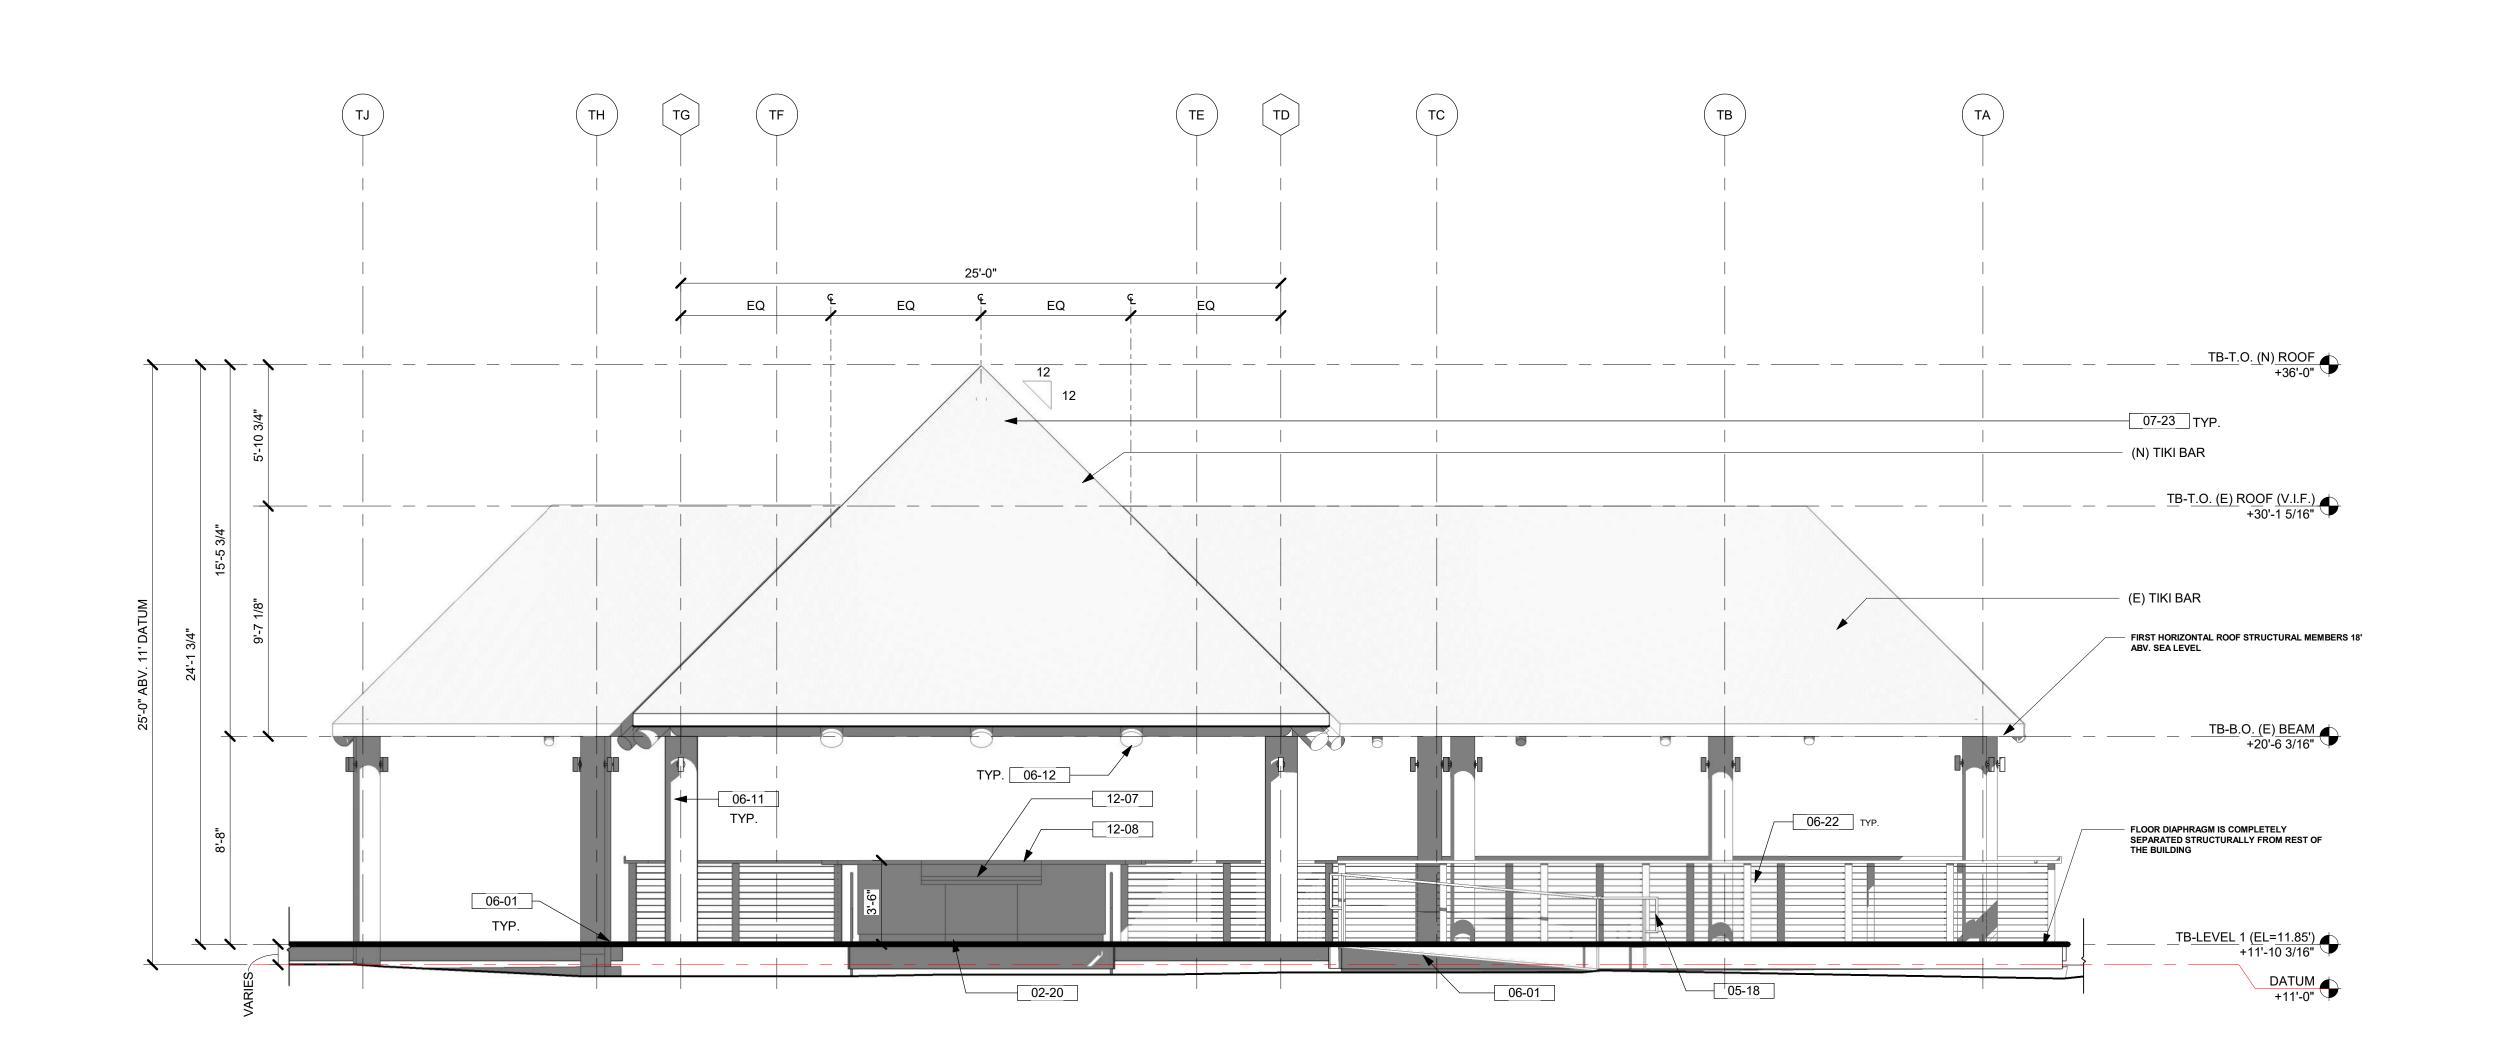
consultant

stamp | approval

key plan

TIKI BAR - ELEVATIONS

## TIKI BAR - SIDE 2 ELEVATION



TIKI BAR - REAR ELEVATION

1/4" = 1'-0"

## KEYNOTES / LEGENDS

NOTE: 11'-0" DATUM IS BASED ON SURVEY 11.0' ELEVATION ABOVE SEA LEVEL USING MEAN SEA LEVEL NAVD88


EXISTING BAR DIE WALL. REFURBISH AS NEEDED TO MATCH NEW FINISHES. RAMP HANDRAIL - STAINLESS STEEL WOOD DECK - WD - 03 WOOD COLUMN - SEE STRUCT. DWGS - WD - 06 WOOD BEAM - SEE STRUCT. DWGS - WD - 07 HANDRAIL AND GUARDRAIL - WD - 02 07-23 THATCH ROOF - RF - 01

CODE ACCESSIBLE BAR COUNTER. REFER TO INTERIOR DESIGN DWGS. BAR COUNTER. REFER TO INTERIOR DESIGN DWGS.

NOTE: SEE ARCHITECTURAL MATERIAL FINISHES ON A-10.01

## **MATERIAL LEGEND**



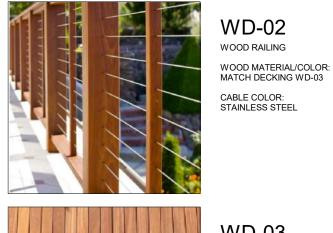

WD-03 WOOD DECK WOOD SPECIE: CUMARU HARDWOOD COLOR: CLEAR COAT NATURAL



WD-06 NEW WOOD COLUMN (@ TIKI BAR) WOOD SPECIE: PRESSURE TREATED SOUTHERN YELLOW PINE MATCH EXISTING



WD-07 NEW WOOD BEAM AND RAFTERS WOOD SPECIE: SOUTHERN YELLOW PINE MATCH EXISTING COLOR: CLEAR COAT NATURAL

no. date

issues | revisions

key plan

WATG

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**EOS** INVESTORS

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consultant

stamp | approval


TIKI BAR - ELEVATIONS

checked by: AA drawn by: IZ/NP/HM

sheet no.

A3.25

0 1 2 4 SCALE 1/4" = 1'-0" U.N.O.

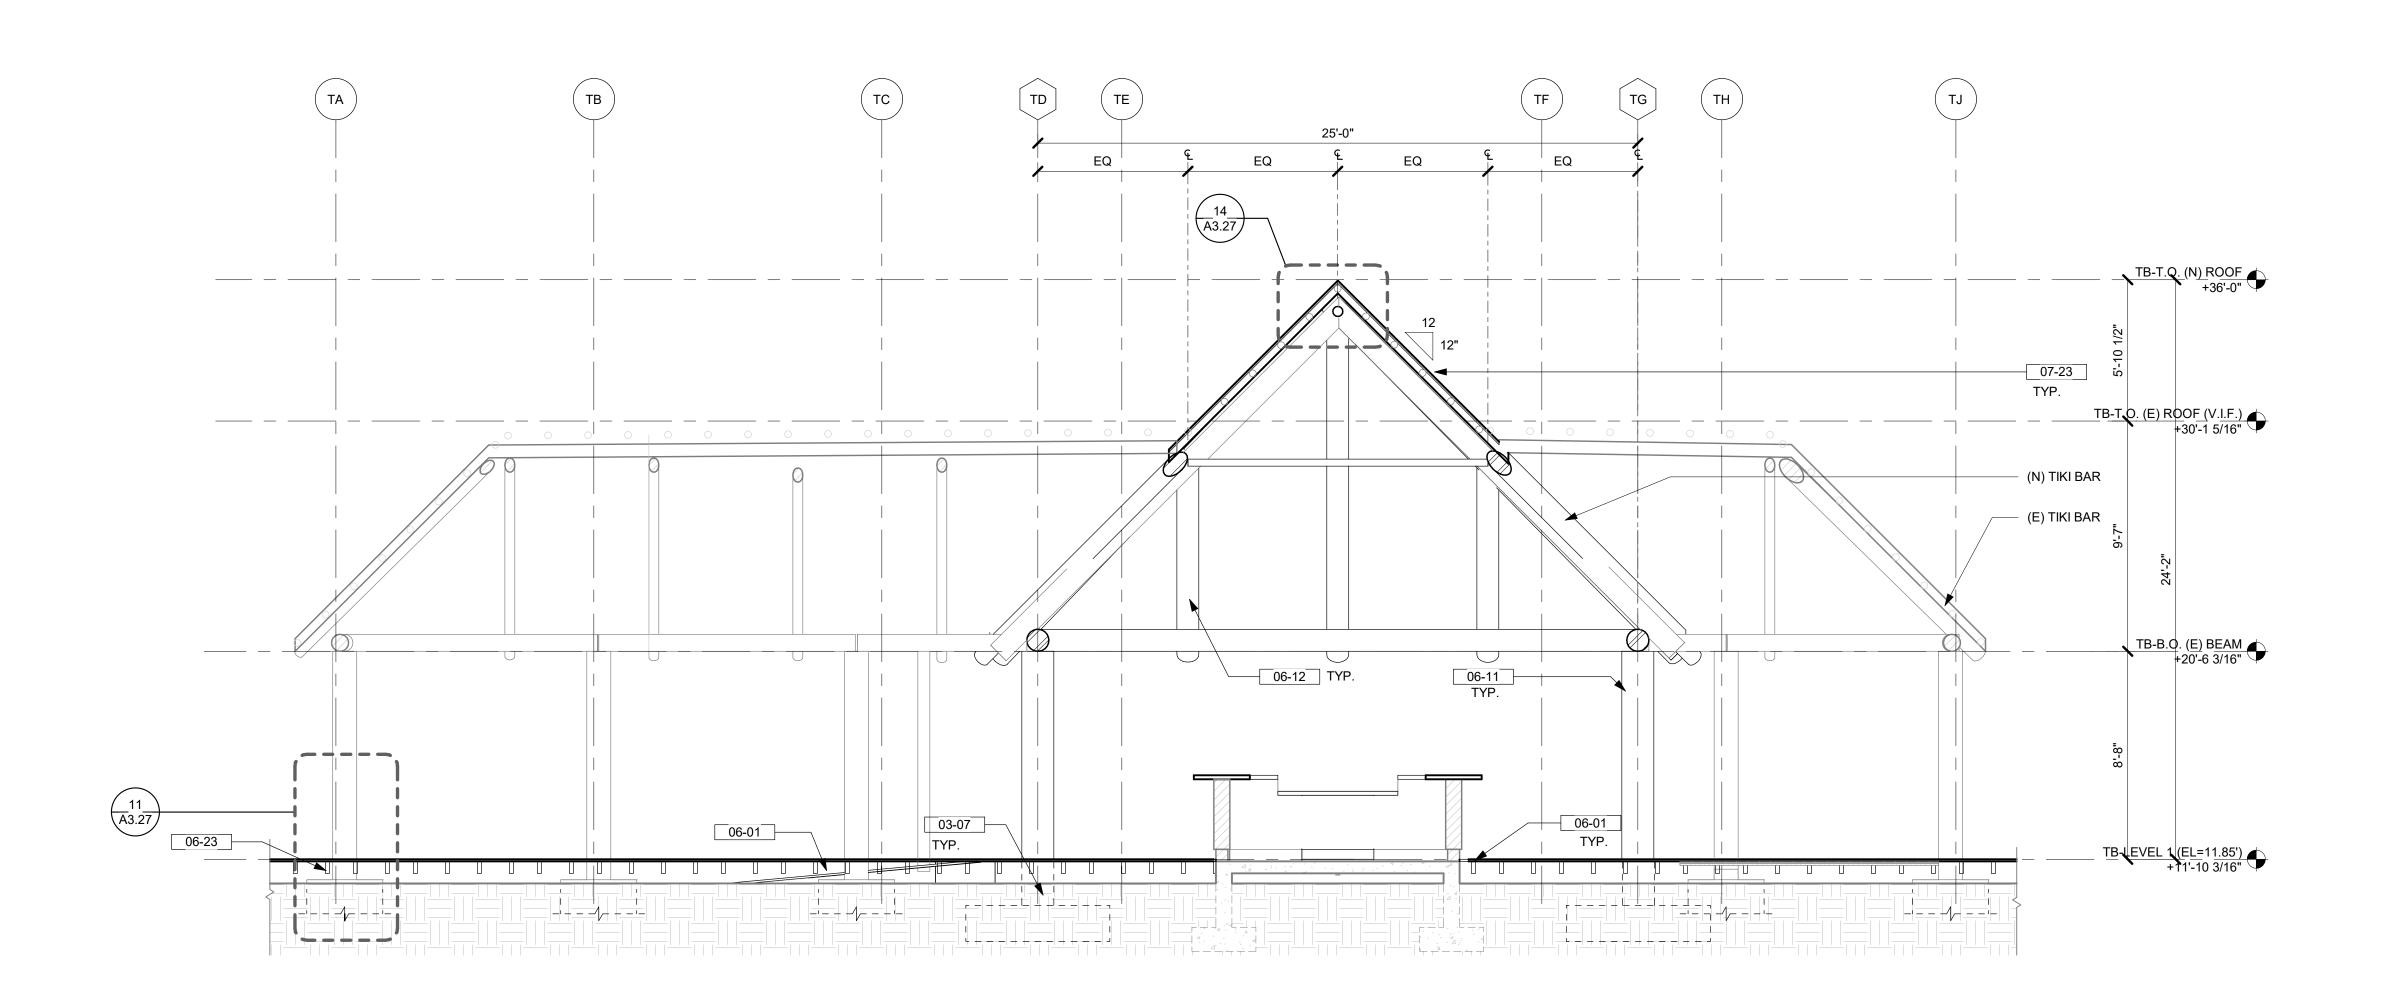

1 TIKI BAR - SECTION A
1/4" = 1'-0"

## KEYNOTES / LEGENDS

(E): EXISTING (N): NEW

> EXISTING BAR DIE WALL. REFURBISH AS NEEDED TO MATCH NEW FINISHES. CONCRETE FOOTING - SEE STRUCT. DWGS. HANDRAIL - STAINLESS STEEL WOOD DECK - WD - 03

WOOD COLUMN - SEE STRUCT. DWGS - WD - 06 WOOD BEAM - SEE STRUCT. DWGS - WD - 07 HANDRAIL AND GUARDRAIL - WD - 02 PRESSURE TREATED WOOD FLOOR JOISTS - SEE STRUCT. DWGS.

THATCH ROOF - RF - 01

NOTE: SEE ARCHITECTURAL MATERIAL FINISHES ON A-10.01

### **MATERIAL LEGEND**



NEW THATCH ROOF TO MATCH EXISTING



WOOD MATERIAL/COLOR: MATCH DECKING WD-03 WD-03

WOOD DECK

WOOD SPECIE: CUMARU HARDWOOD

COLOR: CLEAR COAT NATURAL

WOOD RAILING



WD-07
NEW WOOD BEAM AND RAFTERS WOOD SPECIE: SOUTHERN YELLOW PINE

COLOR: CLEAR COAT NATURAL

0 1 2 4

SCALE 1/4" = 1'-0" U.N.O.

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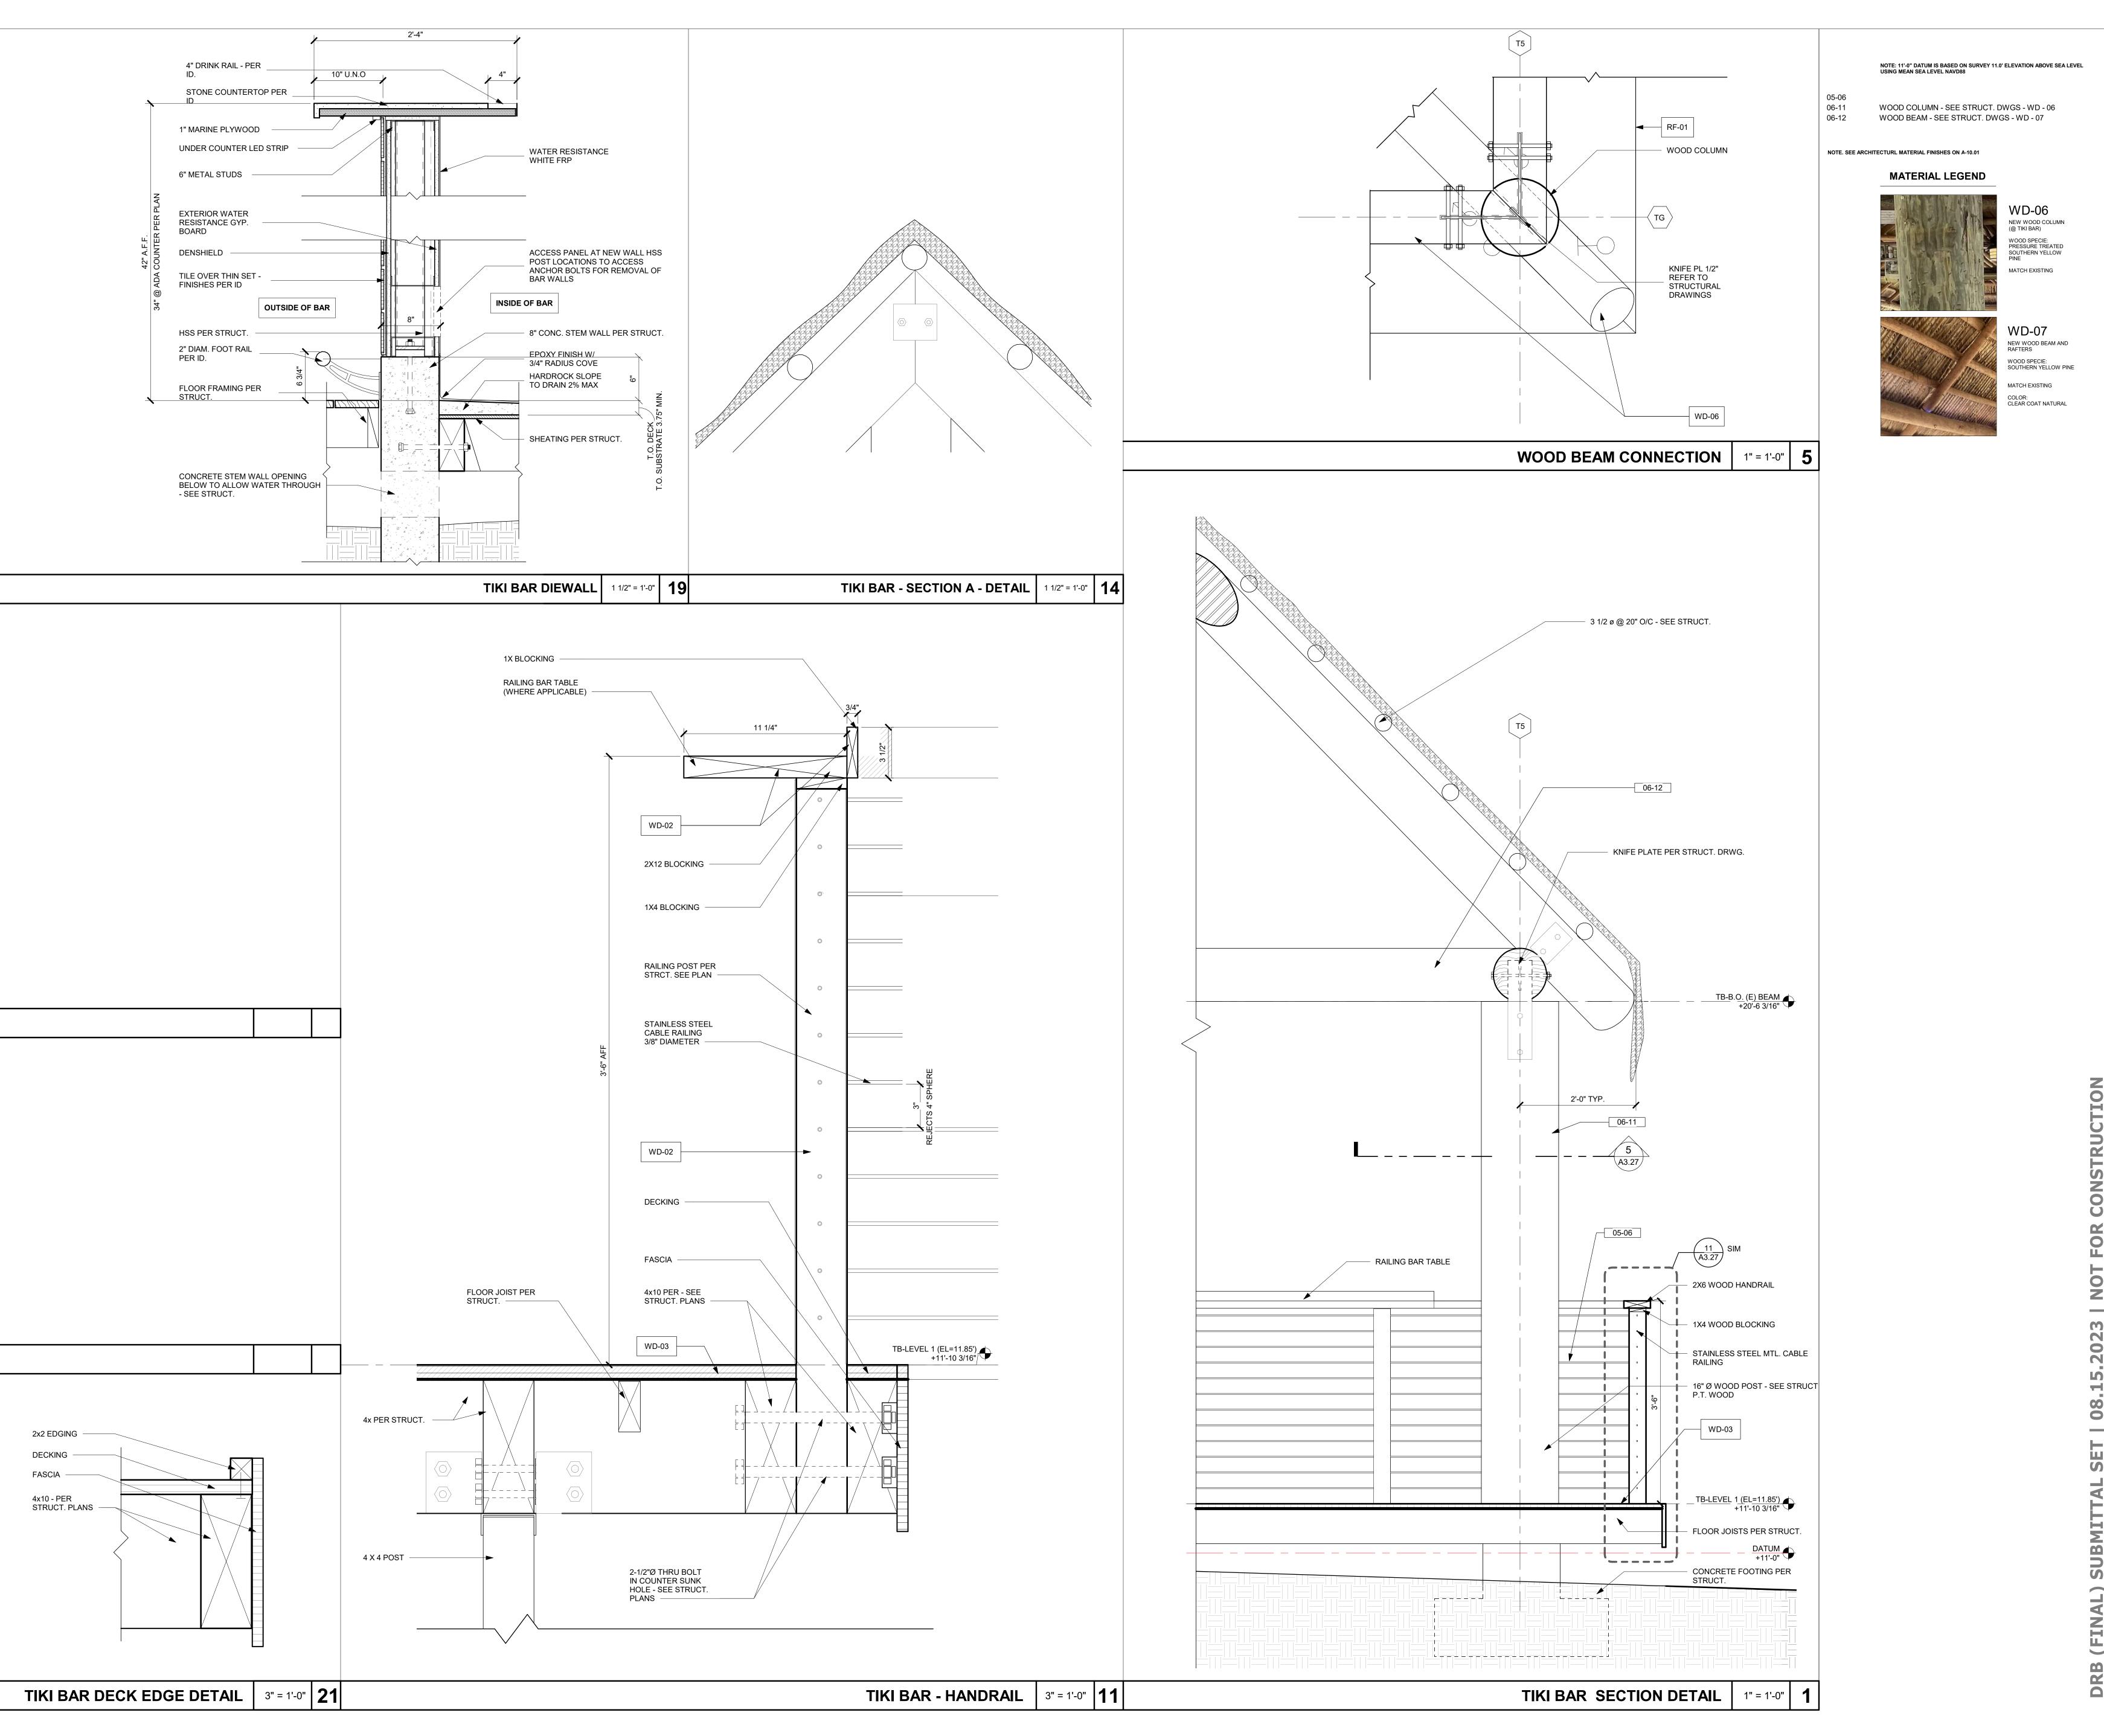
key plan

issues | revisions

TIKI BAR - SECTIONS

project no. 212041 checked by: AA drawn by: IZ/NP/HM

sheet no.



WATG

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consultant

stamp | approval


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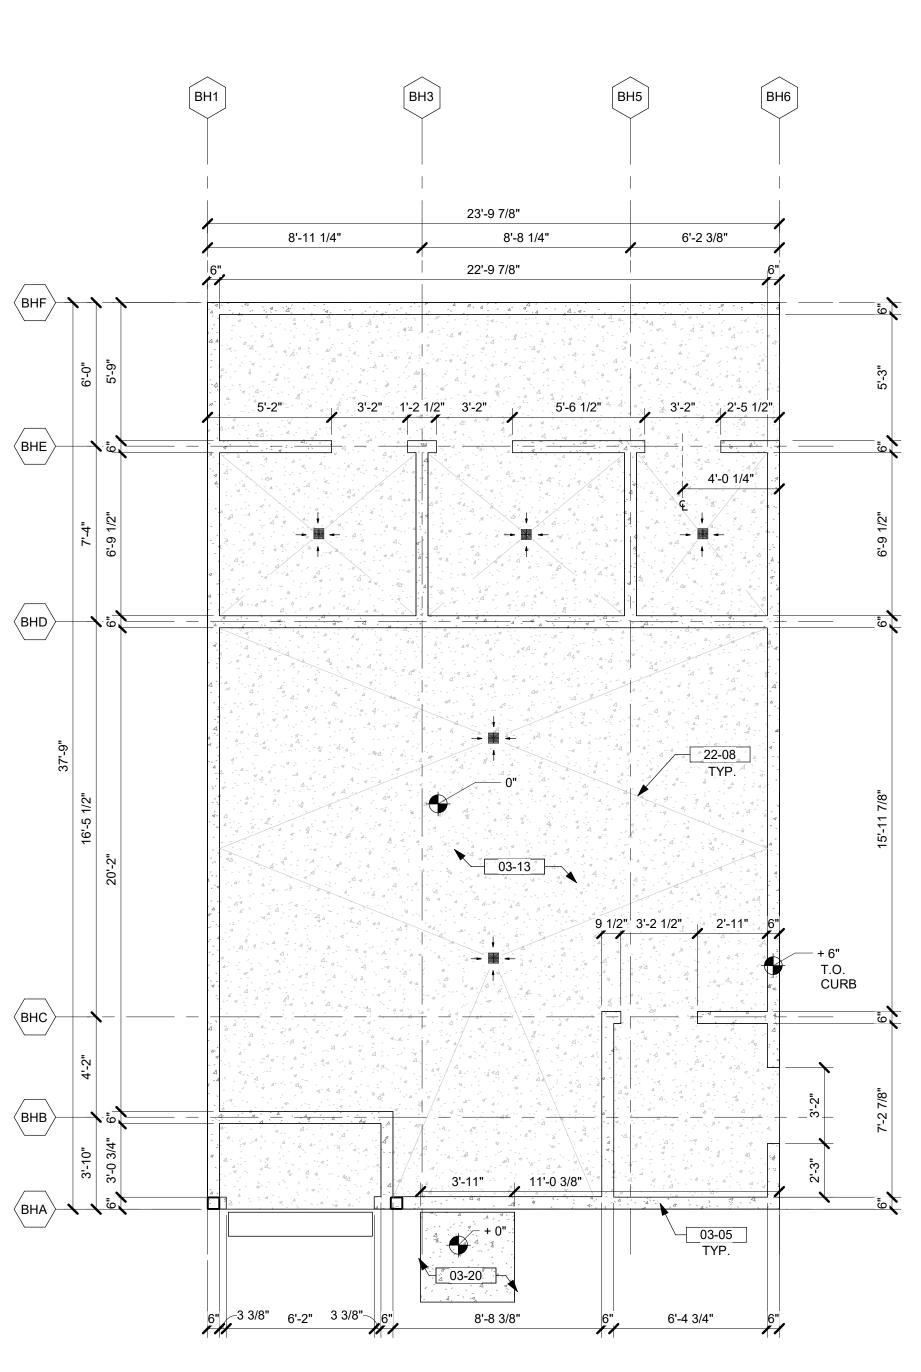
issues | revisions

project logo TIKI BAR -

SECTION/DETAILS


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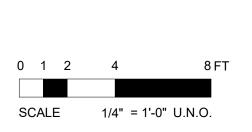



1 KITCHEN/RESTROOM BLDG - SLAB PLAN

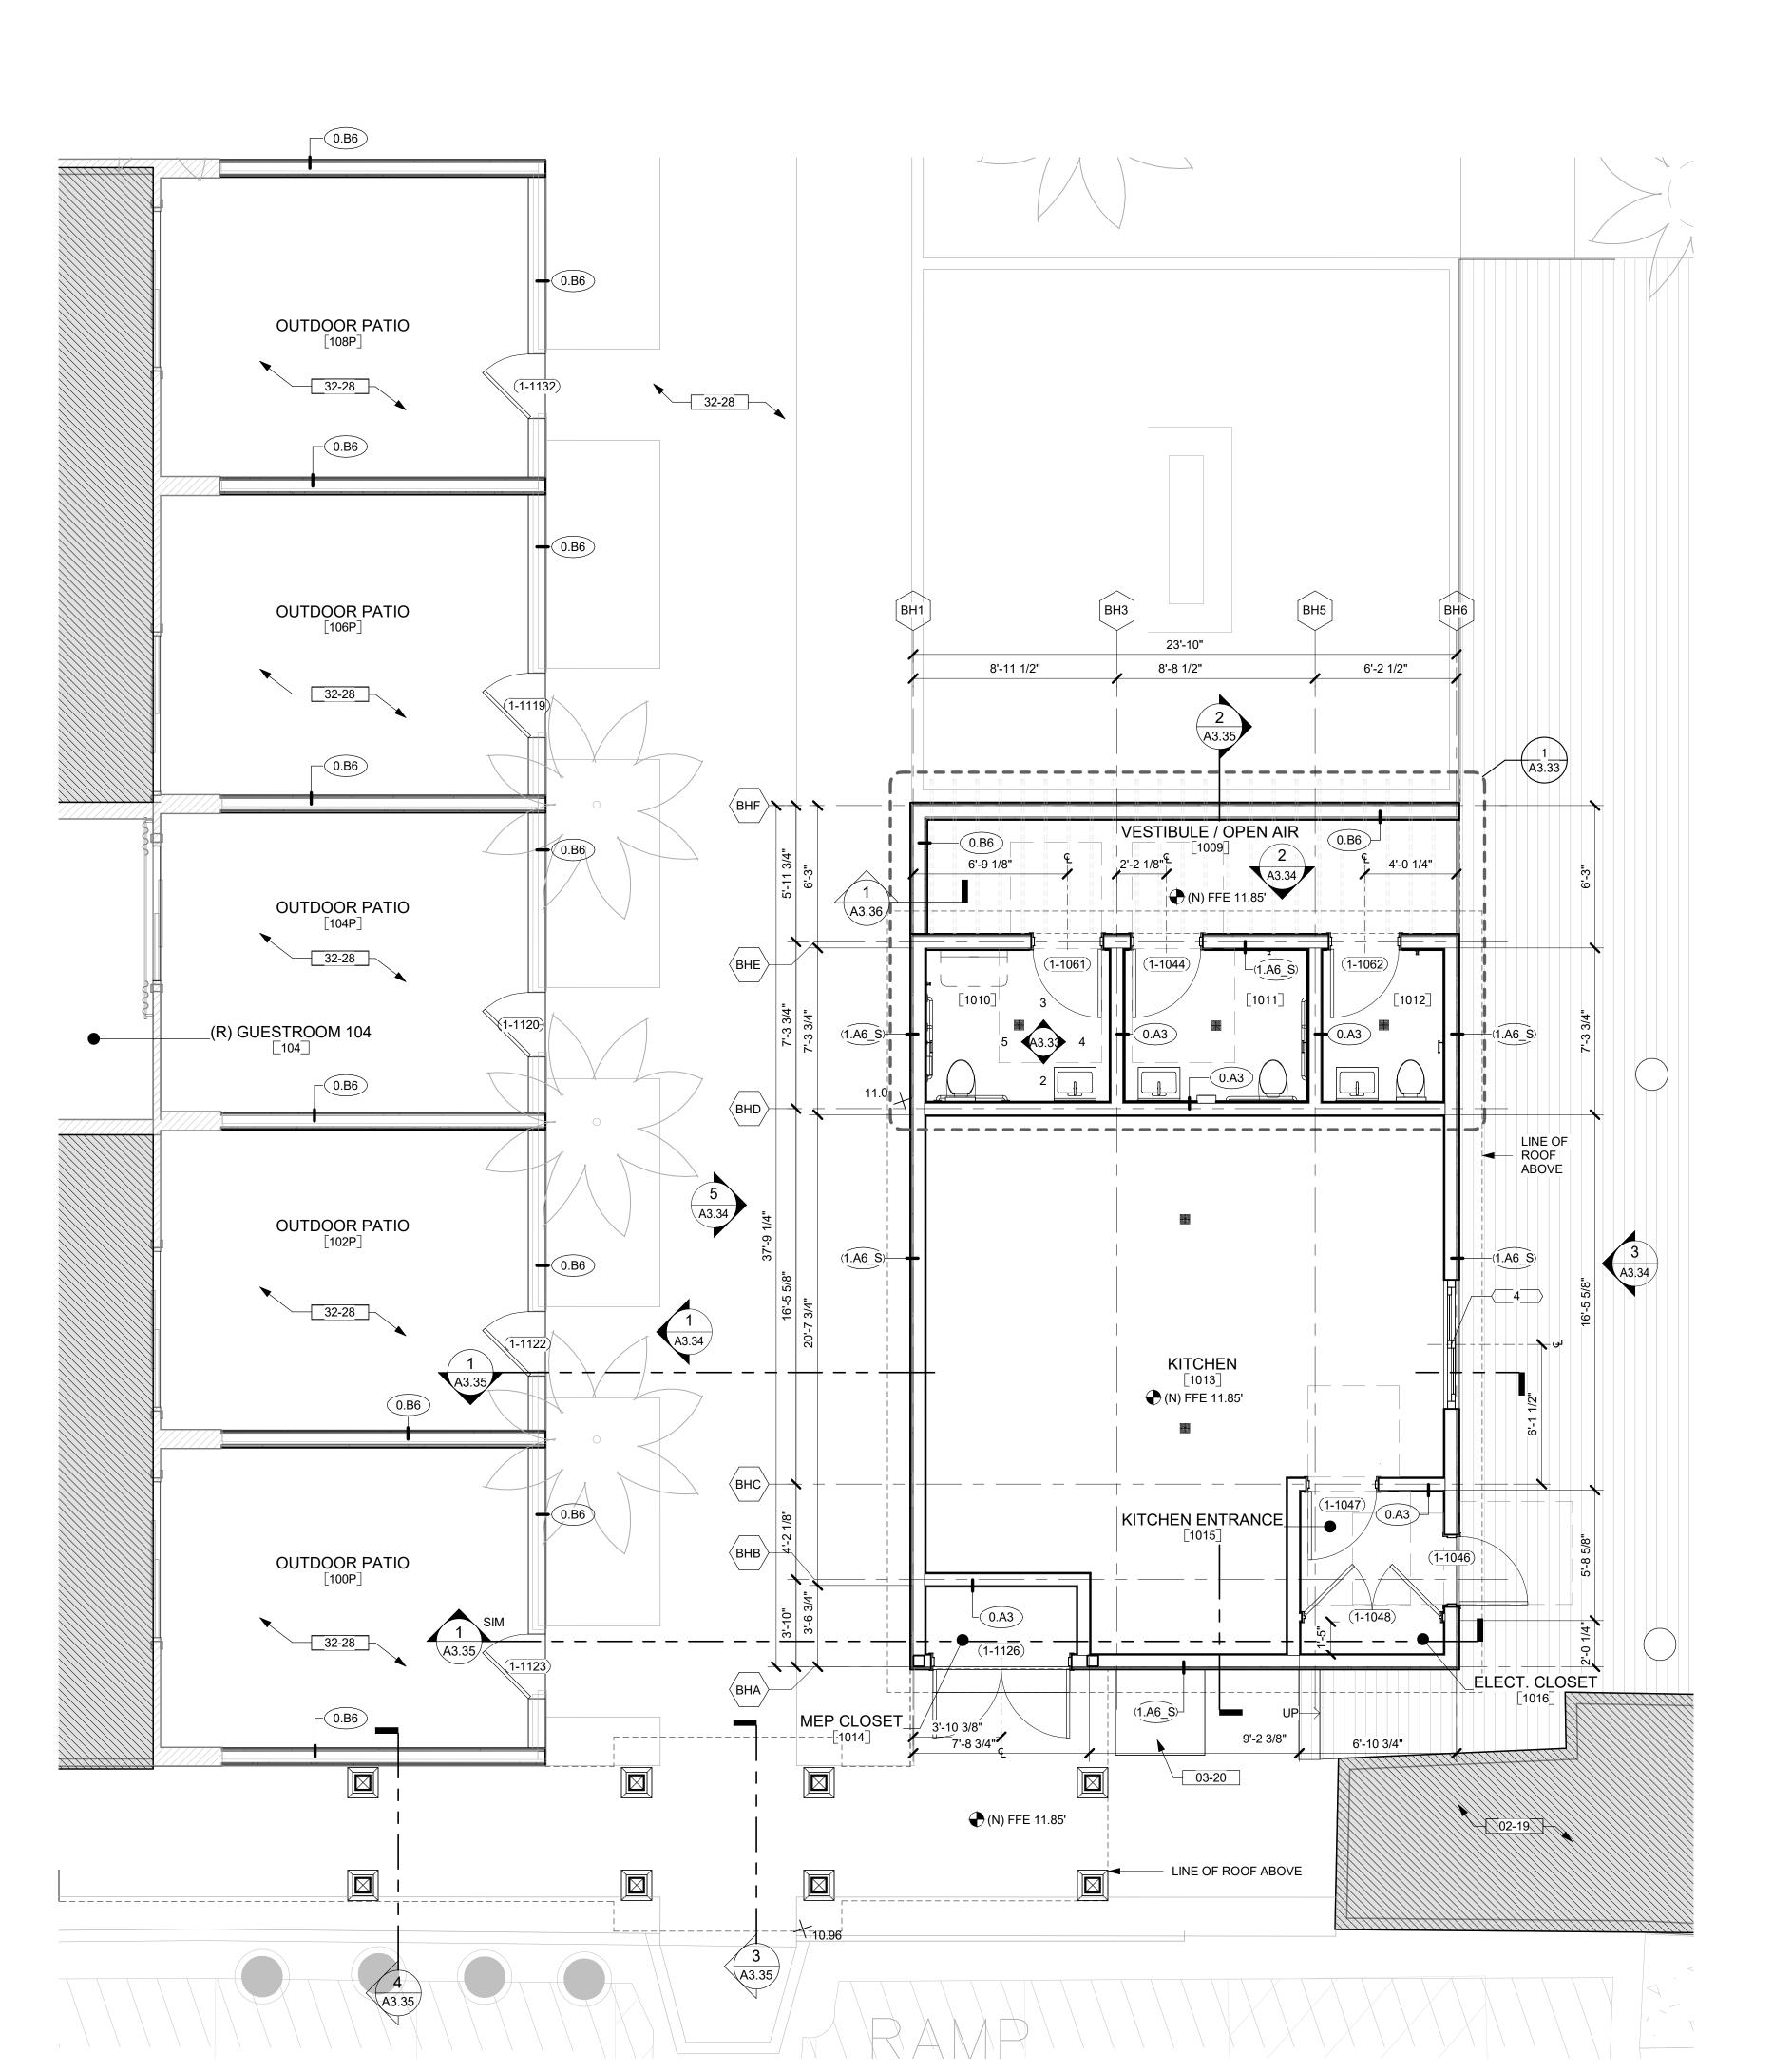
1/4" = 1'-0"



SCALE 1/4" = 1'-0" U.N.O.

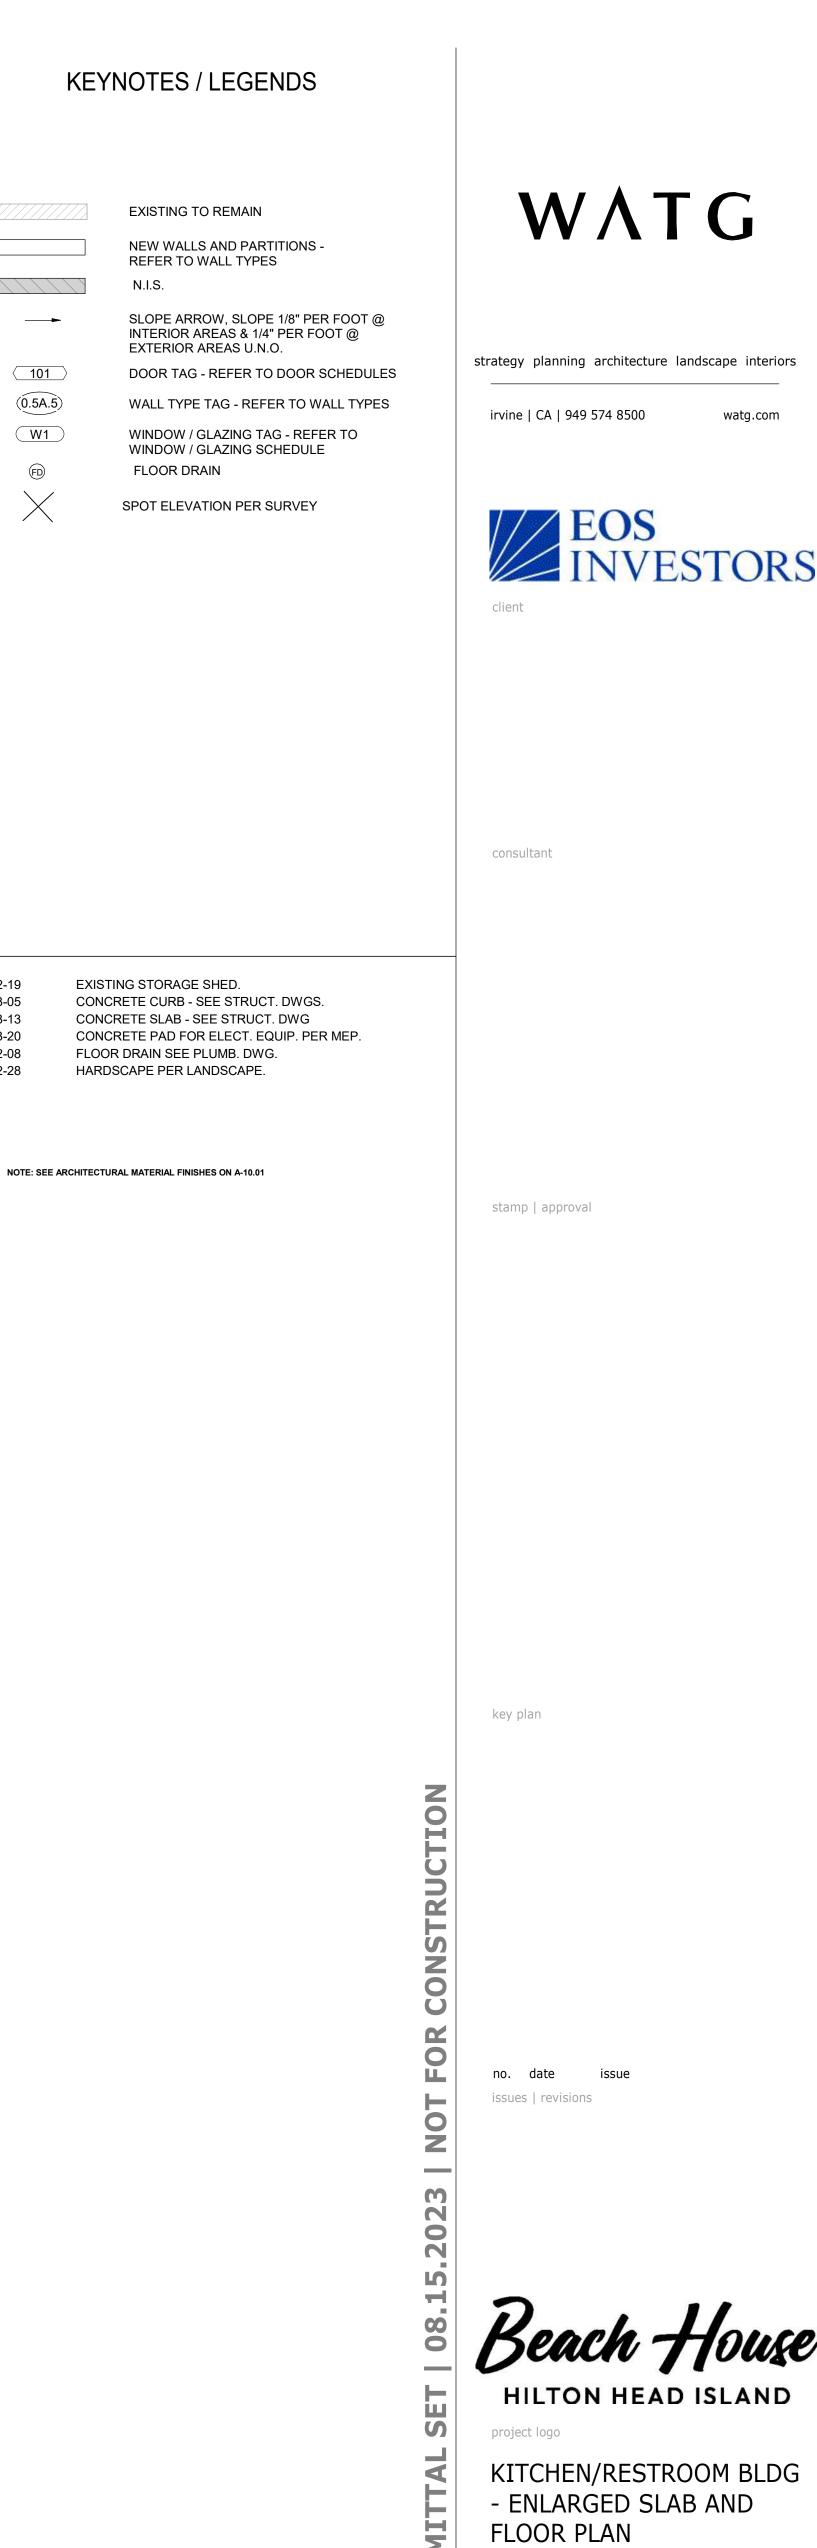


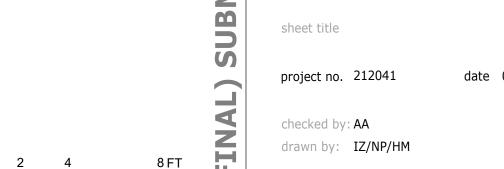

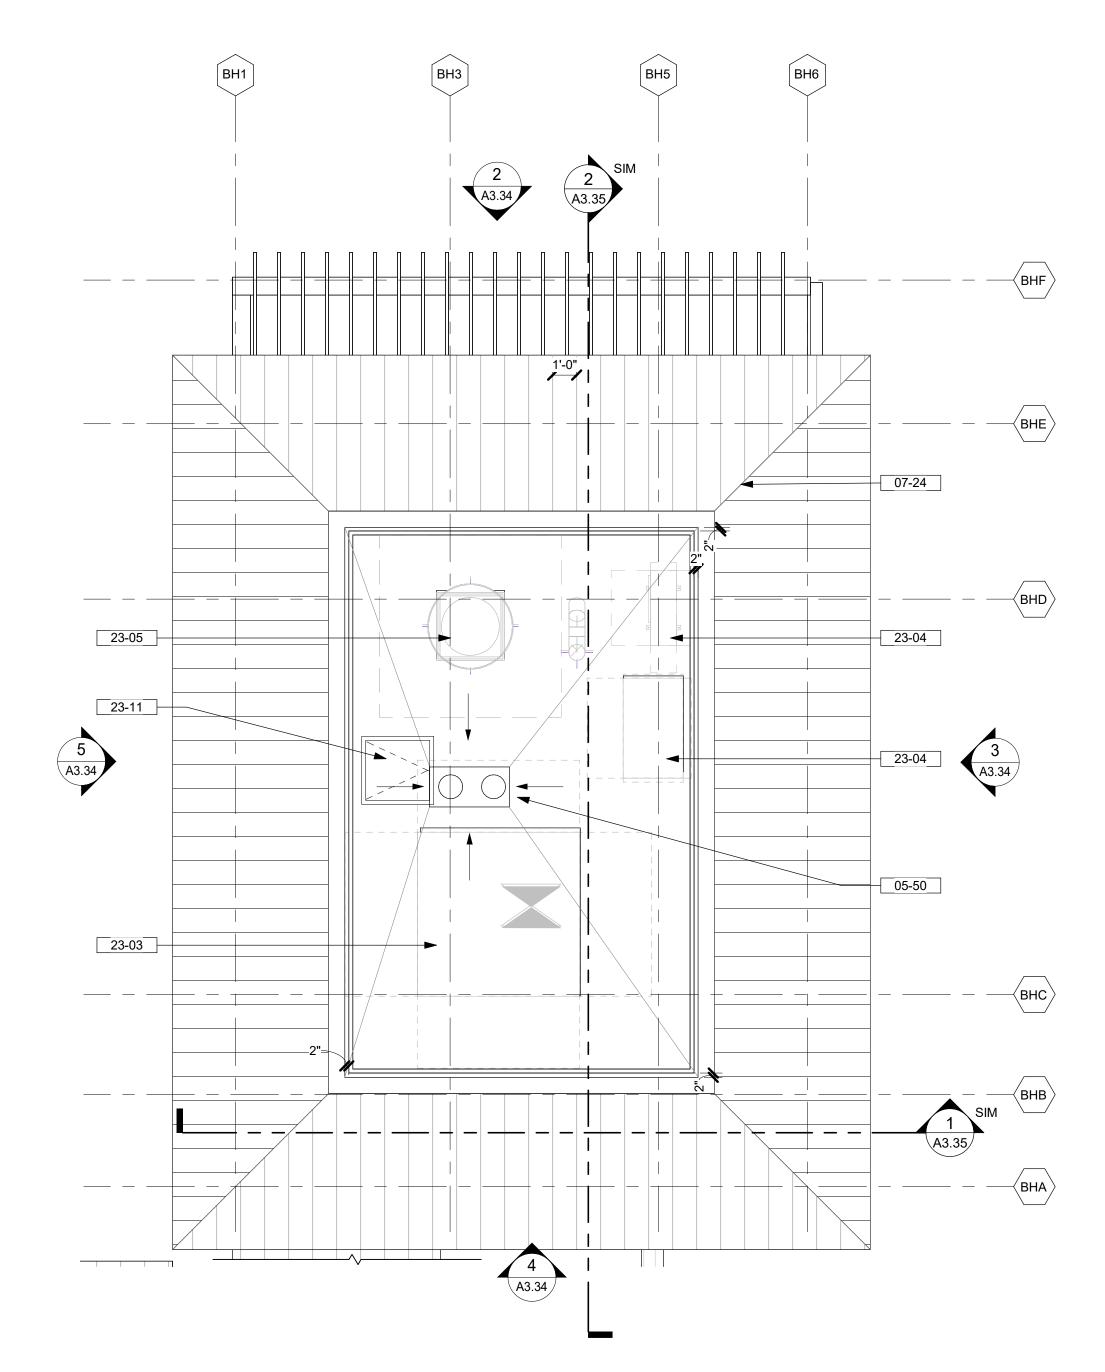


2 KITCHEN/RESTROOM BLDG - ENLARGED ROOF PLAN

1/4" = 1'-0"

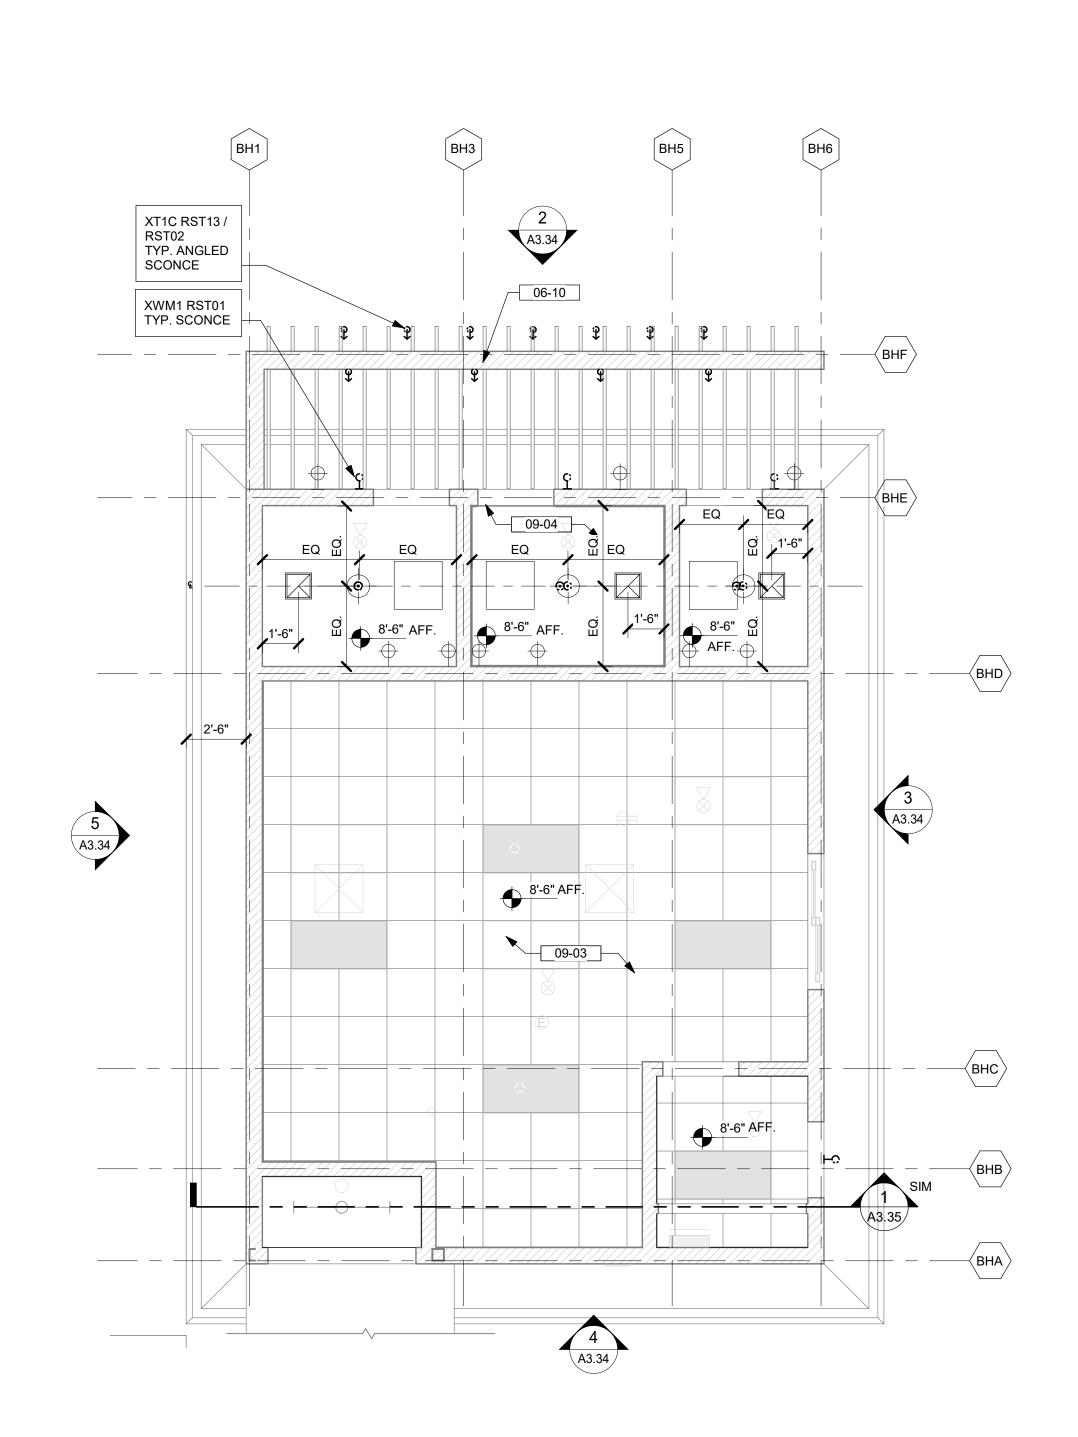

1 KITCHEN/RESTROOM BLDG - ENLARGED RCP

1/4" = 1'-0"

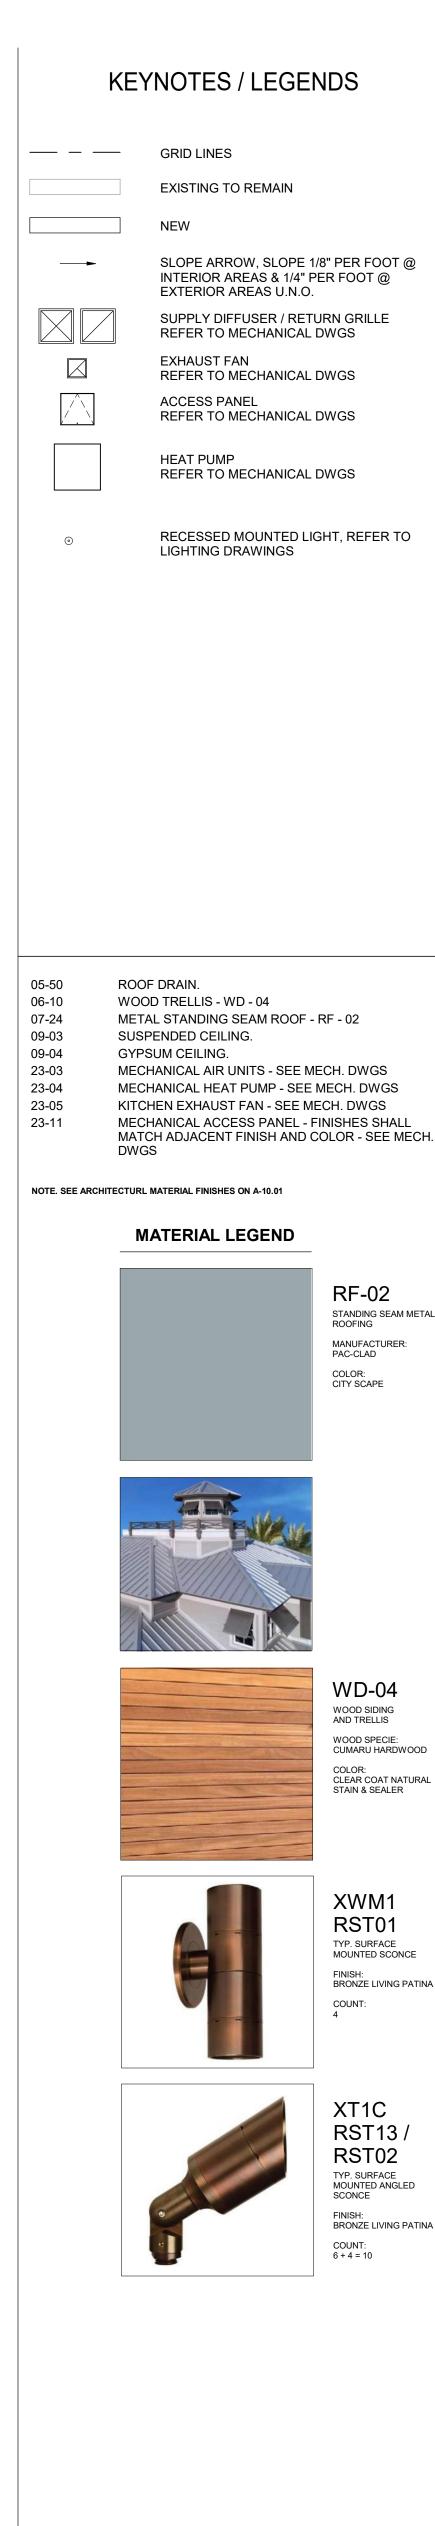

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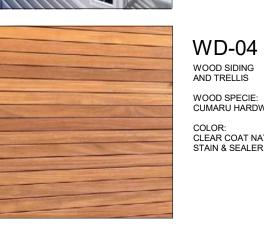
consultant

stamp | approval

key plan

METAL STANDING SEAM ROOF - RF - 02 MECHANICAL AIR UNITS - SEE MECH. DWGS MECHANICAL HEAT PUMP - SEE MECH. DWGS

RF-02 STANDING SEAM METAL ROOFING



WOOD SIDING AND TRELLIS WOOD SPECIE: CUMARU HARDWOOD COLOR: CLEAR COAT NATURAL STAIN & SEALER

XWM1 RST01 TYP. SURFACE MOUNTED SCONCE


SCALE 1/4" = 1'-0" U.N.O.

FINISH: BRONZE LIVING PATINA



KITCHEN/RESTROOM BLDG - ENLARGED ROOF PLAN AND RCP

drawn by: IZ/NP/HM

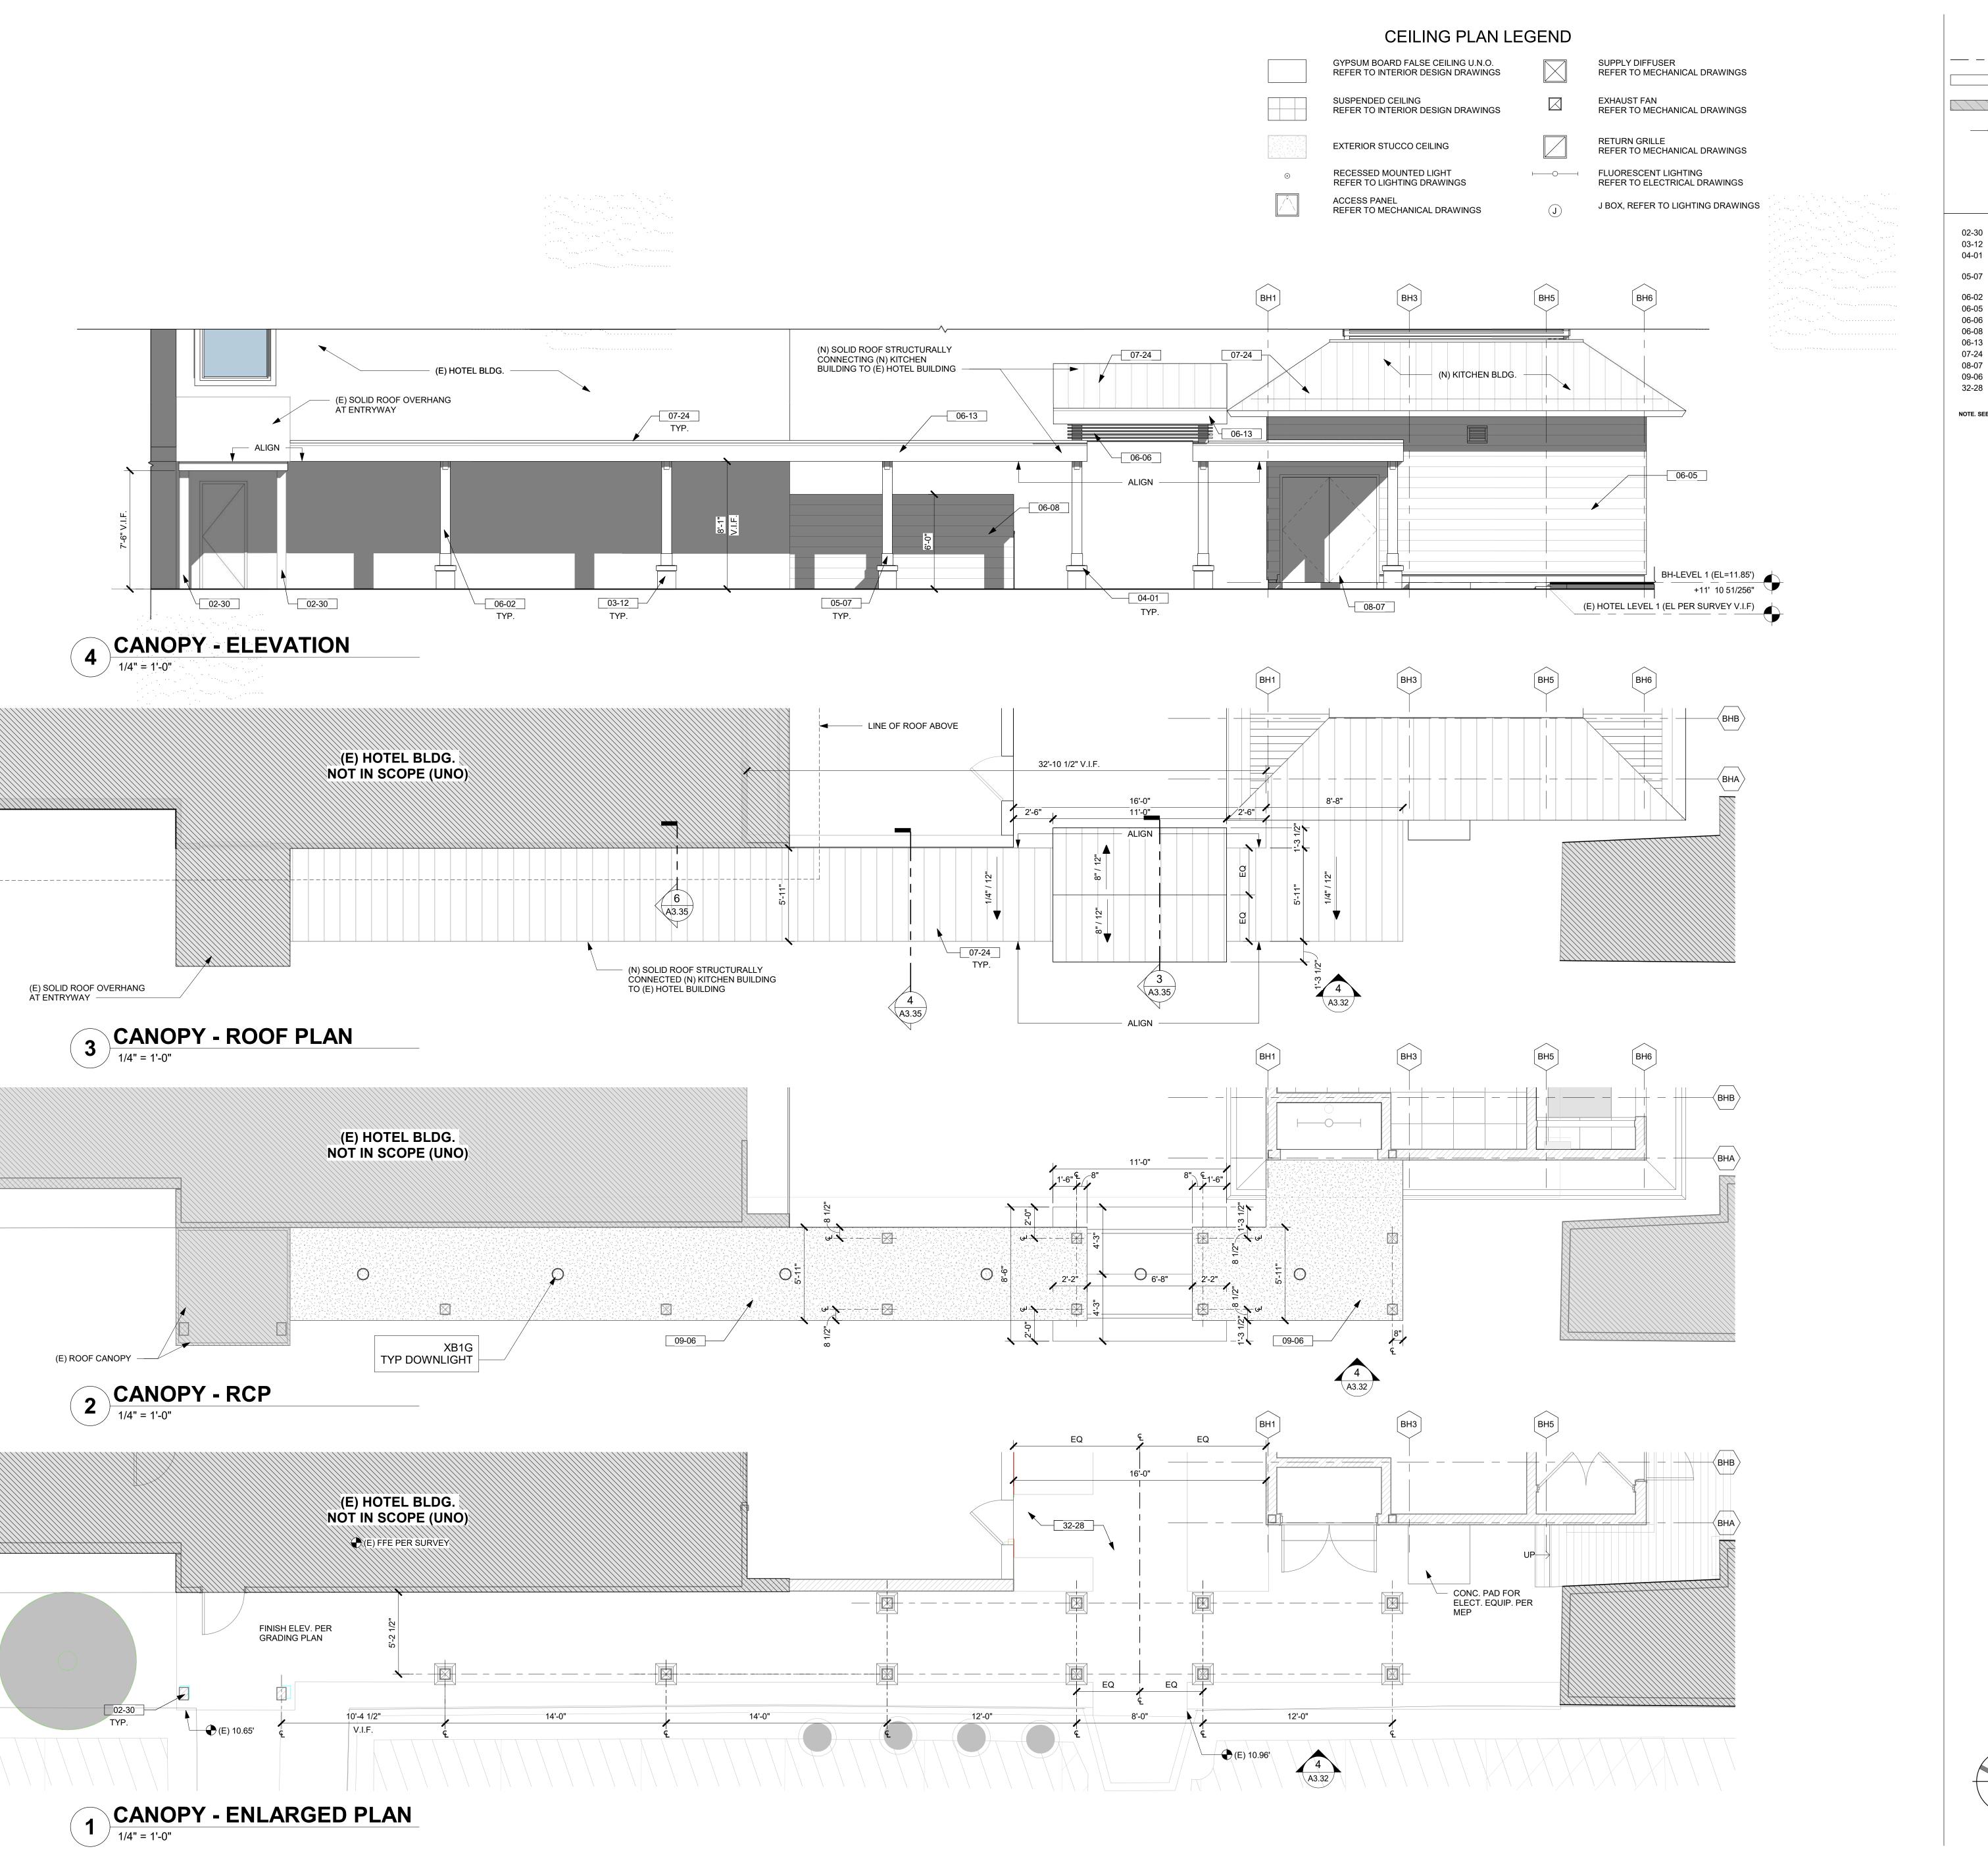

— — — GRID LINES

SLOPE ARROW, SLOPE 1/8" PER FOOT @

INTERIOR AREAS & 1/4" PER FOOT @ EXTERIOR AREAS U.N.O.

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key plan

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INVESTORS

EXISTING COLUMN TO REMAIN. TABBY PLASTER FINISH PILASTER - STU - 01 NATURAL LIMESTONE CAP TO MATCH TABBY PLASTER STEEL CONNECTIONS TO WOOD MEMBERS - SEE

STRUCT. - MTL-01 WOOD COLUMN - SEE STRUCT. DWGS - WD - 01 WOOD SIDING - WD - 04 06-06 WOOD LOUVER - WD - 05 06-08 WOOD FASCIA - PT - 01

KEYNOTES / LEGENDS

WOOD FASCIA - PT - 02 METAL STANDING SEAM ROOF - RF - 02 DOOR - SEE PLAN & SCHEDULE. - PT - 01 EXTERIOR STUCCO CLG. - PAINT - PT - 02 HARDSCAPE PER LANDSCAPE.

NOTE. SEE ARCHITECTURAL MATERIAL FINISHES ON A-10.01

MATERIAL LEGEND



STU-01 TABBY SHELL STUCCO LIGHT. TAN EARTH TONE

WD-01

NEW WOOD COLUMN / BEAMS, FASCIA AND LOUVERS / T&G CEILING

WOOD SPECIE: SOUTHERN YELLOW PINE - SMOOTH FINISH

PENETRATING SEMI-



TRANSPARENT STAIN & SEALER SAMPLE COLOR: VALSPER - MONTICELLO TAN RF-02 STANDING SEAM METAL ROOFING





WD-04 WOOD SIDING AND TRELLIS WOOD SPECIE: CUMARU HARDWOOD COLOR: CLEAR COAT NATURAL STAIN & SEALER












STN-01 STONE CAP NATURAL LIMESTONE COLOR: NATURAL HONED FINISH TO MATCH TABBY PLASTER



CANOPY - ENLARGED ROOF PLAN & RCP

drawn by: IZ/NP/HM

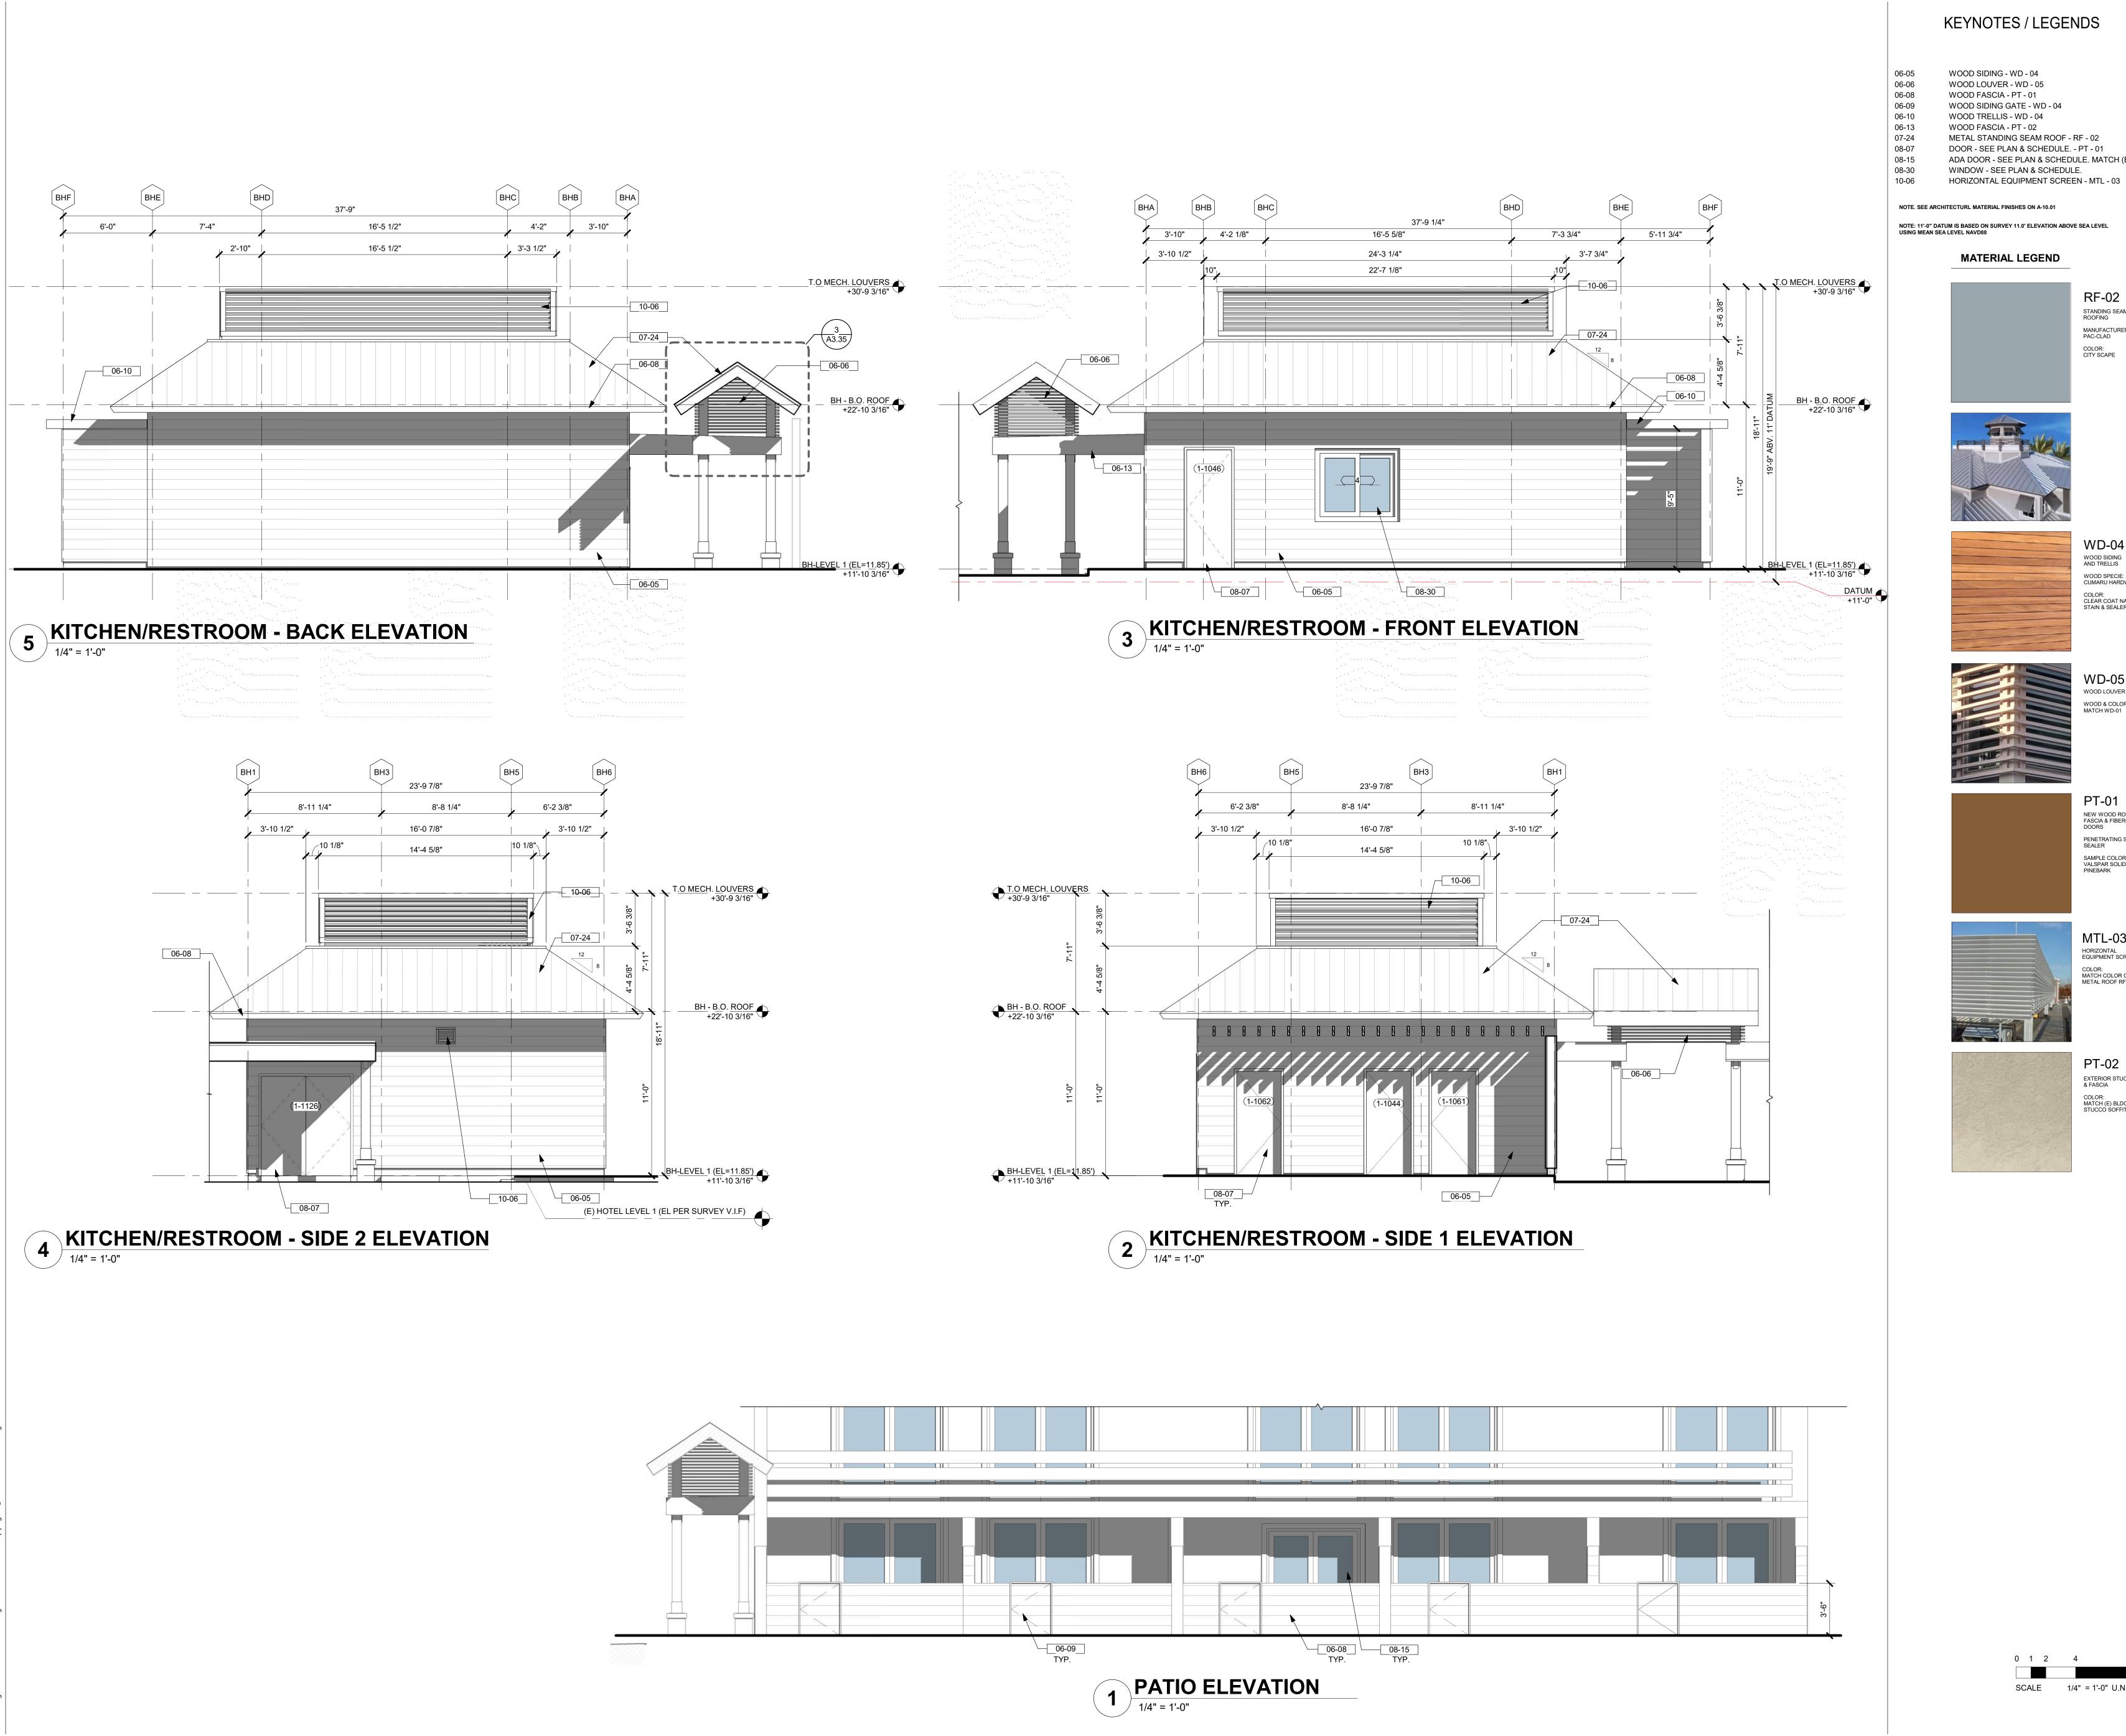


WOOD LOUVER - WD - 05 WOOD FASCIA - PT - 01 WOOD SIDING GATE - WD - 04 WOOD TRELLIS - WD - 04 WOOD FASCIA - PT - 02 METAL STANDING SEAM ROOF - RF - 02 DOOR - SEE PLAN & SCHEDULE. - PT - 01 ADA DOOR - SEE PLAN & SCHEDULE. MATCH (E) WINDOW - SEE PLAN & SCHEDULE.

NOTE. SEE ARCHITECTURL MATERIAL FINISHES ON A-10.01

NOTE: 11'-0" DATUM IS BASED ON SURVEY 11.0' ELEVATION ABOVE SEA LEVEL USING MEAN SEA LEVEL NAVD88

## **MATERIAL LEGEND**

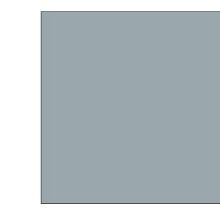

RF-02 STANDING SEAM METAL ROOFING MANUFACTURER: PAC-CLAD COLOR: CITY SCAPE











MTL-03 HORIZONTAL EQUIPMENT SCREEN COLOR: MATCH COLOR OF METAL ROOF RF-02



0 1 2 4

SCALE 1/4" = 1'-0" U.N.O.

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PT-02 EXTERIOR STUCCO CLG. & FASCIA


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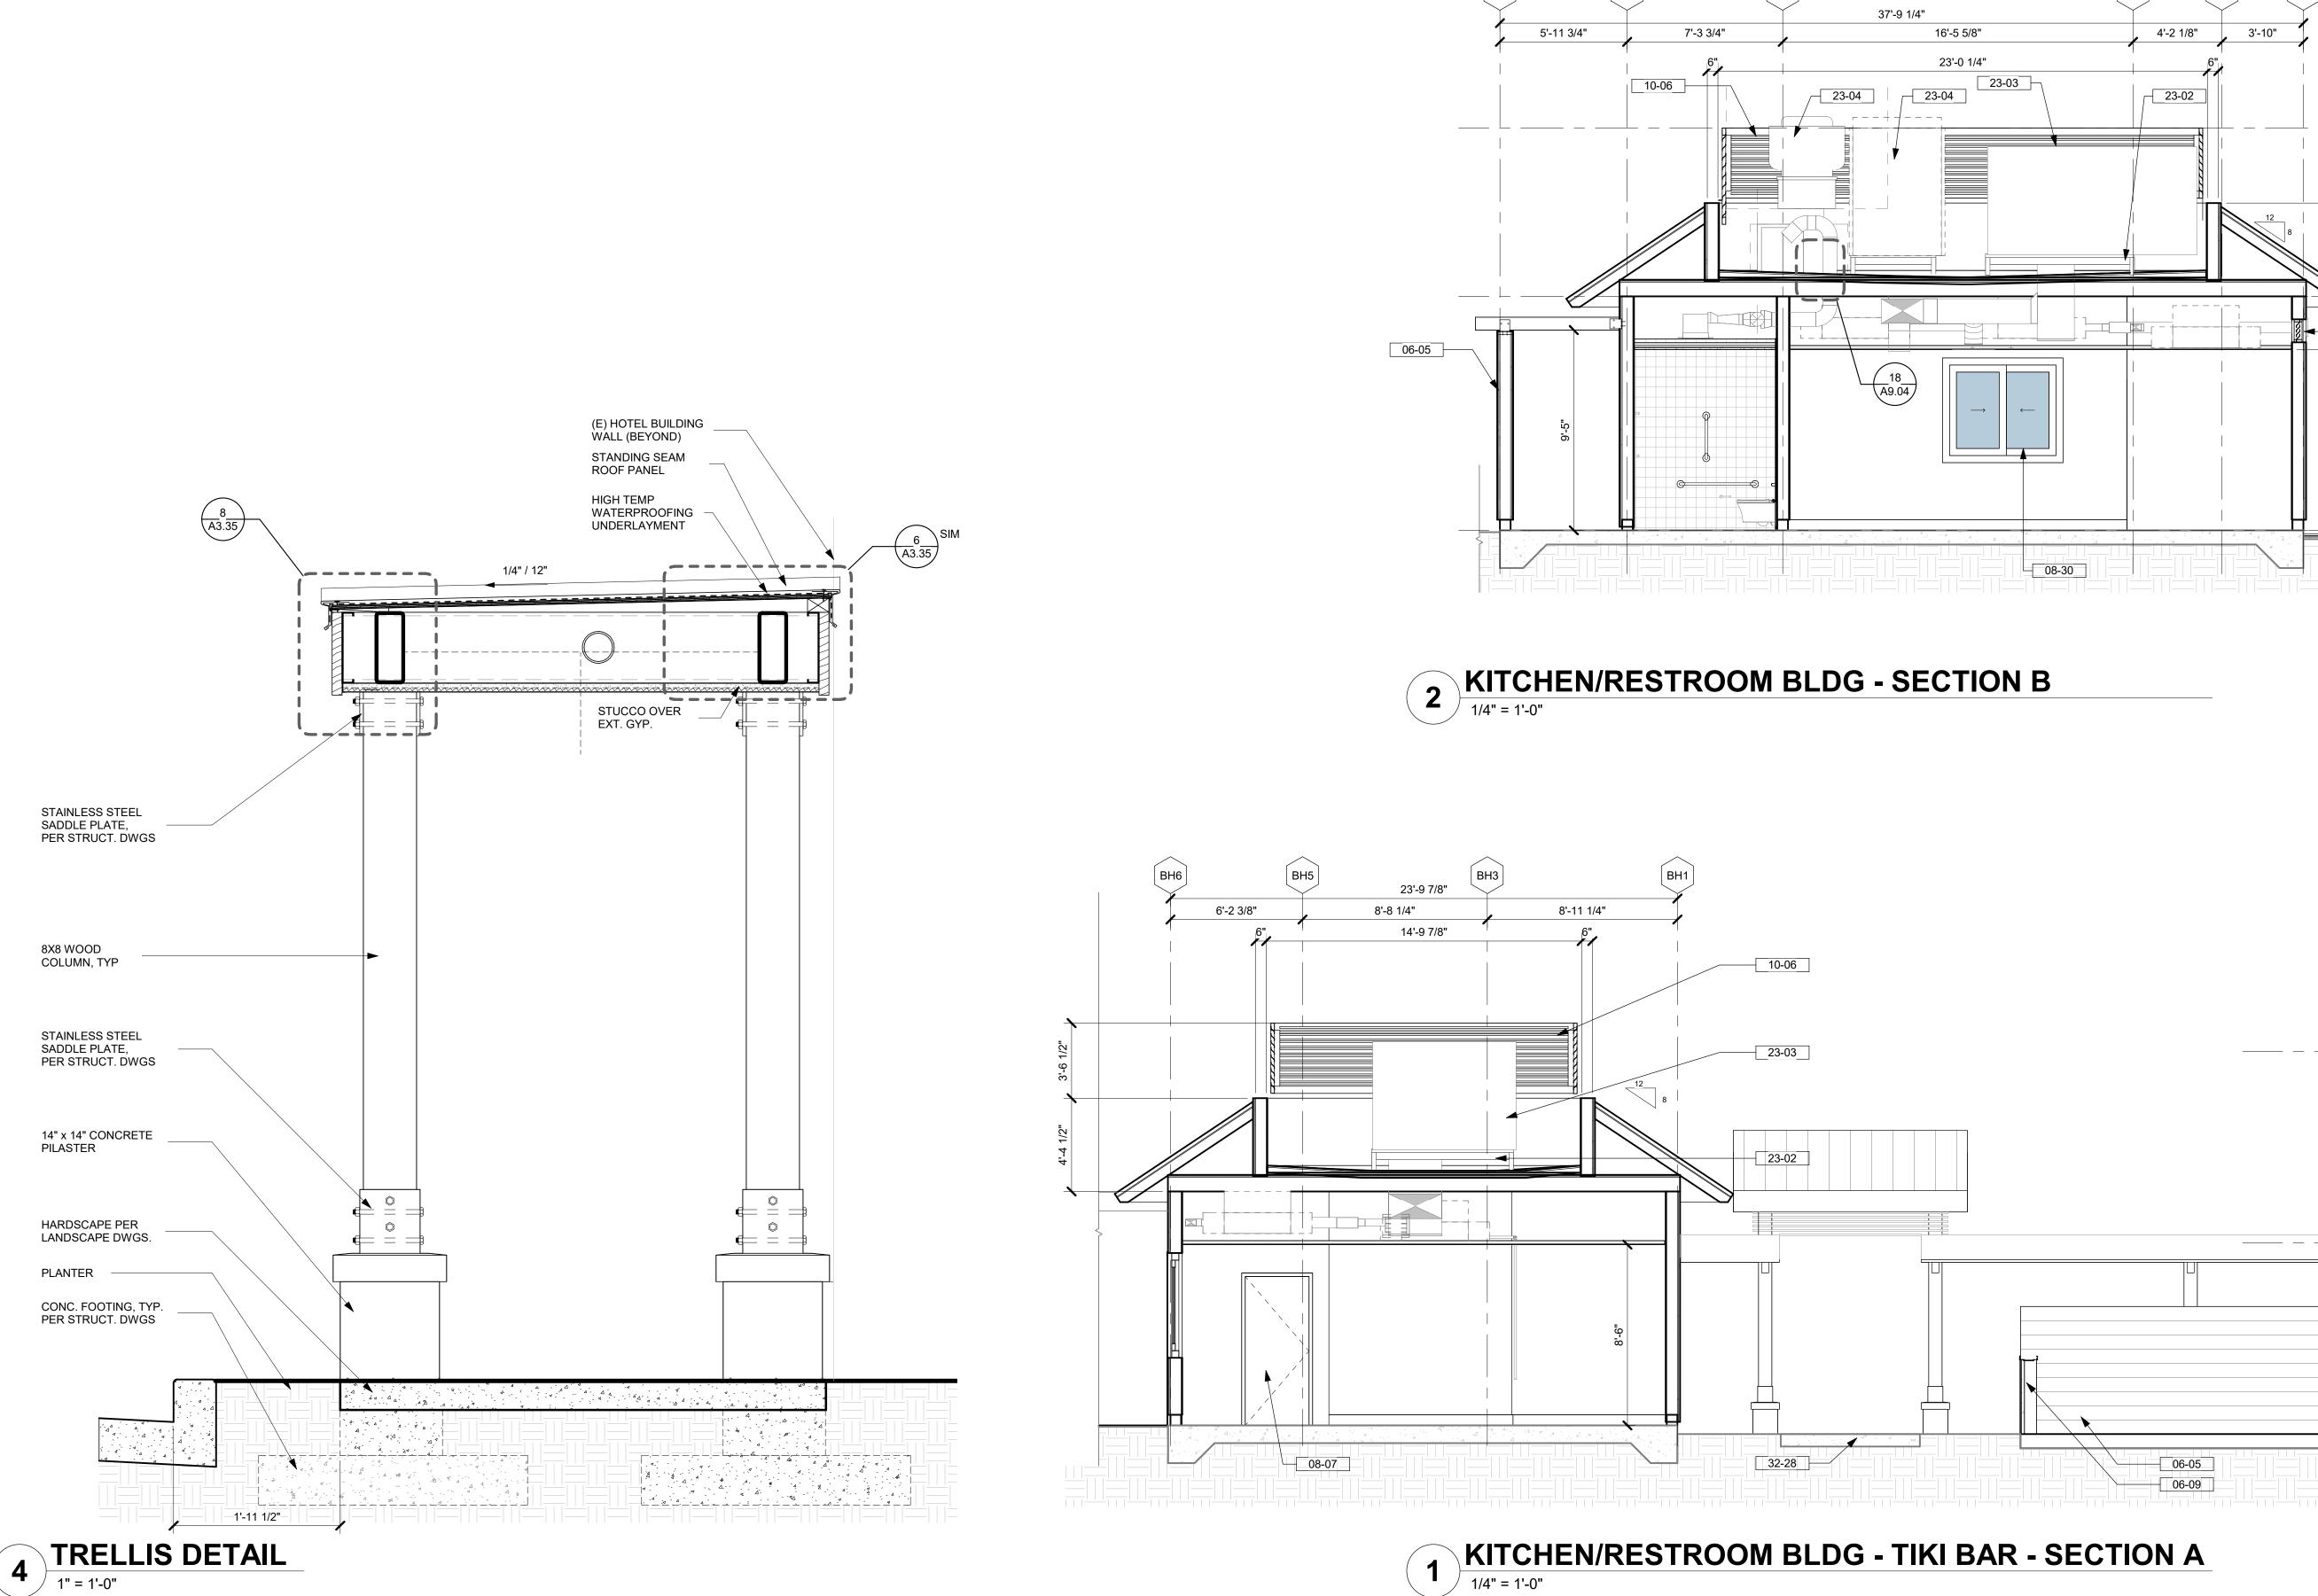
issues | revisions


KITCHEN/RESTROOM BLDG - ELEVATIONS

drawn by: IZ/NP/HM

sheet no.



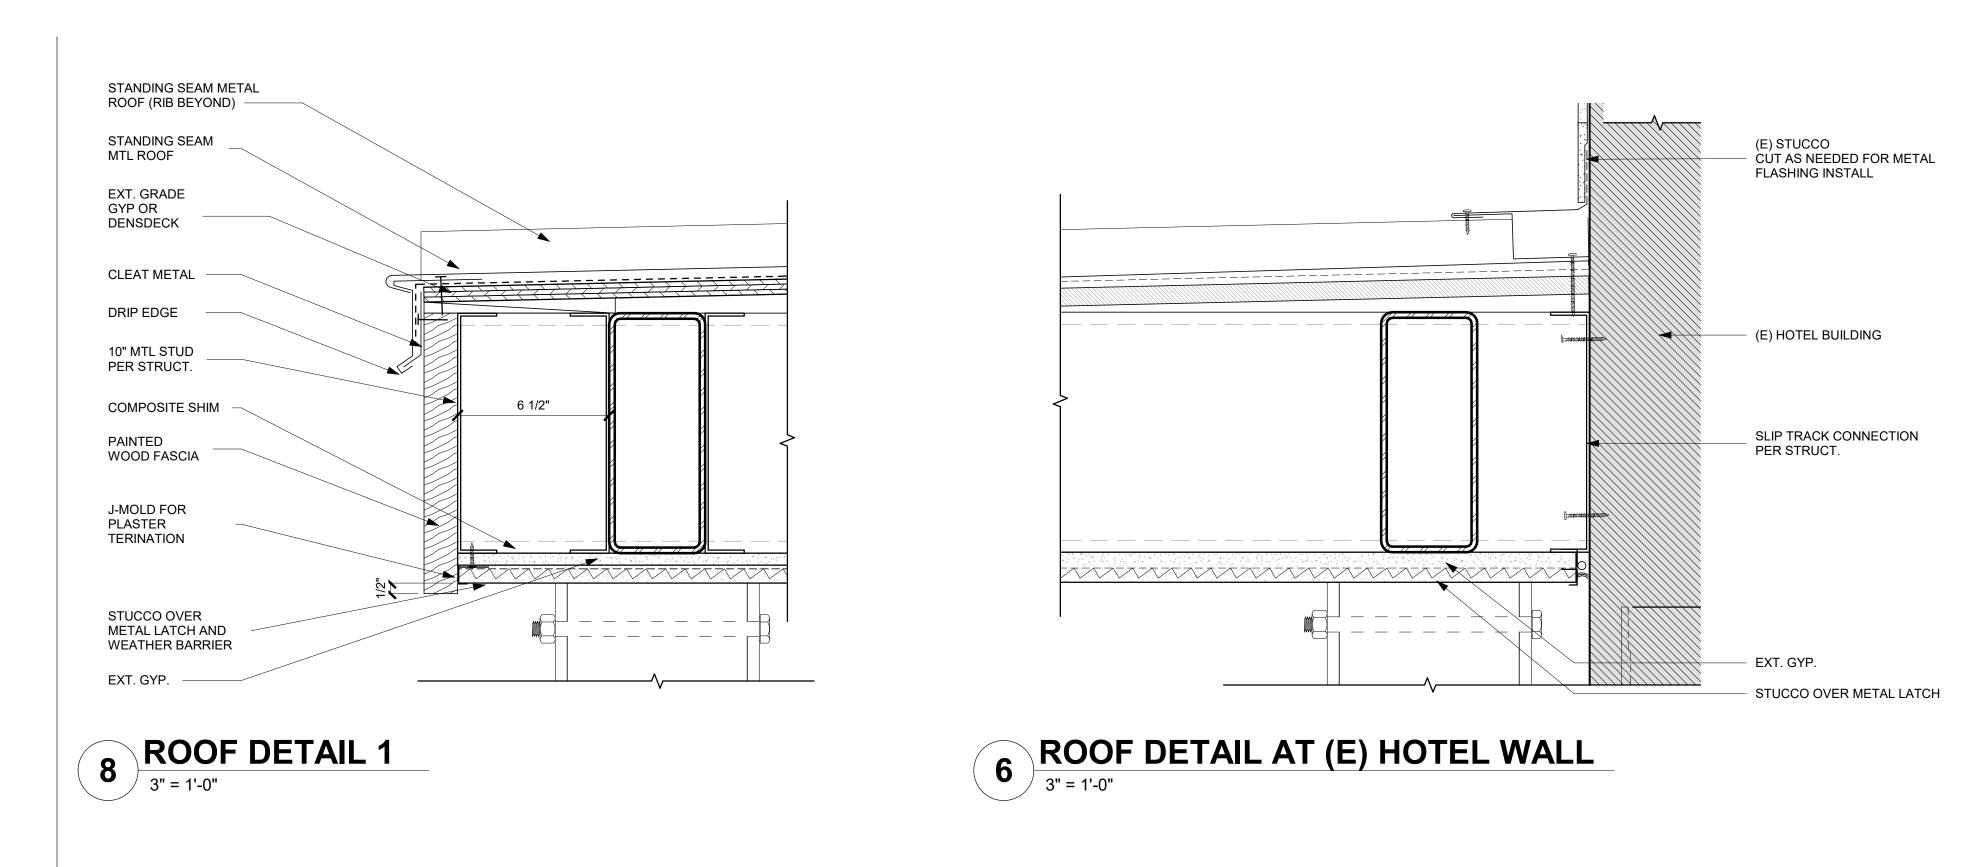

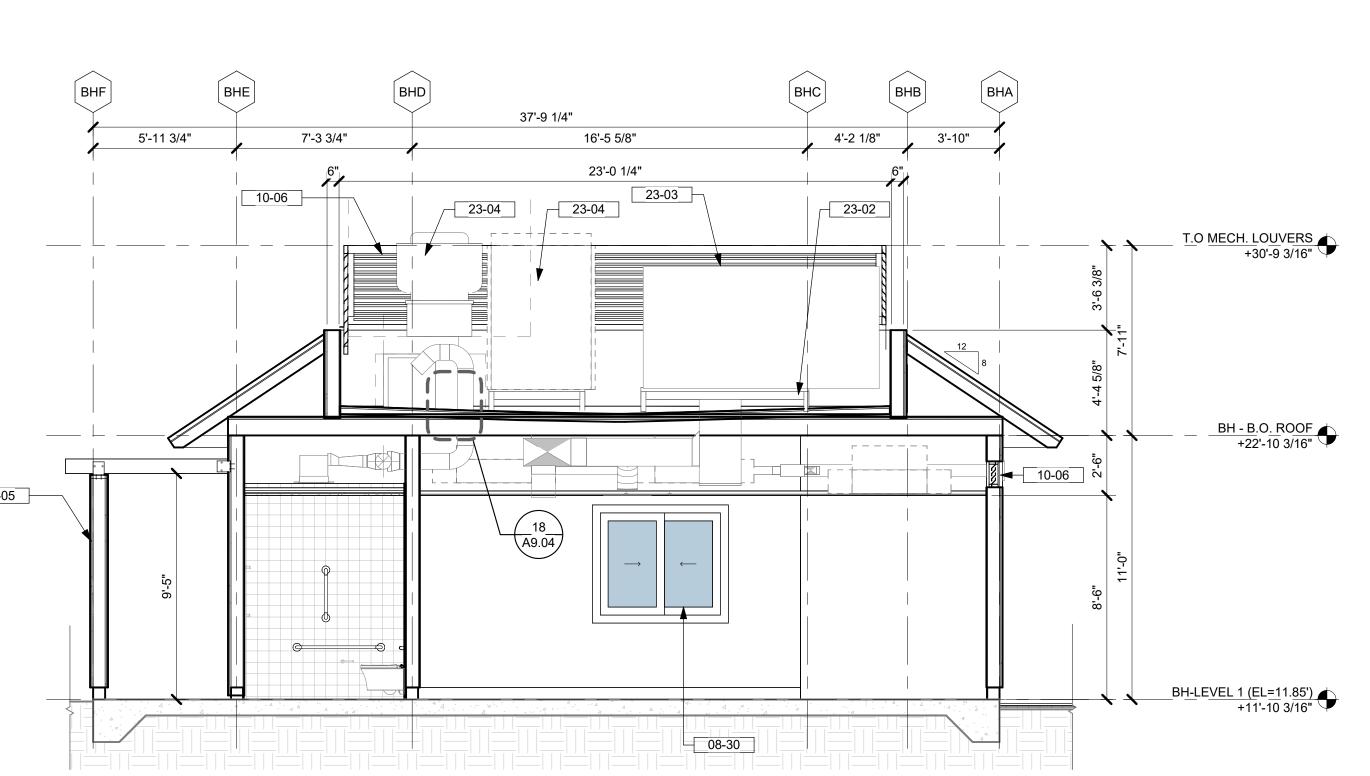



NOTE: 11'-0" DATUM IS BASED ON SURVEY 11.0' ELEVATION ABOVE SEA LEVEL USING MEAN SEA LEVEL NAVD88

WOOD SIDING - WD - 04 WOOD SIDING GATE - WD - 04 DOOR - SEE PLAN & SCHEDULE. - PT - 01 WINDOW - SEE PLAN & SCHEDULE. HORIZONTAL EQUIPMENT SCREEN - MTL - 03 23-02 MECHANICAL PLATFORM. MECHANICAL AIR UNITS - SEE MECH. DWGS MECHANICAL HEAT PUMP - SEE MECH. DWGS


HARDSCAPE PER LANDSCAPE.

NOTE. SEE ARCHITECTURL MATERIAL FINISHES ON A-10.01

## **MATERIAL LEGEND**





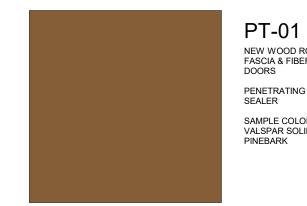

**EXISTING HOTEL** 

(E) HOTEL (PER SURVEY V.I.F)

LEVEL 2

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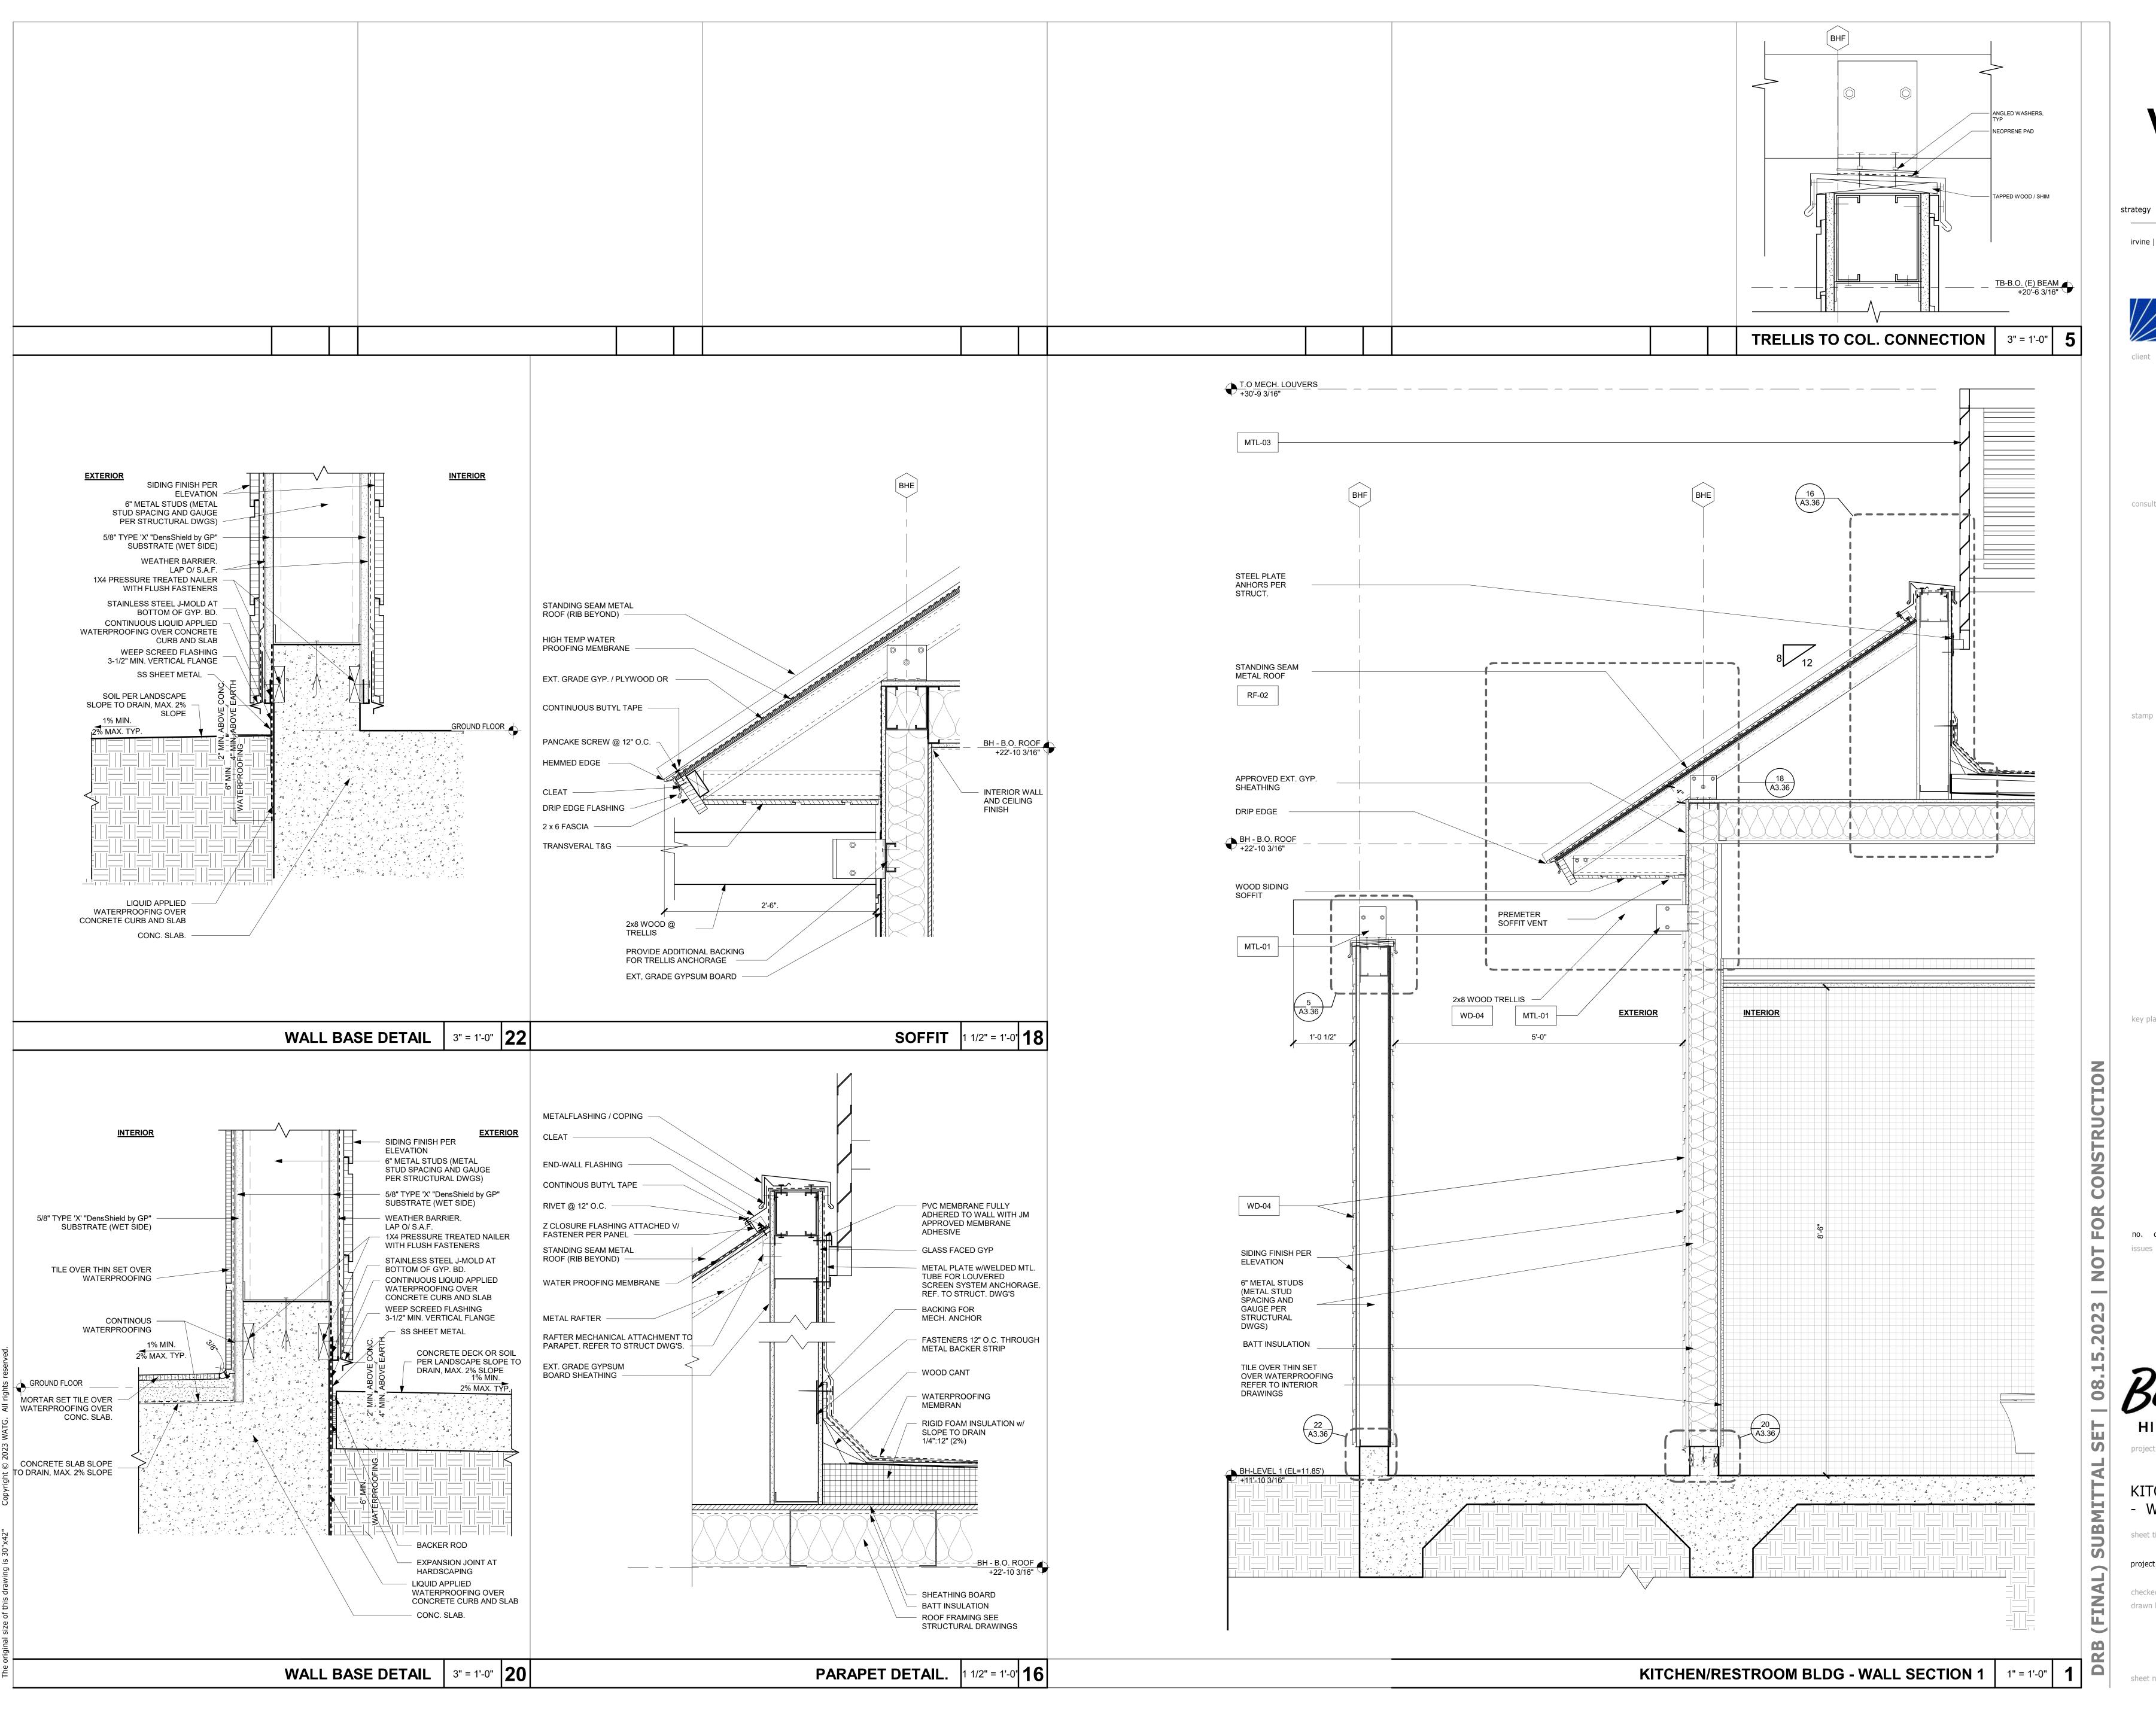
consultant

stamp | approval

NEW WOOD ROOF FASCIA & FIBERGLASS DOORS PENETRATING STAIN & SEALER SAMPLE COLOR: VALSPAR SOLID COLOR PINEBARK

key plan

issues | revisions



## WATG

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key plan

issues | revisions


project logo


KITCHEN/RESTROOM BLDG - WALL SECTION/DETAILS

project no. 212041 date 08/15/2023 checked by: AA drawn by: IZ/NP/HM

A3.36

component

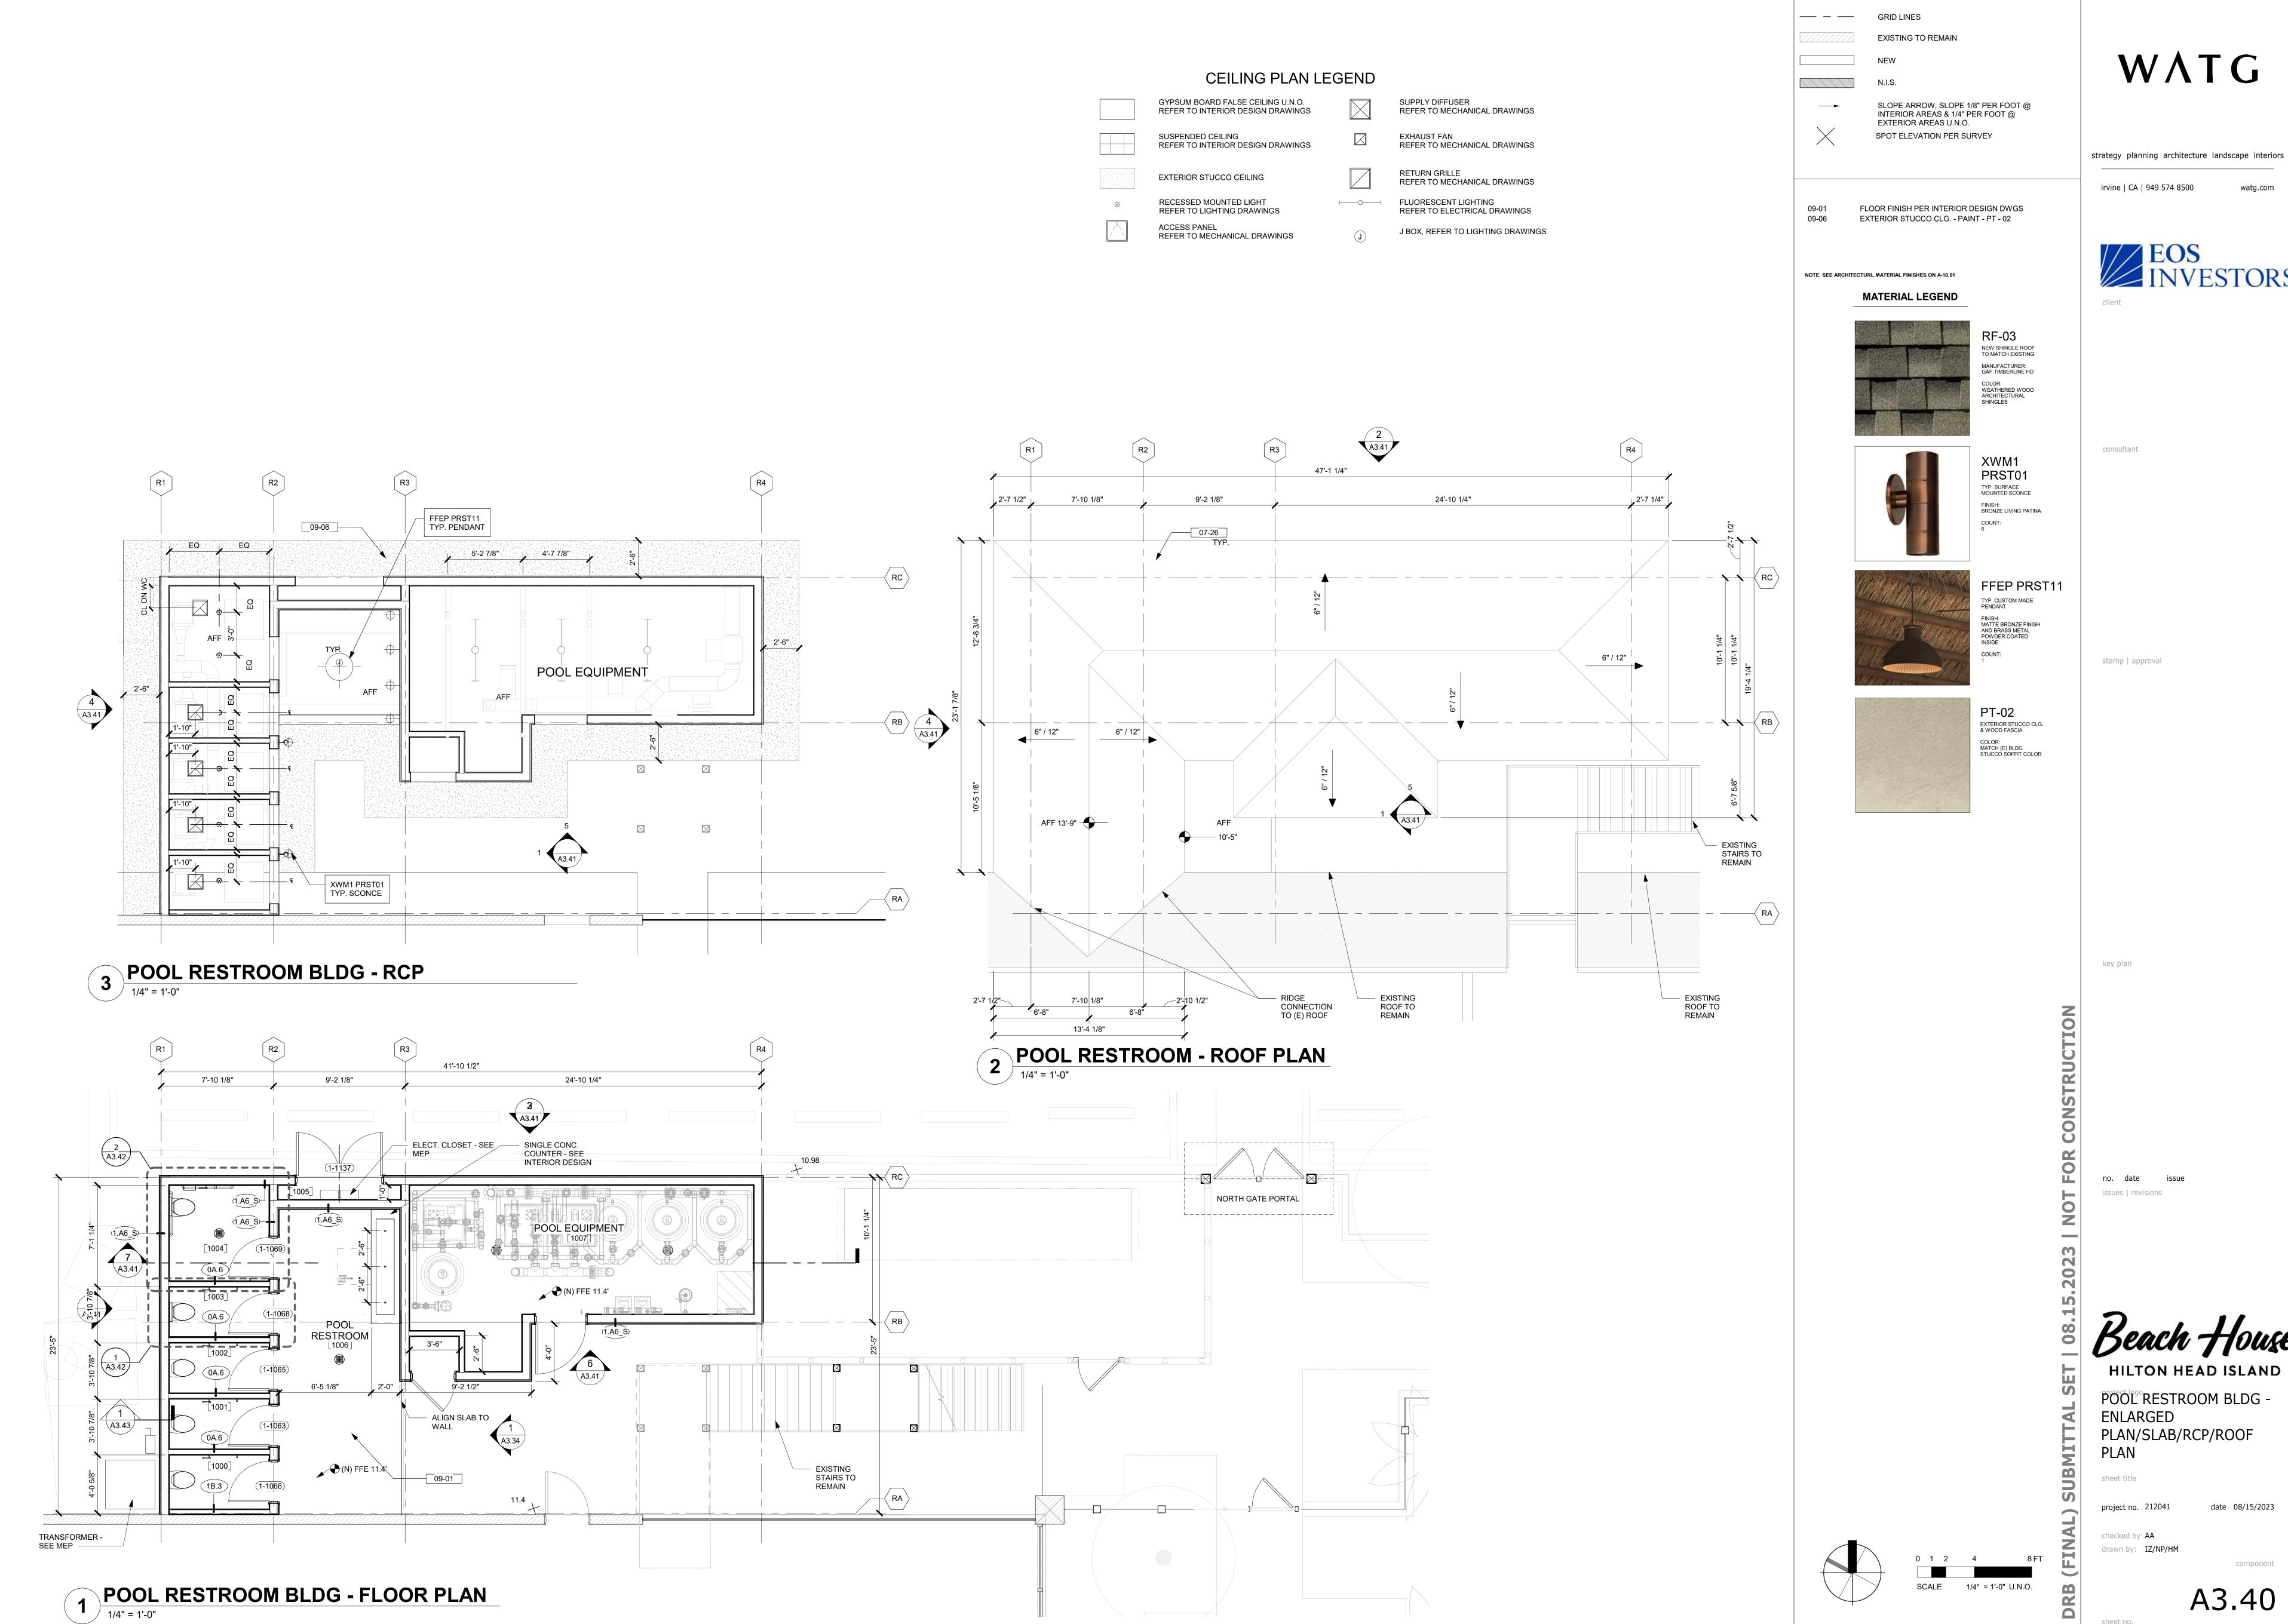

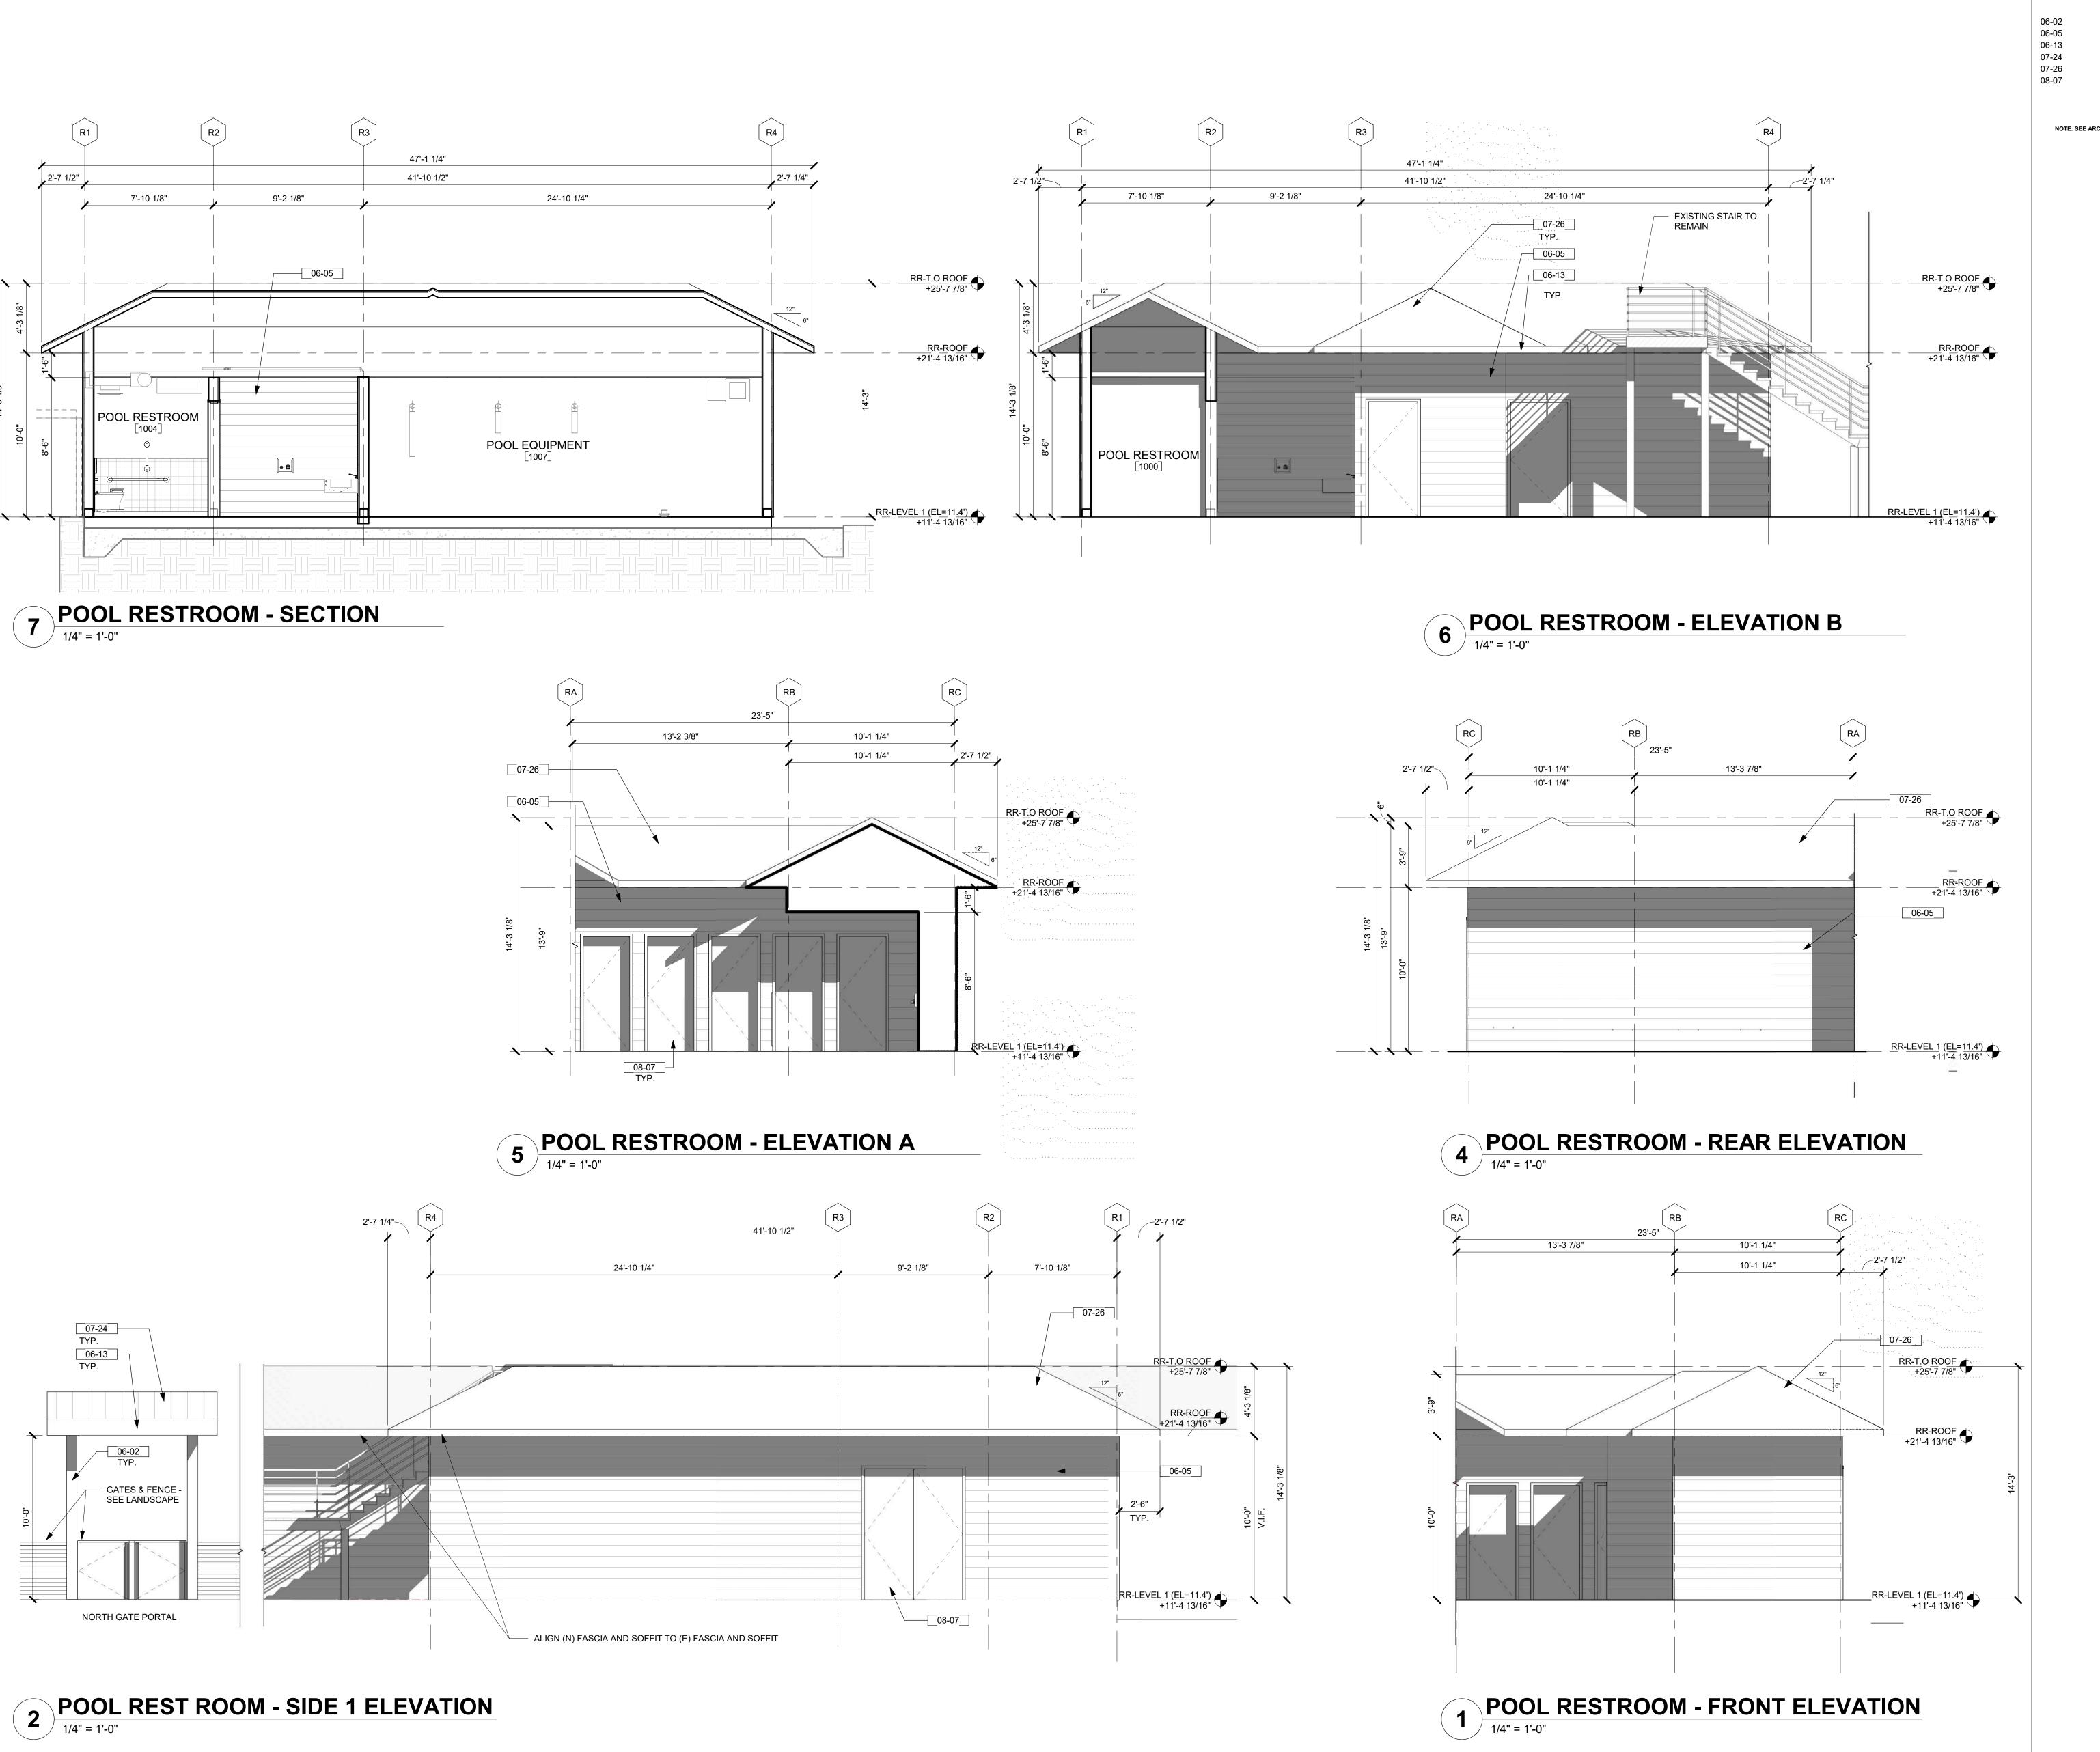

NOTE: 11'-0" DATUM IS BASED ON SURVEY 11.0' ELEVATION ABOVE SEA LEVEL USING MEAN SEA LEVEL NAVD88

WOOD COLUMN - SEE STRUCT. DWGS - WD - 01 WOOD SIDING - WD - 04 WOOD FASCIA - PT - 02 METAL STANDING SEAM ROOF - RF - 02 SHINGLE ROOF TO MATCH EXISTING - RF - 03 DOOR - SEE PLAN & SCHEDULE. - PT - 01


NOTE. SEE ARCHITECTURL MATERIAL FINISHES ON A-10.01

## MATERIAL LEGEND



NEW WOOD COLUMN / BEAMS, FASCIA AND LOUVERS / T&G CEILING WOOD SPECIE: SOUTHERN YELLOW PINE - SMOOTH FINISH PENETRATING SEMI-TRANSPARENT STAIN & SEALER SAMPLE COLOR: VALSPER - MONTICELLO TAN

WD-01

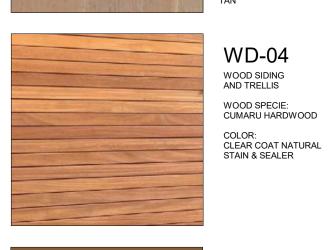





RF-03 NEW SHINGLE ROOF TO MATCH EXISTING MANUFACTURER: COLOR: WEATHERED WOOD ARCHITECTURAL SHINGLES



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consultant

stamp | approval

key plan


POOL RESTROOM BLDG -

**ELEVATION/SECTION** 

drawn by: IZ/NP/HM

A3.41

0 1 2 4 SCALE 1/4" = 1'-0" U.N.O.

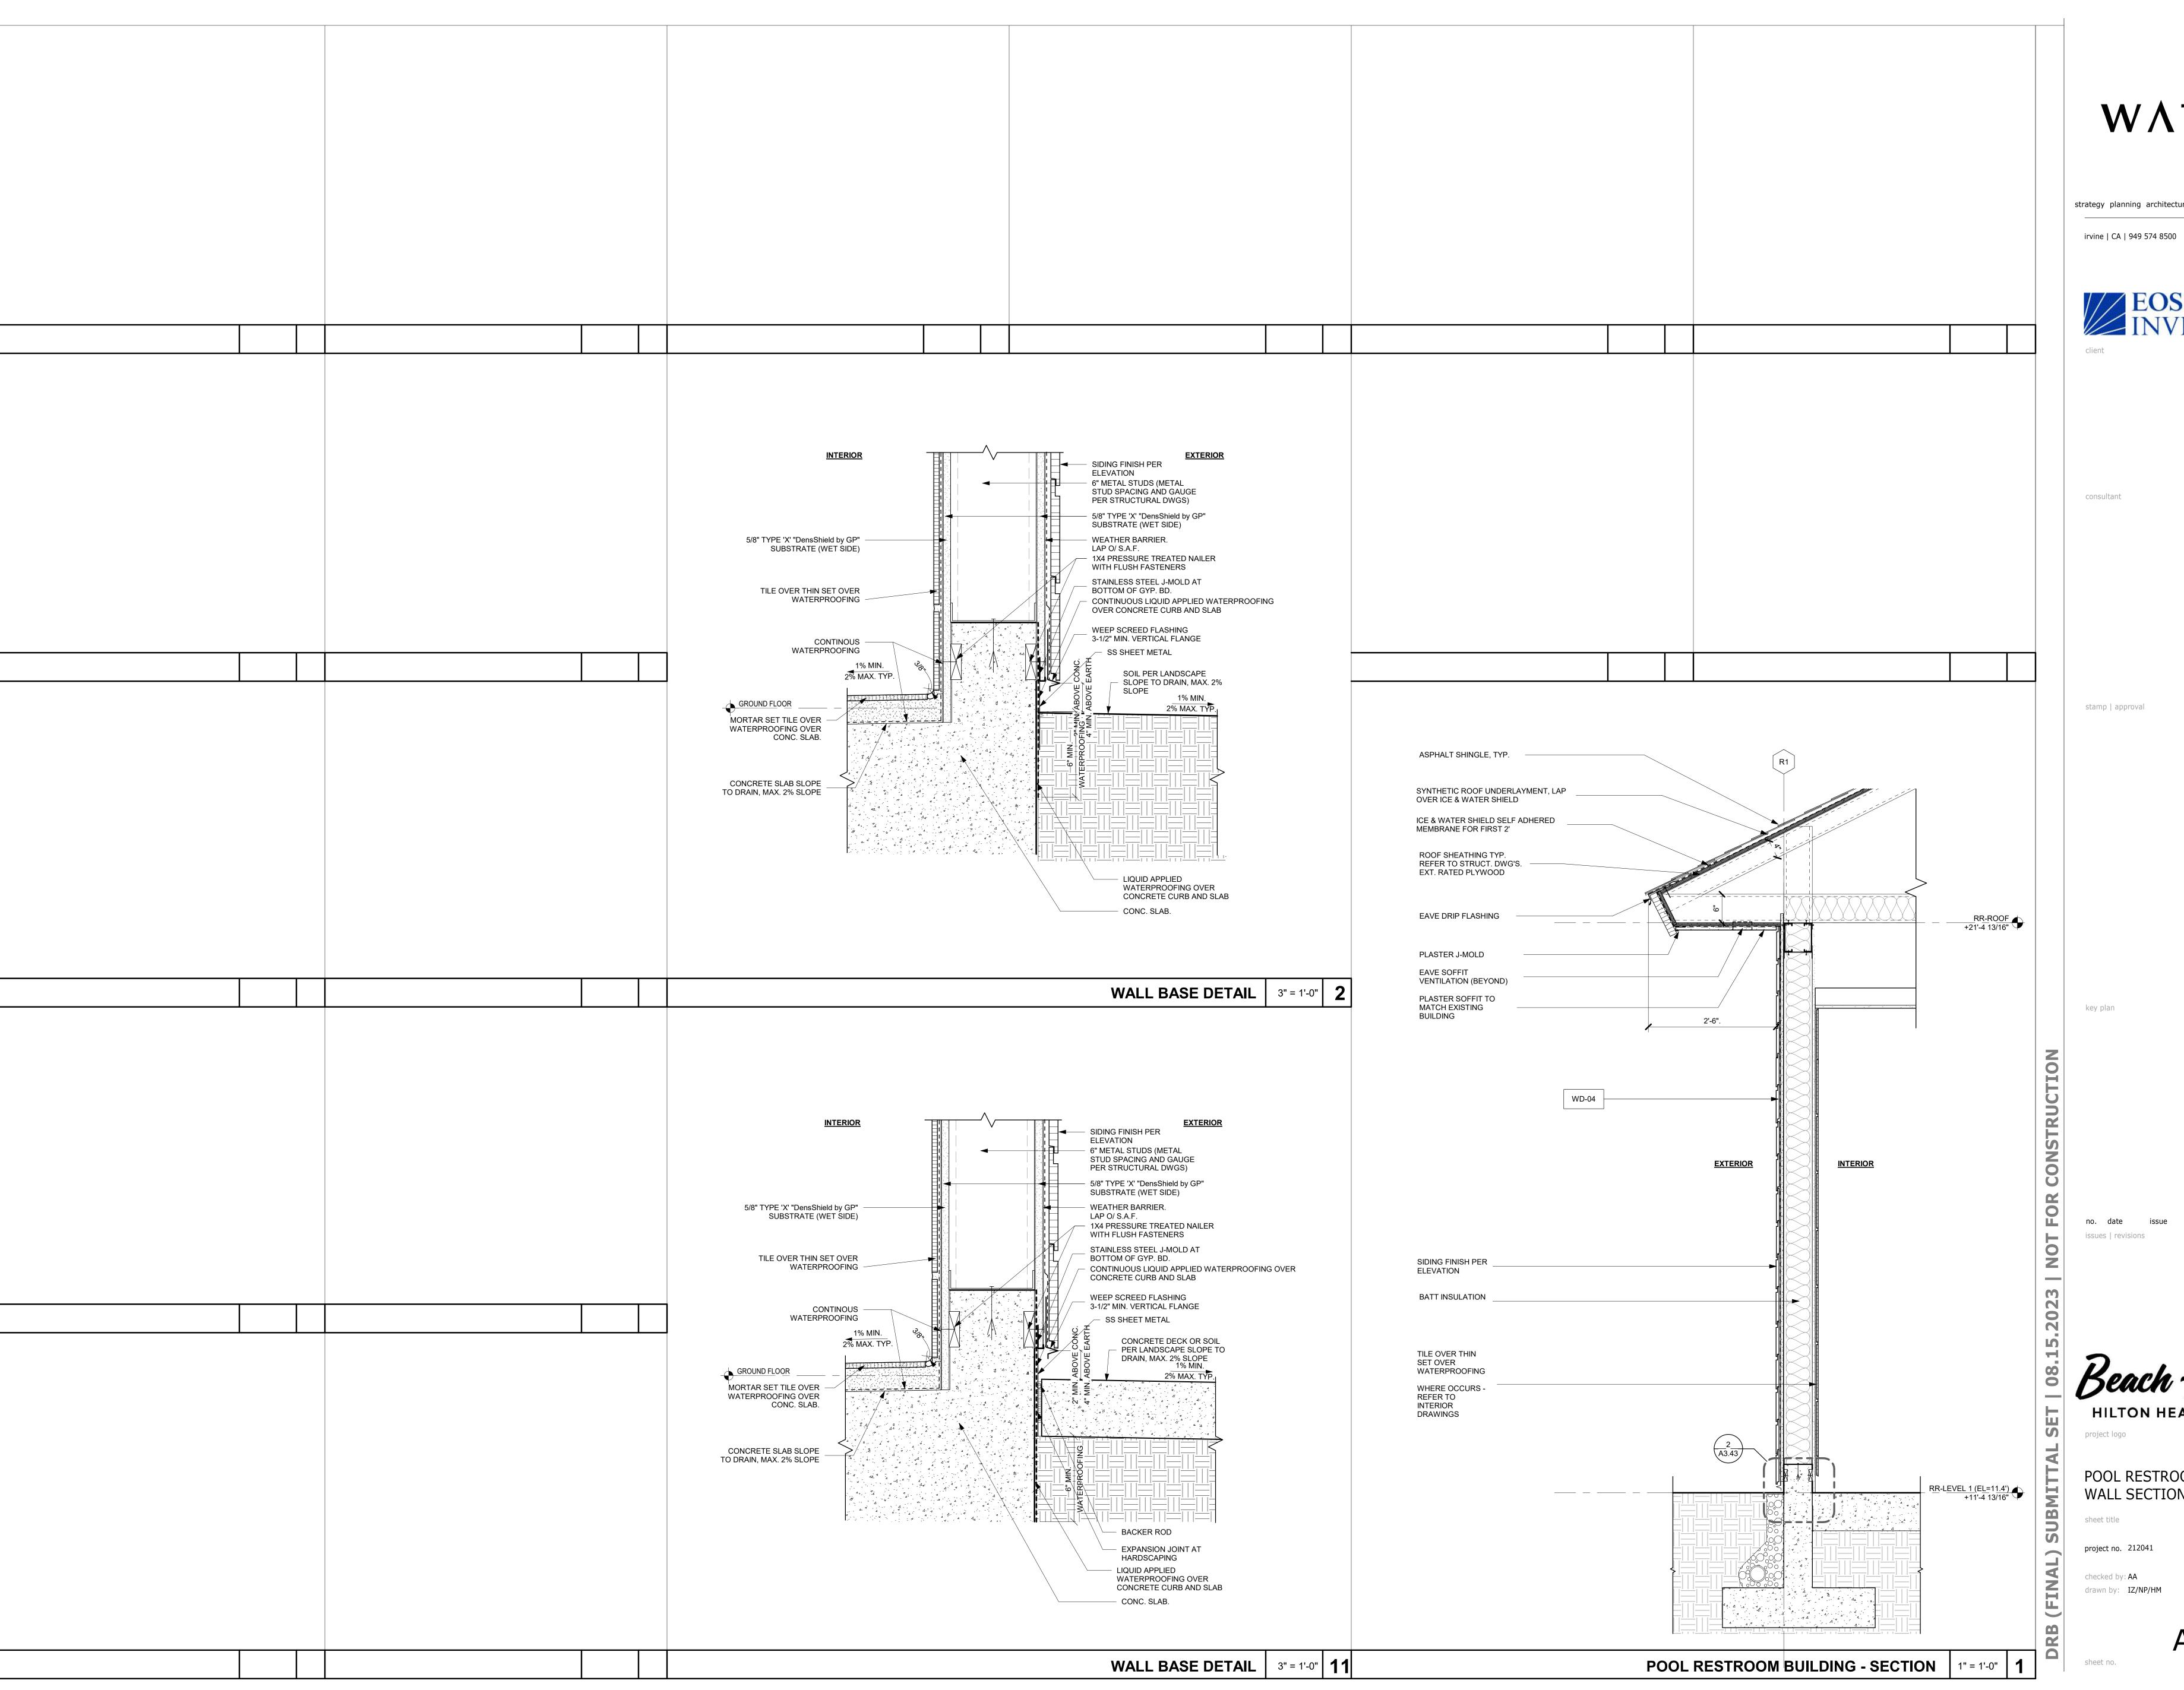

WATG

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EOS
INVESTORS

consultant

key plan


no. date issues | revisions

HILTON HEAD ISLAND

project logo

POOL RESTROOM BLDG -WALL SECTION/DETAILS

project no. 212041 checked by: AA drawn by: IZ/NP/HM

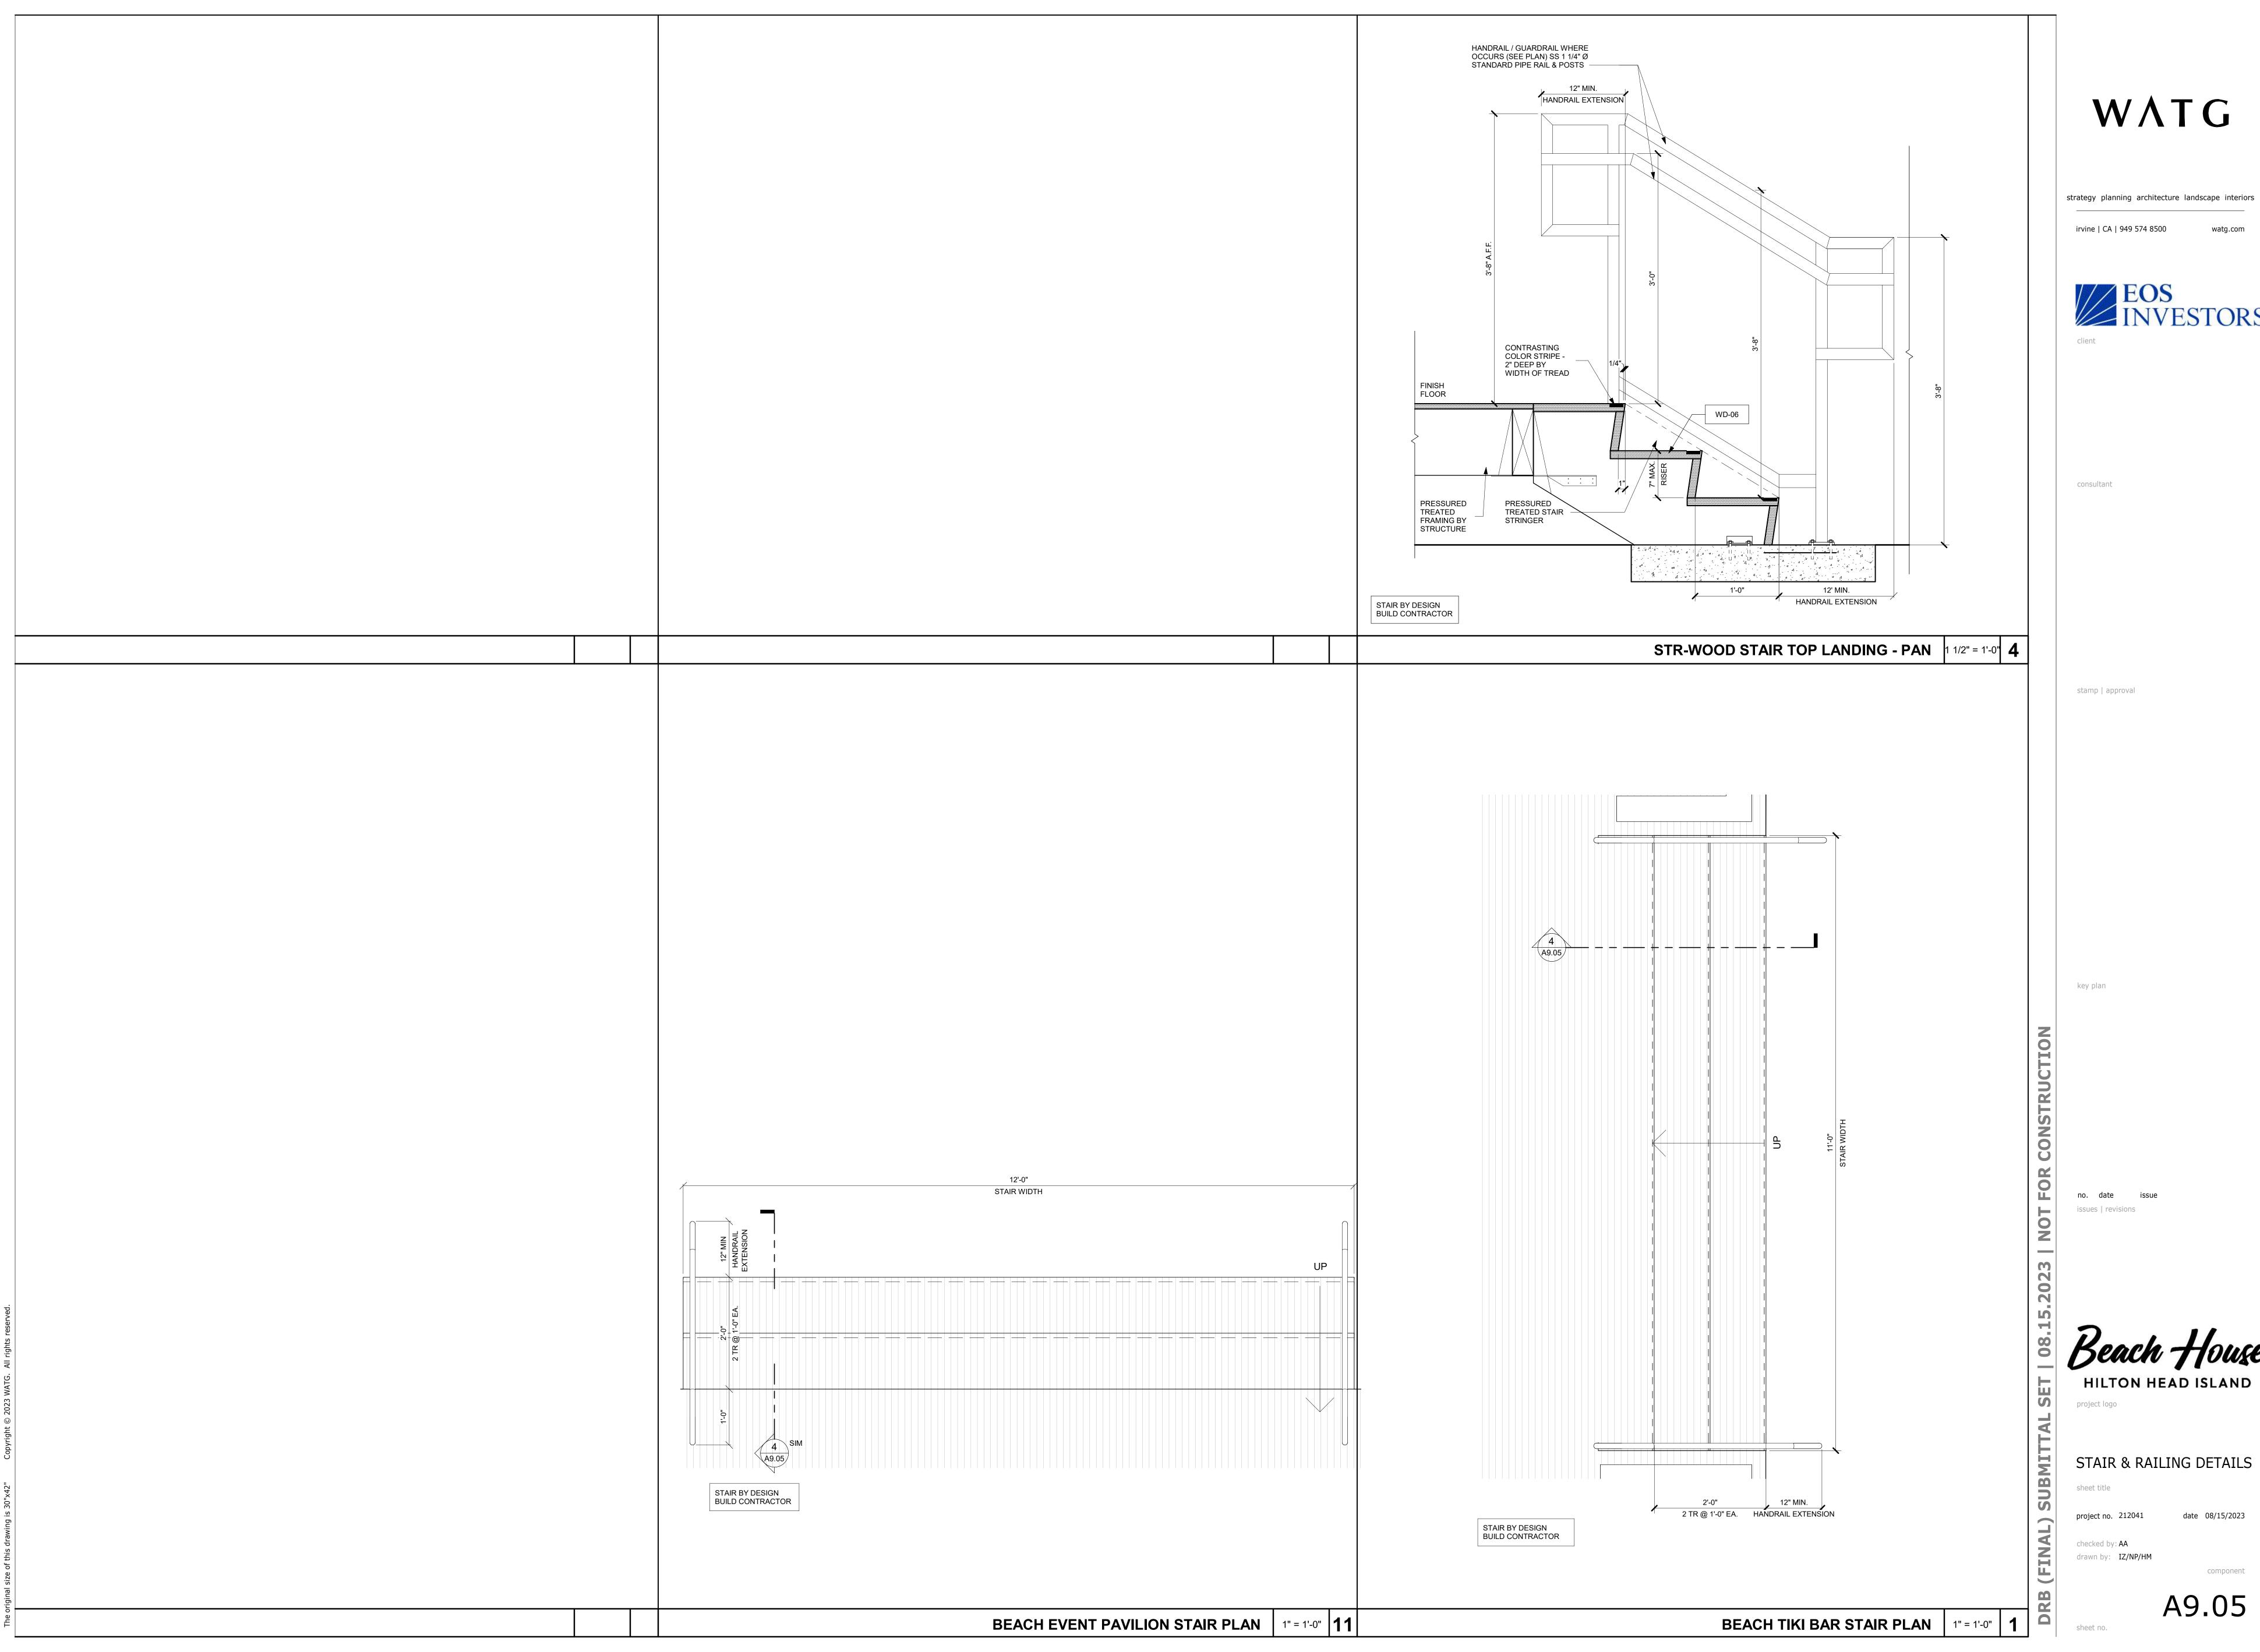



**STU-01** TABBY SHELL STUCCO LIGHT TAN EARTH TONE



WD-01

NEW WOOD COLUMN / BEAMS, FASCIA AND LOUVERS / T&G CEILING

WOOD SPECIE: SOUTHERN YELLOW PINE - SMOOTH FINISH

PENETRATING SEMI-TRANSPARENT STAIN & SEALER

SAMPLE COLOR: VALSPER - MONTICELLO

**WD-02** 

WOOD RAILING

CABLE COLOR:

STAINLESS STEEL

WOOD MATERIAL/COLOR: MATCH DECKING WD-03



**WD-05** WOOD LOUVER

WOOD & COLOR: MATCH WD-01



MTL-01

WOOD STRUCTURAL STEEL CONNECTIONS

FINISH: STAINLESS STEEL



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MTL-03

HORIZONTAL EQUIPMENT SCREEN

MATCH COLOR OF METAL ROOF RF-02



**RF-02** 

**RF-01** 

NEW THATCH ROOF TO

MATCH EXISTING

STANDING SEAM METAL ROOFING

MANUFACTURER: PAC-CLAD

COLOR: CITY SCAPE



WD-03

WOOD DECK

WOOD SPECIE: CUMARU HARDWOOD

CLEAR COAT NATURAL



WD-07

**WD-06** 

(@ TIKI BAR)

WOOD SPECIE:

NEW WOOD COLUMN

PRESSURE TREATED

SOUTHERN YELLOW

MATCH EXISTING

NEW WOOD BEAM AND RAFTERS

WOOD SPECIE: SOUTHERN YELLOW PINE MATCH EXISTING

CLEAR COAT NATURAL STAIN & SEALER



**STN-01** 

STONE CAP





### **RF-03**

NEW SHINGLE ROOF TO MATCH EXISTING

MANUFACTURER: GAF TIMBERLINE HD

COLOR: WEATHERED WOOD ARCHITECTURAL SHINGLES




### **WD-04**

WOOD SHIPLAP SIDING AND TRELLIS

WOOD SPECIE: CUMARU HARDWOOD

COLOR: CLEAR COAT NATURAL STAIN & SEALER

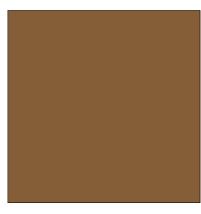

### PT-01

NEW WOOD ROOF FASCIA & FIBERGLASS DOORS

PENETRATING STAIN & SEALER

SAMPLE COLOR: VALSPAR SOLID COLOR PINEBARK



PT-02

EXTERIOR STUCCO CLG. & WOOD FASCIA

COLOR: MATCH (E) BLDG STUCCO SOFFIT COLOR issues | revisions HILTON HEAD ISLAND

### MATERIAL BOARD - DRB

sheet title

project no.212041

Checker

drawn by: Author

A-10.01

08/15/2023

sheet no.



## **APPENDIX**

### LOOK AND FEEL OF THE PROJECT

(RENDERINGS ARE GRAPHIC ILLUSTRATIONS OF PREVIOUS CONCEPTS ONLY AND NOT REPRESENTIVE OF CURRENT 8-22-23 REVIEW PACKAGE)

ADJACENT PROPERTY PHOTOS

HILTON HEAD BEACH HOUSE PHOTOS

SETBACK AND FLOOD SITE INFORMATION






























OCEAN ONE VILLAS

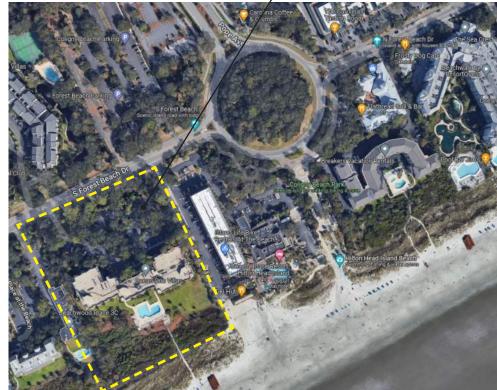

OCEAN ONE VILLAS






RESTROOM PAVILION



-COLIGNY BEACH PARK

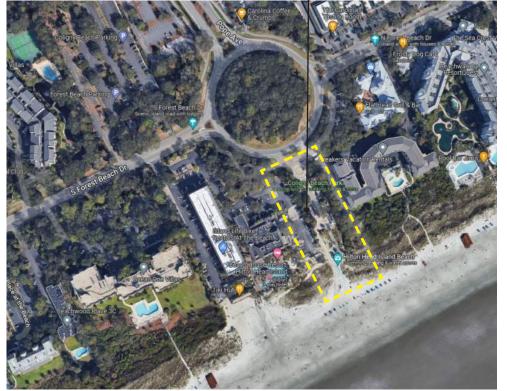

WATG





BEACH MARKET





BREAKERS VACATION RENTALS



















VIEW OF PORTE COCHERE FROM PARKING LOT

**GUESTROOM PATIO** 








VIEW OF TIKI BAR FACING THE BEACH










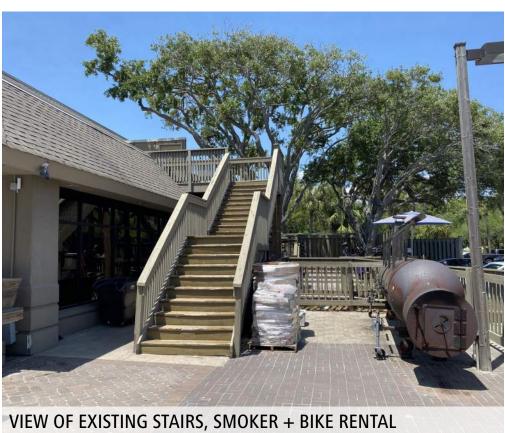

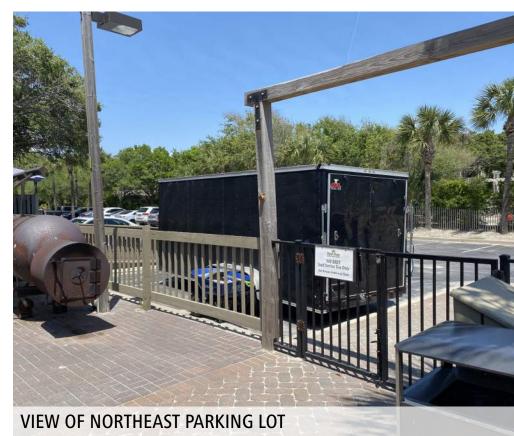






WEST VIEW OF POOL DECK




NIGHT VIEW FROM SOUTH OF POOL DECK LOOKING TOWARDS TIKI BAR + GUESTROOM HOTEL


WATG HILTON HEAD BEACH HOUSE RENOVATION HILTON HEAD ISLAND, SOUTH CAROLINA

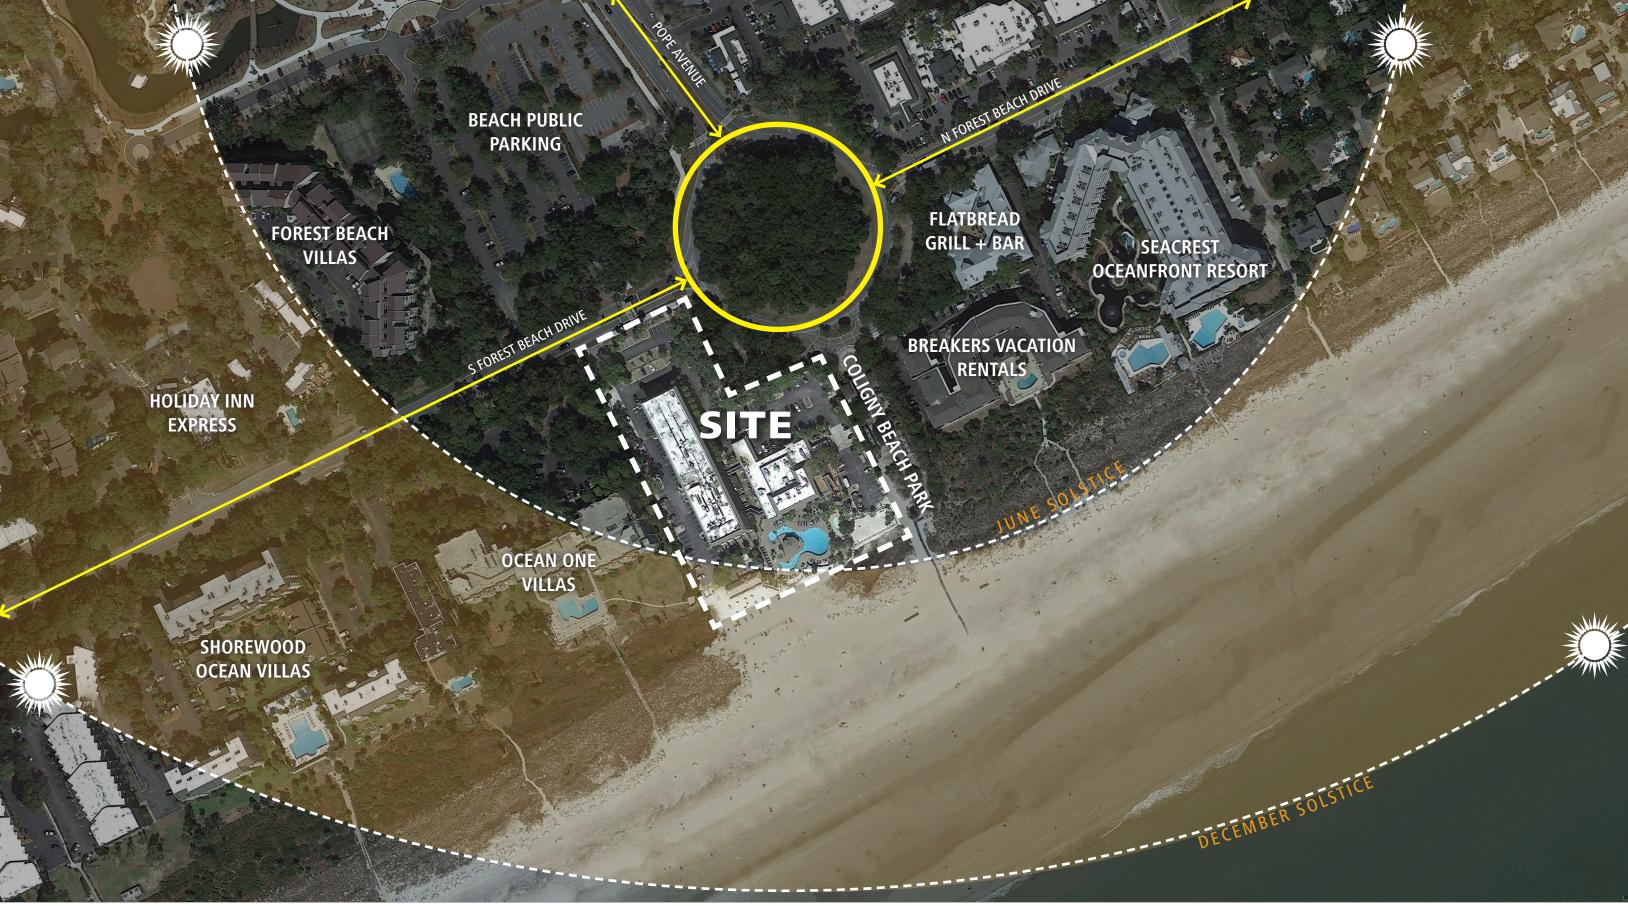



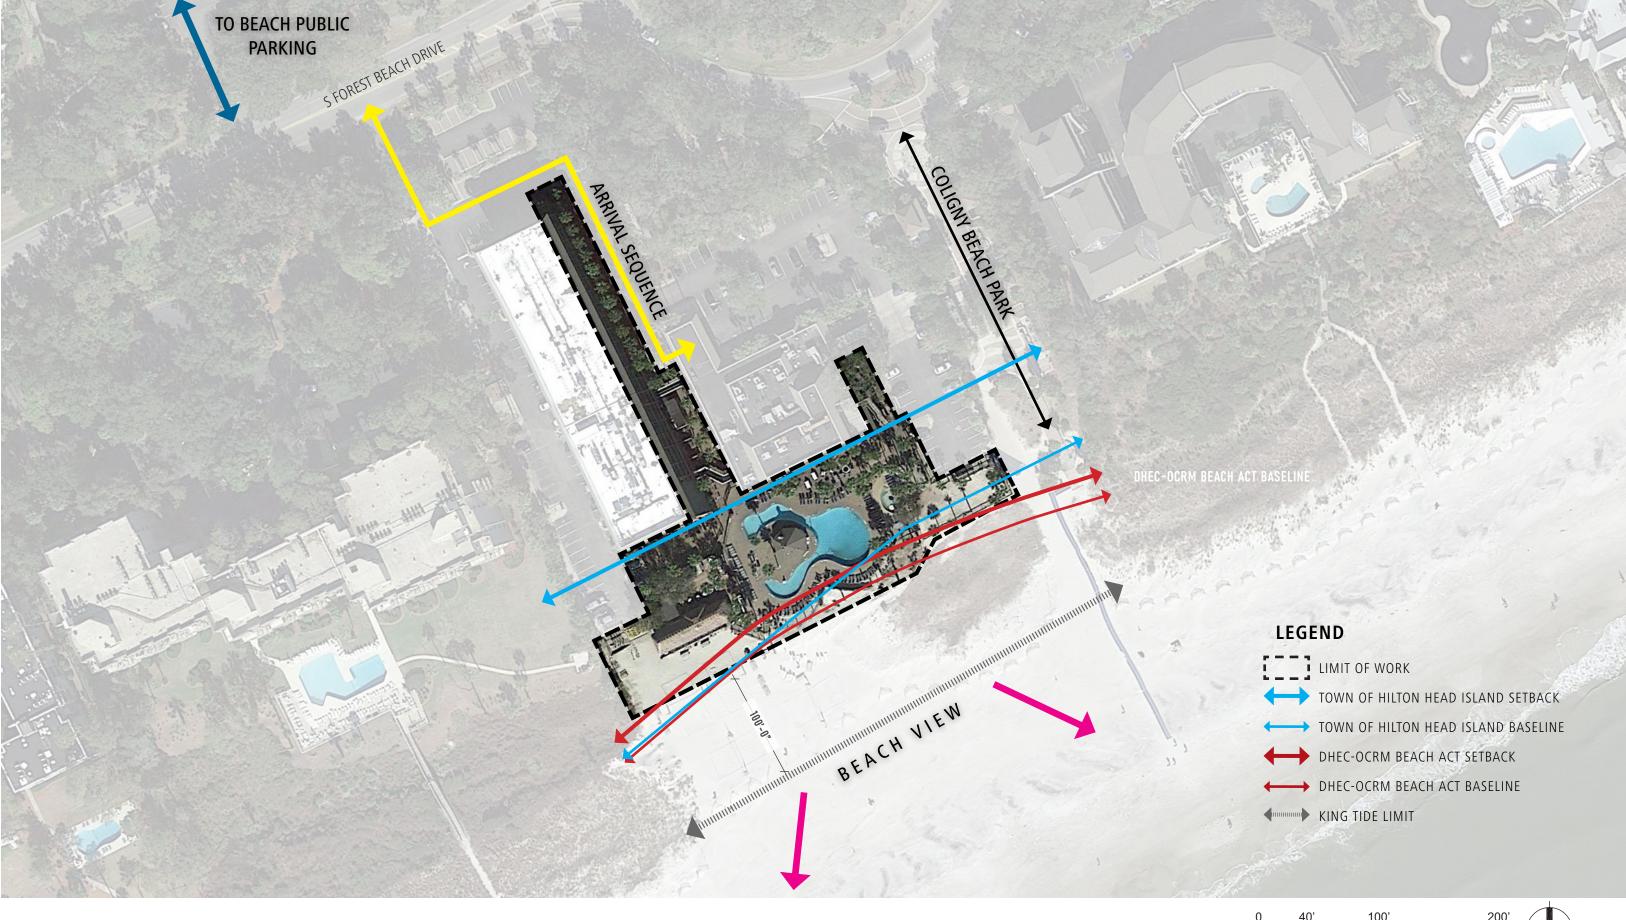



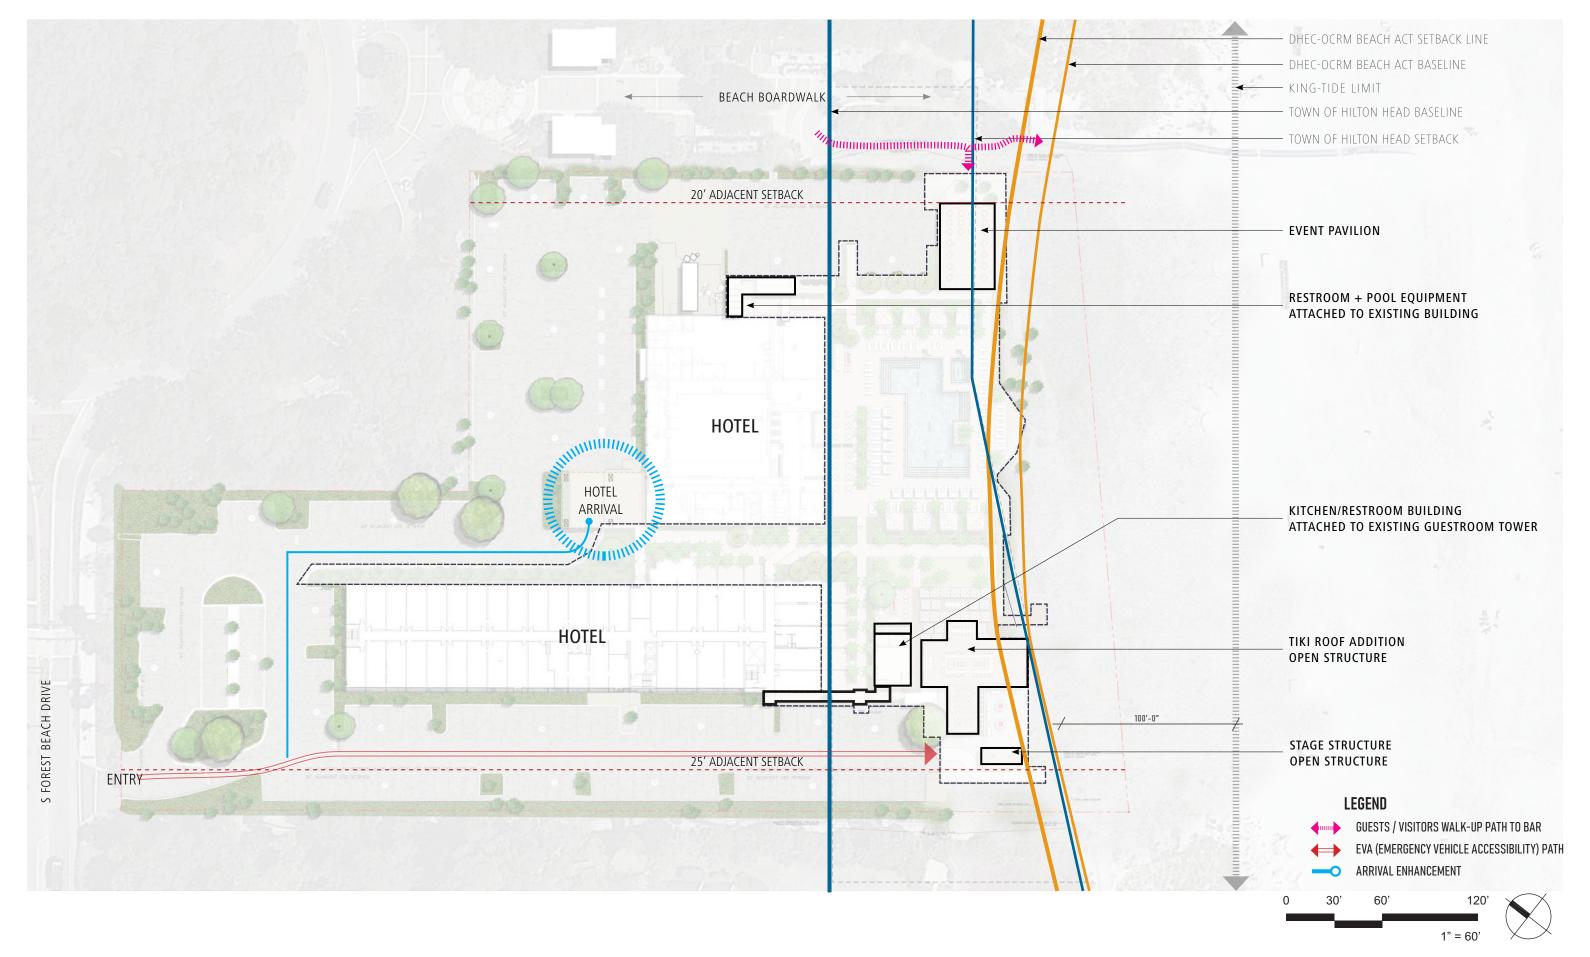

### FEMA (FIRM) FLOOD ZONE DESCRIPTIONS:

### FLOOD ZONE AO (1)

- River or stream flood hazard areas, and areas with a 1% or greater chance of shallow flooding each year, usually in the form of sheet flow, with an average depth ranging from 1 to 3 feet. These areas have a 26% chance of flooding over the life of a 30-year mortdage.
- Have the lowest floor elevated to at least as high as the depth number specified on the Flood Insurance Rate Map, in feet, above the highest adjacent grade or eleven (11) feet above mean sea level, whichever is higher, or
- Be completely floodproofed together with attendant utility and sanitary facilities to or above the depth number so that any space below that level is watertight with walls substantially impermeable to the passage of water and with structural components having the capability of resisting hydrostatic and hydrodynamic loads and effects of buoyancy.

### FLOOD ZONE VE (12)


- Coastal areas with a 1% or greater chance of flooding and an additional hazard associated with storm waves. These areas have a 26% chance of flooding over the life of a 30-year mortgage.
- All structures shall be elevated so that the bottom of the lowest horizontal supporting member is located no lower than three (3) feet above the base flood elevation level or thirteen ( $\frac{1}{1}$ 3) feet above mean sea level, whichever is higher.

### FLOOD ZONE X AND X-SHADED

- Area of moderate flood hazard, usually the area between the limits of the 100-year and 500-year floods.
- Nonresidential structures must be constructed so that the lowest floor is elevated no lower than two (2) feet above the base flood elevation or eleven (11) feet above mean sea level, whichever is higher.

### FLOOD ZONE AE (9)

- The base floodplain where base flood elevations are provided. AE Zones are now used on new format FIRMs instead of A1-A30 Zones.
- Nonresidential structures must be constructed so that the lowest floor is elevated no lower than two (2) feet above the base flood elevation or eleven (11) feet above mean sea level, whichever is higher.

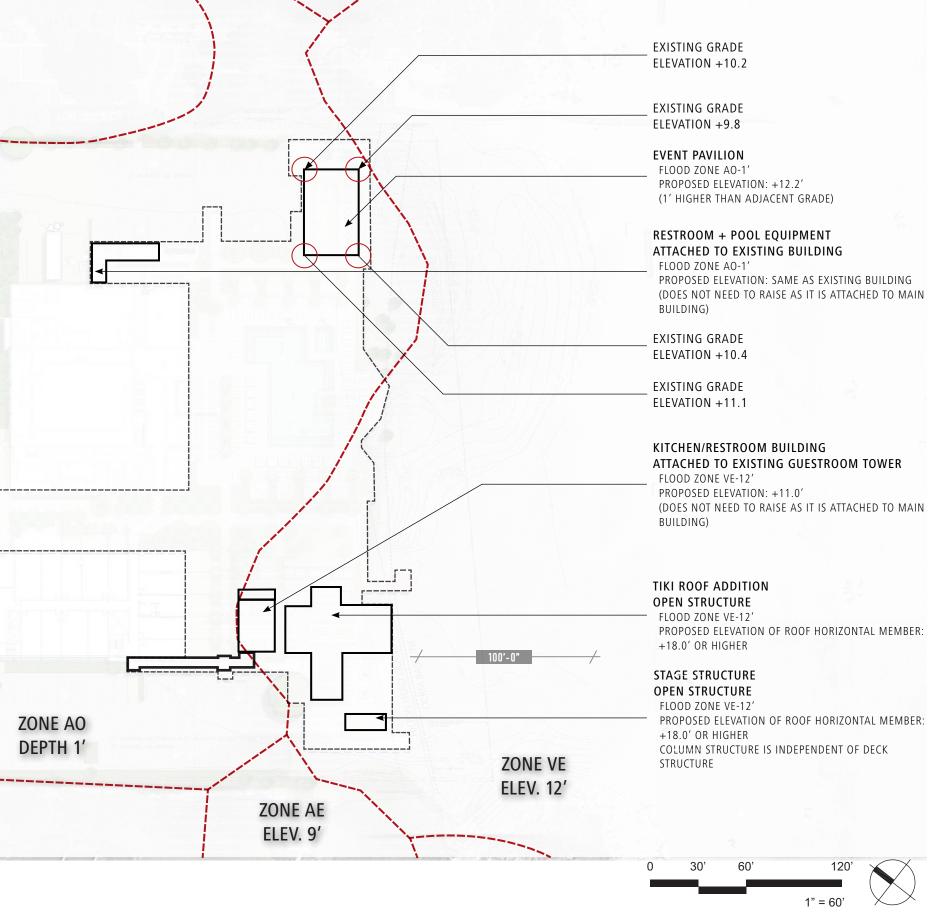



**ZONE AE** 

ELEV. 9'

**ZONE X** 

(0.2% CHANCE)



# LIGHTING NOTES

# General Notes

- Contractor shall perform all work in strict accordance with all local, national and seismic governing codes.
- All electrical material and equipment shall be new and in perfect condition when installed.
- After installation and immediatly prior to fixture focus, all lighting fixtures, including reflectors, trims, accessories and optical accessories shall be clean, dust free, undamaged and unblemished.
- After installation and immediatly prior to system commissioning, all controls equipment shall be clean, dust free, undamaged and unblemished.
- All equipment shall be listed, labeled or certified by a nationally recognized testing laboratory. Contractor is required to make field measurements based on actual site conditions to develop complete orders and install systems per drawings and specifications.
- All conduit runs shall be concealed unless shown otherwise.
- All luminaires shall be properly installed and supported in accordance with all applicable construction and safety standards. All luminaires shall be properly installed and supported in accordance with all national and local electrical codes.
- 10. Contractor shall install all conduit, j-boxes, etc., as required for a complete and operating system. 11. Contractor to provide all mounting hardware and transformers or ballasts to ensure a complete working system.

# FCD Lighting Design Documents:

- Lighting design drawings and specifications represent the design intent of the lighting design.
- Lighting Designer recommends the use of the specified lighting and control equipment.
- Electrical devices and lighting fixtures to be connected to circuits and/or control zones as indicated on the lighting design drawings. Contractor shall immediately notify lighting designer of any required modifications to the construction documents that are not shown on the lighting design documents.
- The contractor shall notify lighting designer of any provision of specification that is in conflict with local or national codes and an addendum shall be issued to correct the specification.
- 6. Emergency egress lighting fixture specification and lighting fixture locations shall be the responsibility of either the Electrical Engineer or Electrical Contractor. Emergency egress lighting shall be designed and installed to meet or exceed with local and/or national codes.
- 7. The Electrical Engineer and/or Electrical Contractor has the responsibility of producing, issuing and managing code compliance documents.

# Luminaires

- Contractor shall supply lighting fixtures and control systems as specified by the Lighting Consultant in coordination with the lighting fixtures and control systems specified by the Electrical Engineer.
- 2. Should there be a discrepency or conflict between the specifications issued by the Lighting Consutlant and the Electrical Engineer, the Electrical Contractor and/or General Contractor shall contact the Lighting Deisgner and/or the Electrical Engineer for clarification of the conflict prior to ordering the materials in conflict.
- First Circle Design, Inc. shall be notified of any product substitutions as a result of delivery, prior to ordering alternate product.
- Failure to order luminaires with adequate lead-time to meet the installation schedule does not relieve the contractor of the responsibility to provide the specified product without compensation to the owner.
- All exterior electrical equipment, luminaires and mounting hardware shall be rated for damp or wet locations as appropriate for the location of installation.
- IP rating of all equipment shall conform to the conditions in which the luminaire is mounted or installed.
- All luminaires shall be supplied with accessories as specified.
- Contractor is responsible for verifying and/or selecting the appropriate fixture mounting style or method as it relates to the ceiling conditions.
- Contractor and/or Electrical Engineer is responsible for verifying/selecting the appropriate voltage rating for lighting fixtures and electrical equipment.

# Submittals

- 1. Contractor to distribute submittals of lighting and control products specified by Lighting Consultant to Lighting Consultant, Electrical Engineer, Architect, Interior Designer and any other party who needs to review
- the specifications for accuracy and specification intent.
- 2. Contractor to coordinate the creation of lighting fixture submittal sheets generated by the fixture manufacturer's representative and/or by an independent supply house. Fixture submittals should accurately represent the fixtures specified by the Lighting Consultant. Returning the Lighting Consultants specification sheets to the Lighting Consultant for review does not constitute a submittal.
- Lamps and accessories specified shall be included in the submittal package for all luminaires Contractor to provide accurate dimensions for fixtures or lighting components that require specific measurements.
- Contractor and/or Electrical Engineer is responsible for verifying/selecting the appropriate voltage rating for lighting fixtures and electrical equipment.
- Lighting fixture quantity to be determined by the General Contractor, Electrical Contractor and/or fixture supplier.
- Lighting Consultant will return submittals with comments to the General Contractor.
- Lighting Consultant will review lighting fixture and control system submittals for accuracy and intent.
- Electrical Contractor to submit for approval on the non-specified products he/she proposes to furnish to the project within ten (10) days of award of contract. Failure to submit within this timeframe constitutes an agreement that only the lighting fixtures specified by the Lighting Consultant will be supplied and that no other products, whether listed as alternates or not, will be considered.
- 10. Requests for approval of non-specified products must be accompanied by the following at least five (5) business days in advance of the bid submittal date.
- 10.1. Manufacturer's specification sheet.
- 10.2. Working sample of product with required lamping and accessories.
- 11. Manufacturers of submitted non-specified products must have been in business for five (5) years.
- 12. Non-specified product items shall be reviewed and evaluated by First Circle Design, Inc. prior to any commencement of placing orders or performing any rough-in work.


# Installation of Interior Fixtures

- Contractor to provide a separate temporary worklight system during installation and shall not use the architectural, decorative or specialty lighting for worklight or construction use.
- Contractor to verify luminaire housing and mounting hardware is compatible with specified ceiling finishes, ceiling thickness and construction conditions. Mounting hardware and ceiling conditions must allow for the full aiming, adjusting, moving and locking capabilities of the luminaires on site.
- Contractor to provide all accessories as specified in the Lighting Design and/or Electrical Engineering documents.

- CONTROL VIA OCCUPANCY SENSOR

- All remote power supplies are to be located as near to the luminaire as possible, hidden from patron view in an accessible compartment that is well ventilated to provide heat dissipation.
- 6. All remote transformers, drivers, ballasts, power supplies, and 0-10V interfaces are to be located as per the manufacturers recommendations. These devices are to be hidden from patron view in an accessible compartment that is well ventilated to provide heat dissipation as required by the manufacturer.
- 7. In all areas of public access and visibility, the size, location and finish of all access panels and doors shall be coordinated with the Architect, Interior Designer and/or Lighting Designer prior to installation.

# LUMINAIRE KEY

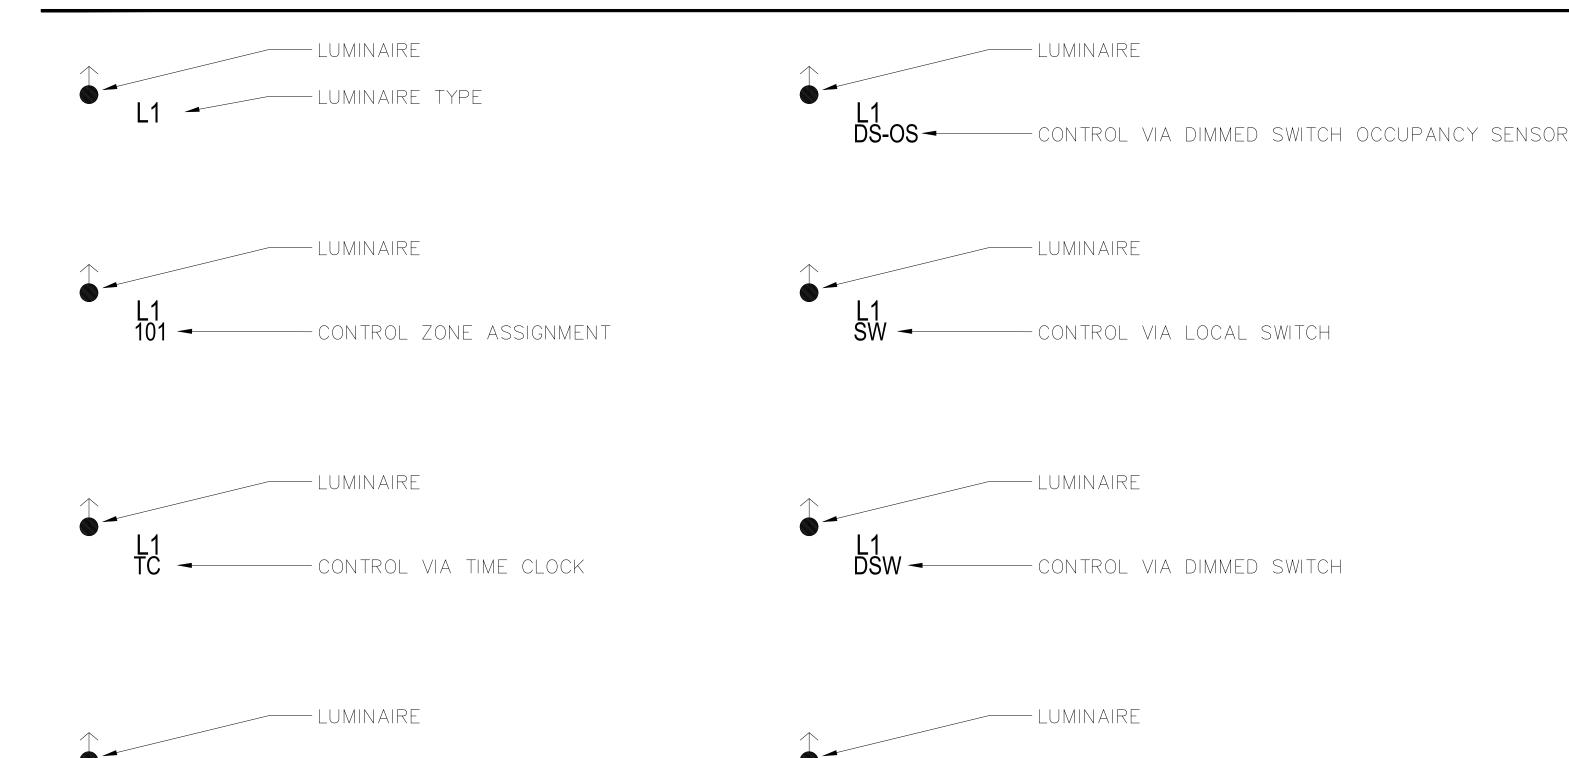

- DMX CONTROL

## Installation of Exterior Landscape Fixtures

- Contractor to provide a separate temporary worklight system during installation and shall not use the landcape lighting fixures for worklight or construction use.
- Contractor to verify luminaire housing and mounting hardware is compatible with specified constuction conditions and/or planting soil.
- Mounting hardware and installtion conditions must allow for the full aiming, adjusting, moving and locking capabilities of the luminaires on site.
- Contractor to provide all accessories as specified in the Lighting Design and/or Electrical Engineering documents. All remote power supplies are to be located as near to the luminaire as possible, hidden from patron view in an accessible compartment that is well ventilated to provide heat dissipation.
- All remote transformers, drivers, ballasts, power supplies, and 0-10V interfaces are to be located as per the manufacturers recommendations. These devices are to be hidden from patron view in an accessible compartment that is well ventilated to provide heat dissipation as required by the manufacturer.
- 7. In all areas of public access and visibility, the size, location and finish of all access panels and doors shall be coordinated with the Architect, Landscape Designer and/or Lighting Designer prior to installation.

# Dimming and Control System Installation

- Lighting control systems required shall include all major components indicated, as well as incidental components required for proper operation.
- Lighting control systems using 0-10V control will required low voltage control wiring in addition to high voltage power wiring.
- All branch circuits terminating in a dimmer panel shall have a separate neutral conductor.
- There shall be NO common neutral conductors used for any load or branch circuit wiring from the dimmers. Contractor shall include and coordinate factory commissioning for the dimming system prior to Lighting Design aim and focus.
- Upon completion of the installation, the system shall be completely commissioned by a factory-employed engineer. The factory-employed engineer shall demonstrate and educate the owner's representative(s)
- on the system capabilities, operation and maintenance.
- Manufacturer shall be capable of providing on-site service support within 24 hours anywhere in the continental USA and within 72 hours anywhere in the world, except where special visa are required.
- Service contracts will be available to owner from date of system commissioning.
- Dimmed circuits that also control lights designated as part of emergency egress lighting are to be routed through a system that allows immediate bypass of dimmed circuit to allow lighting to come to full in emergency situations. Bypass system must allow lighting system to be manually re-set for normal operations.

# Commissioning and Adjustment Phase

- Contractor shall properly test and verify all circuitry, dimming and control prior to Commissioning and Focus Phase commencing.
- Contractor shall verify that all fixtures designated to operate on specific control zones are grouped accordingly.
- After installation and immediately prior to control system commissioning, all controls equipment shall be clean, dust free, undamaged and unblemished.
- After installation and immediately prior to fixture focus, all lighting fixtures, including reflectors, trims, accessories and optical accessories shall be clean, dust free, undamaged and unblemished.
- All luminaires shall be properly and securely installed to allow for the proper adjustment of the fixture focus.
- All luminaires shall be properly and securely installed to allow for the proper maintenance of fixture adjustment and focus.
- Contractor to have all necessary equipment available for the Commissioning and Focus Phase including, but not limited to:
- 7.1. Standard contractor electrician hand tools including any tools supplied or available from the fixture manufacturer for the focus, adjustment and/or focus lock of the fixture. Ladders, lifts, scaffolding, safety harnesses, eye protection, hard hats, fall protection or other equipment or materials required to access luminaires at the time for focus.
- Any and all communication devices needed in the event that the Lighting Designer and Electrician are not in the same area, room or space and cannot speak directly to one another in order to adjust either a light fixture or the control system.
- Contractor to arrange for access to areas of the project needed for focus of lighting fixtures.
- Contractor to arrange for the proper protection of floor finishes in areas where lifts or ladders will be used during the Commissioning and Focus Phase of the project.
- 10. Contractor to replace all burned out or inoperative lamps at the end of the construction phase prior to Commissioning and Adjustment Phase and again prior to Owner occupancy or project opening. 11. Commissioning and Adjustment Phase may include evening or night work as may be required due to schedule conflict or daylight impact.
- 12. Contractor shall arrange for and provide temporary electric service during the Commissioning and Adjustment Phase as well as required Mock-ups.
- 13. Contractor shall be responsible for rough and final aiming of all lighting luminaires as directed by lighting designer during Commissioning and Adjustment Phase. 14. Contractor to supply electricians during the Commissioning and Adjustment Phase to aim each luminaire. Electricians to be minimum journeyman level experience.

# LIGHTING CONTROL DEVICES - KEY

<u>SYMBOL</u>	<u>DESCRIPTION</u>
LTS TS	TOUCHSCREEN LIGHTING CONTROLLER. REQUIRES LOW VOLTAGE CONTROL WIRE HOME RUN TO CONTROL SYSTEM.
BS BS	DIMMING BUTTON STATION WITH 4-PRESET SCENES, DESGINER FINISH FACEPLATE WITH ENGRAVED LABELLING. REQUIRES LOW VOLTAGE CONTROL WIRE HOME RUN TO CONTROL SYSTEM.
(J) PC	CEILING MOUNTED PHOTOCELL SENSOR FOR DAYLIT AREAS
□ JX	JUNCTION BOX FOR DECORATIVE FIXTURE POWER
EU RCPT	ELECTRICAL OUTLET RECEPTACLE FOR LIGHTING
\$ RB	REMOTE BUTTON STATION

WATG

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XL1B

XL1A

XP1

XT1B



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key p

no. date iss

checked by: Checker drawn by: Author

LT0.02.2

**TYPE** 

**XK11** 

XT2C

XU1

XWM1

**TYPE** 

XT1C




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FIXTURE SCHEDULE

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SITE PLAN

checked by: Checker

drawn by: Author

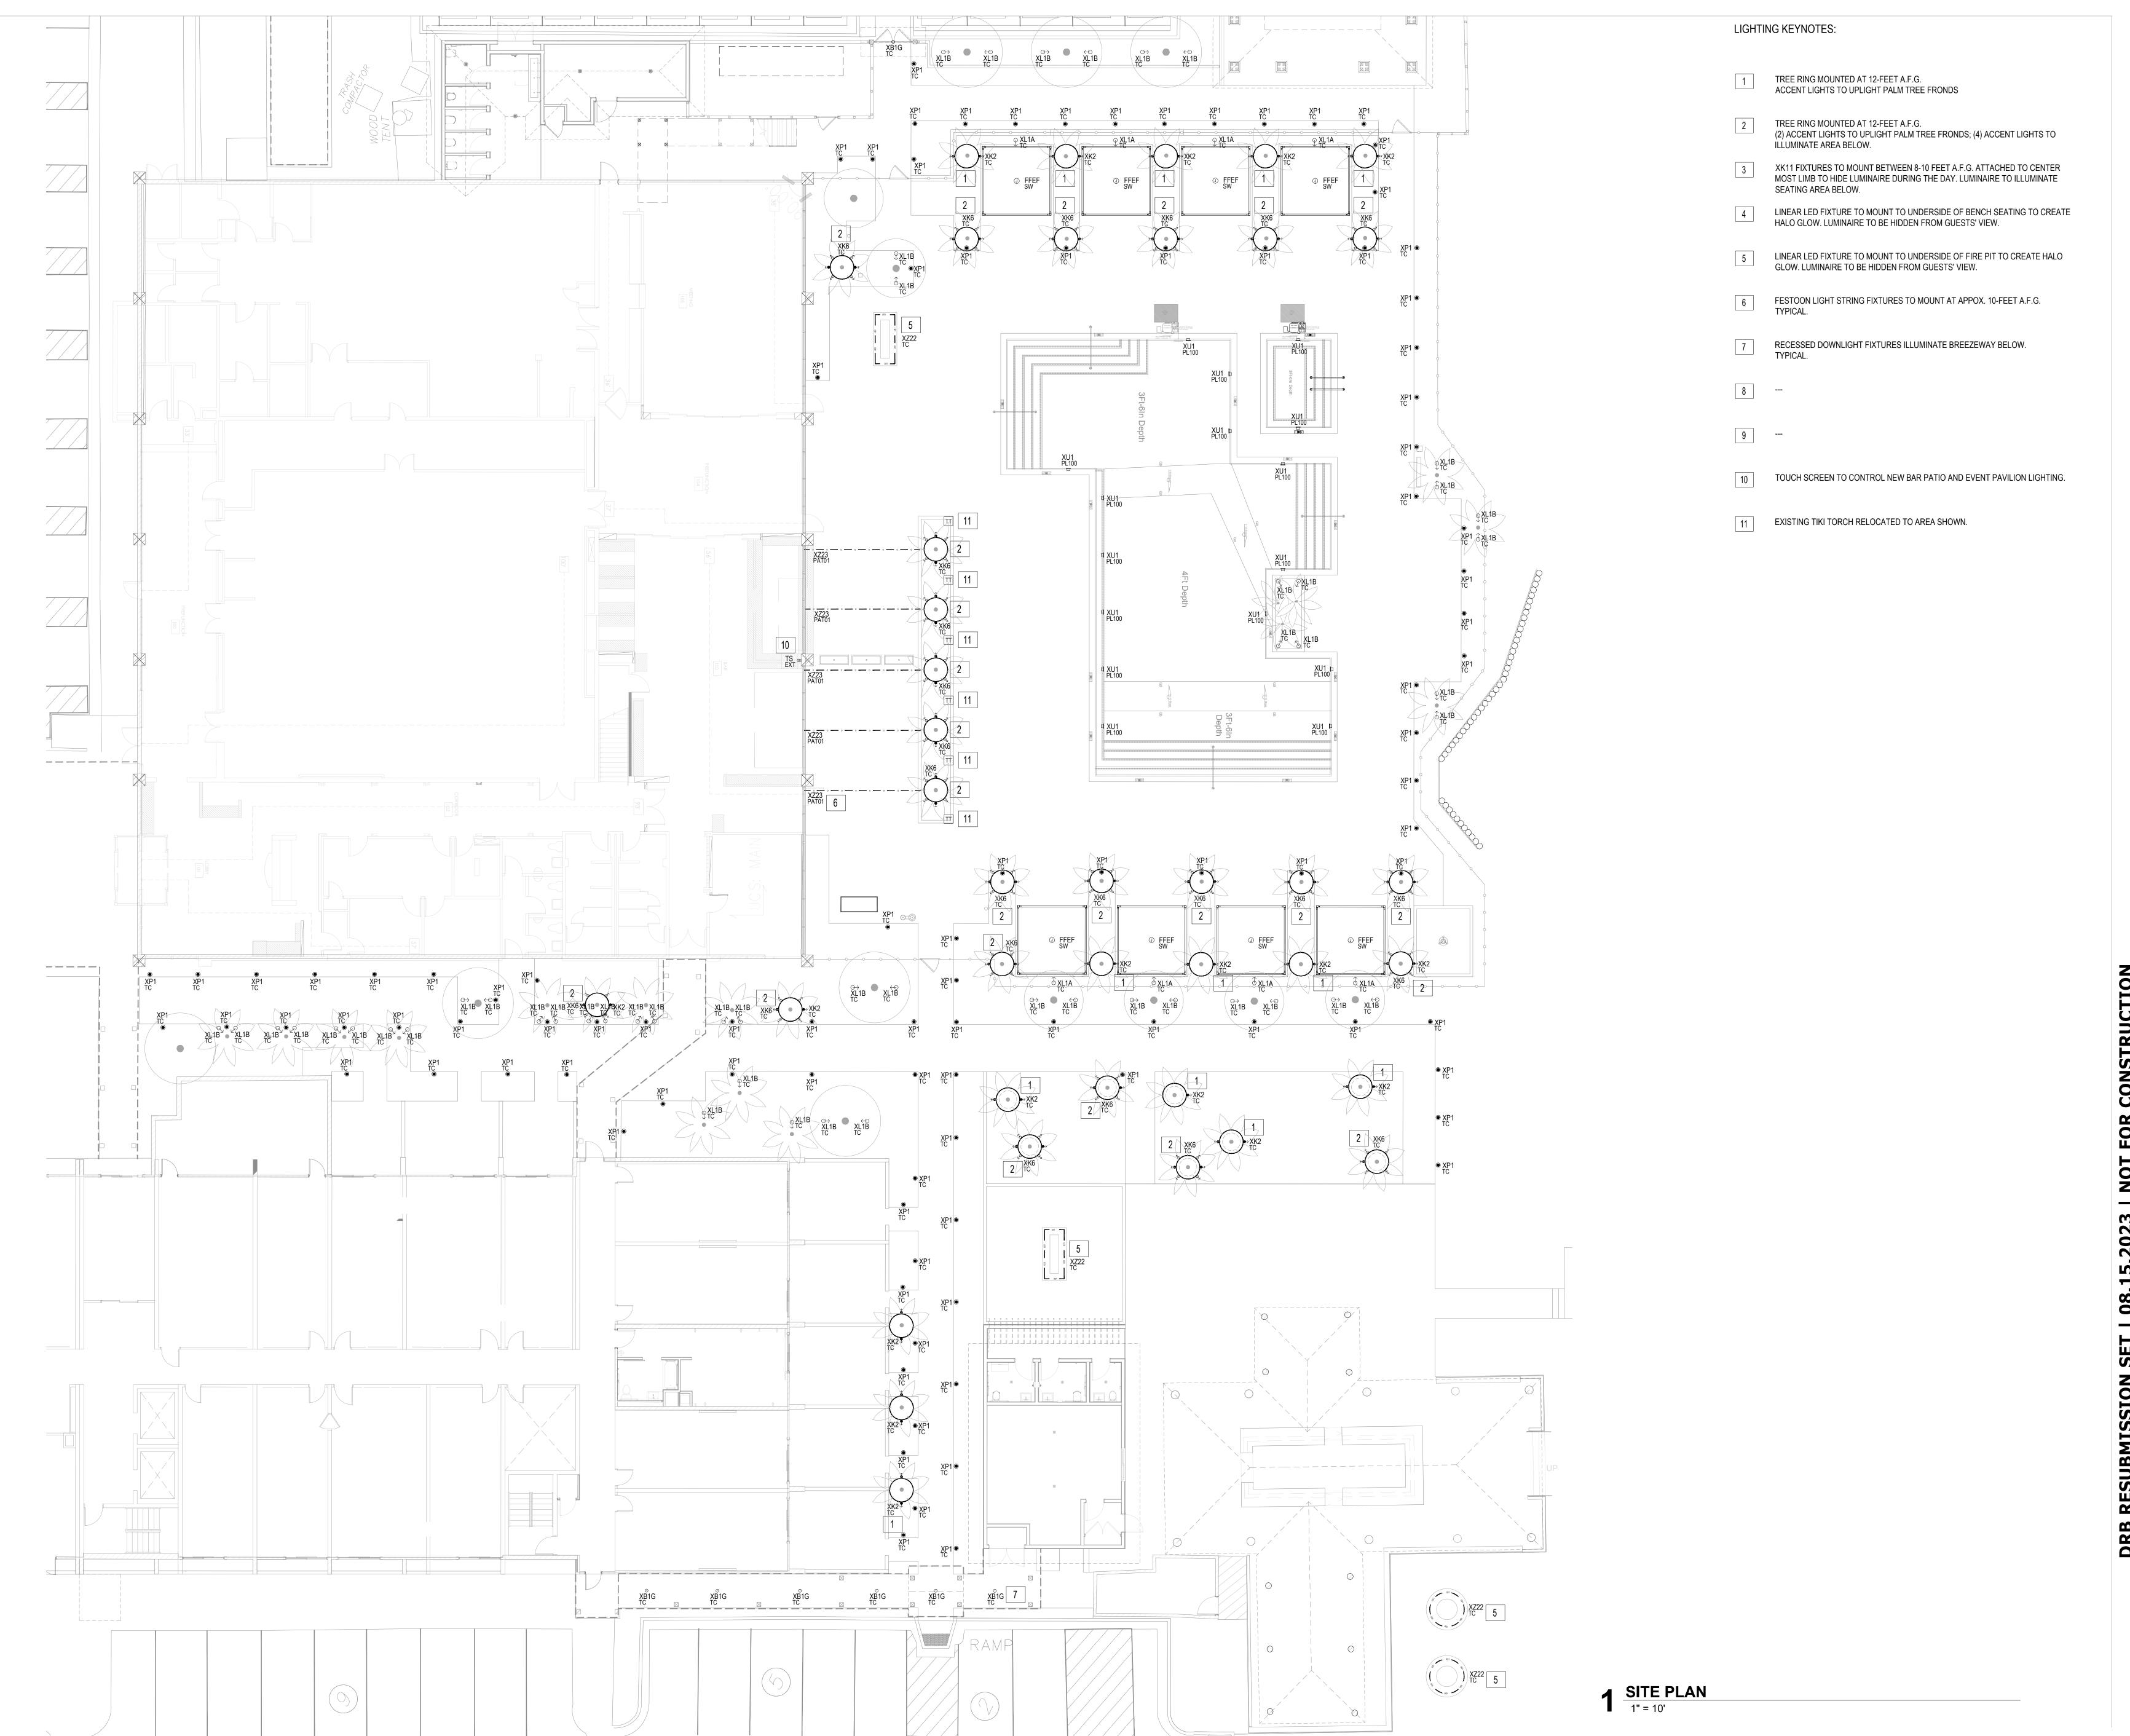
2 LUMINAIRE TO MOUNT TO COLUMN. ARCHITECT TO CONFIRM MOUNTING HEIGHT. TYPICAL OF ALL XWM2 FIXTURES.

FF&E DECORATIVE PENDANT SUSPENDED FROM OPEN CEILING STRUCTURE. FF&E SPEC PER INTERIOR DESIGNER. TYPICAL OF ALL FFEP FIXTURES. FINAL LOCATION PER INTERIOR DESIGNER.

ALL XT2C FIXTURES TO UP LIGHT EVENT CEILING. FIXTURE TO SURFACE MOUNT TO SIDE OF BEAM. LOW VOLTAGE WIRE TO RUN ON TOP OF BEAM. REMOTE POWER SUPPLIES TO BE HIDDEN WITHIN CEILING STRUCTURE. CONDUIT TO POWER SUPPLIES TO BE MOUNTED ON TOP OF BEAMS, PAINTED TO MATCH BEAM. TYPICAL OF ALL XT2C FIXTURES.

ALL XT1C FIXTURES TO DOWN LIGHT AND PROVIDE GENERAL ILLUMINATION. LOW VOLTAGE WIRE TO RUN ON TOP OF BEAM. REMOTE POWER SUPPLIES TO BE HIDDEN WITHIN CEILING STRUCTURE. CONDUIT TO POWER SUPPLIES TO BE MOUNTED ON TOP OF BEAMS, PAINTED TO MATCH BEAM. TYPICAL OF ALL XT1C

OUTLET TO BE LOCATED UP INTO THE CEILING STRUCTURE HIDDEN FROM GUESTS' VIEW. REFERENCE ARCHITECTURAL SET FOR LOCATION.

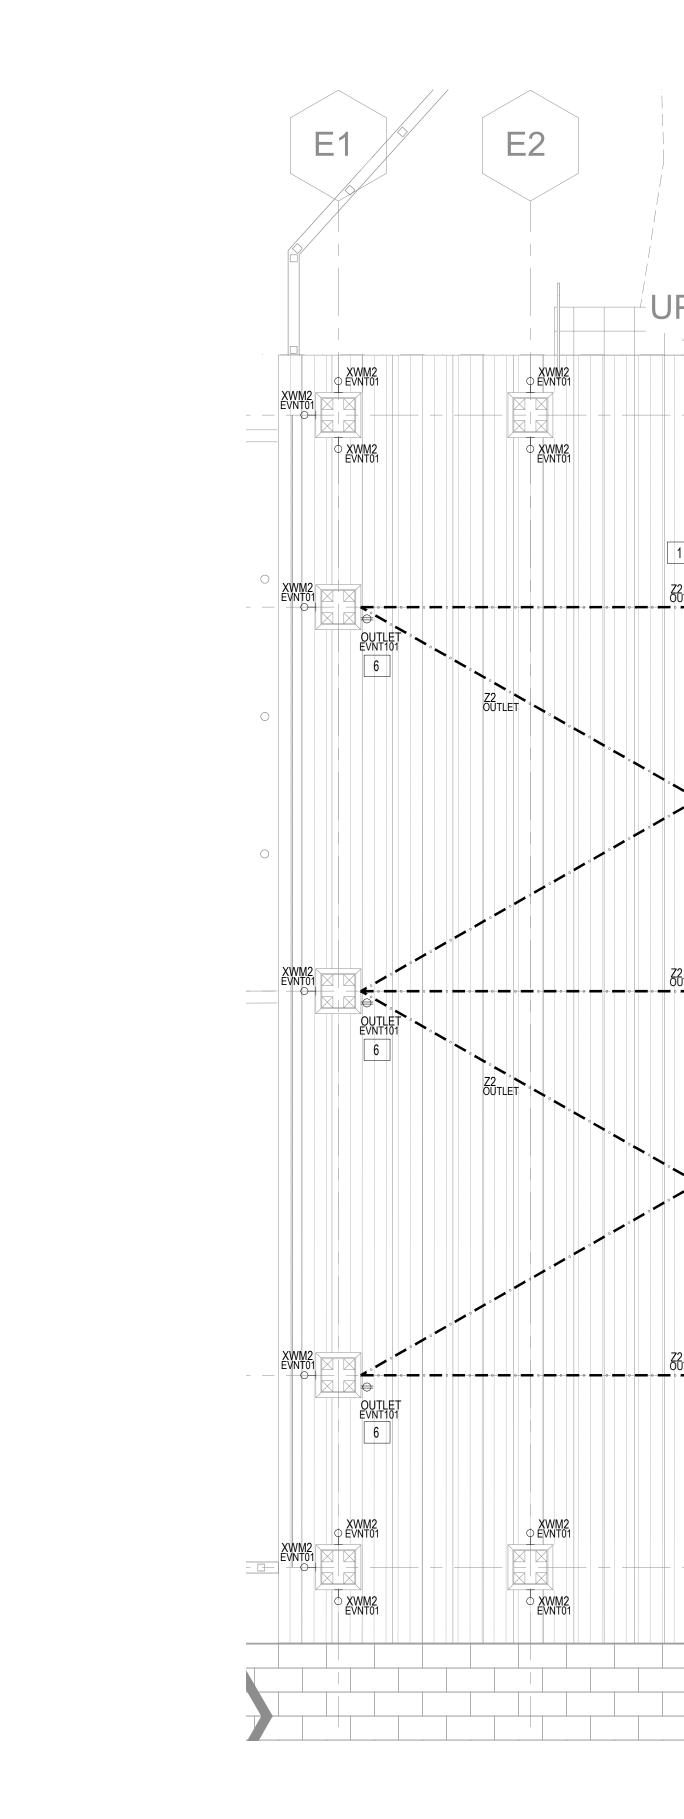

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kev

no. date issu

Beach House
HILTON HEAD ISLAND

project logo

EVENT PAVILION ENLARGED FLOOR / RCP

sheet title project no. 000000

DRB

checked by: Checker drawn by: Author

LT3.01

1 NOT NOT USED.

2 LUMINAIRE TO MOUNT TO COLUMN. ARCHITECT TO CONFIRM MOUNTING HEIGHT. TYPICAL OF ALL XWM1 FIXTURES.

NOTE NOT USED.

ALL XT2C FIXTURES TO UP LIGHT EVENT CEILING. FIXTURE TO SURFACE MOUNT TO SIDE OF BEAM. LOW VOLTAGE WIRE TO RUN ON TOP OF BEAM. REMOTE POWER SUPPLIES TO BE HIDDEN WITHIN CEILING STRUCTURE. CONDUIT TO POWER SUPPLIES TO BE MOUNTED ON TOP OF BEAMS, PAINTED TO MATCH BEAM. TYPICAL OF ALL XT2C FIXTURES.

5 NOT NOT USED.

6 ALL M1 FIXTURES TO ILLUMINATE STAGE. LUMINAIRE INSTALLED TO ALLOW FOR PAN AND TILT MOVEMENT. LOW VOLTAGE WIRE TO RUN ON TOP OF BEAM. REMOTE POWER SUPPLIES TO BE HIDDEN WITHIN CEILING STRUCTURE. CONDUIT TO POWER SUPPLIES TO BE MOUNTED ON TOP OF BEAMS, PAINTED TO MATCH BEAM. TYPICAL OF ALL M1 FIXTURES.

XT2C STG02 →

2 STAGE - RCP
1/4" = 1'-0"

1 STAGE - FLOOR PLAN
1/4" = 1'-0"

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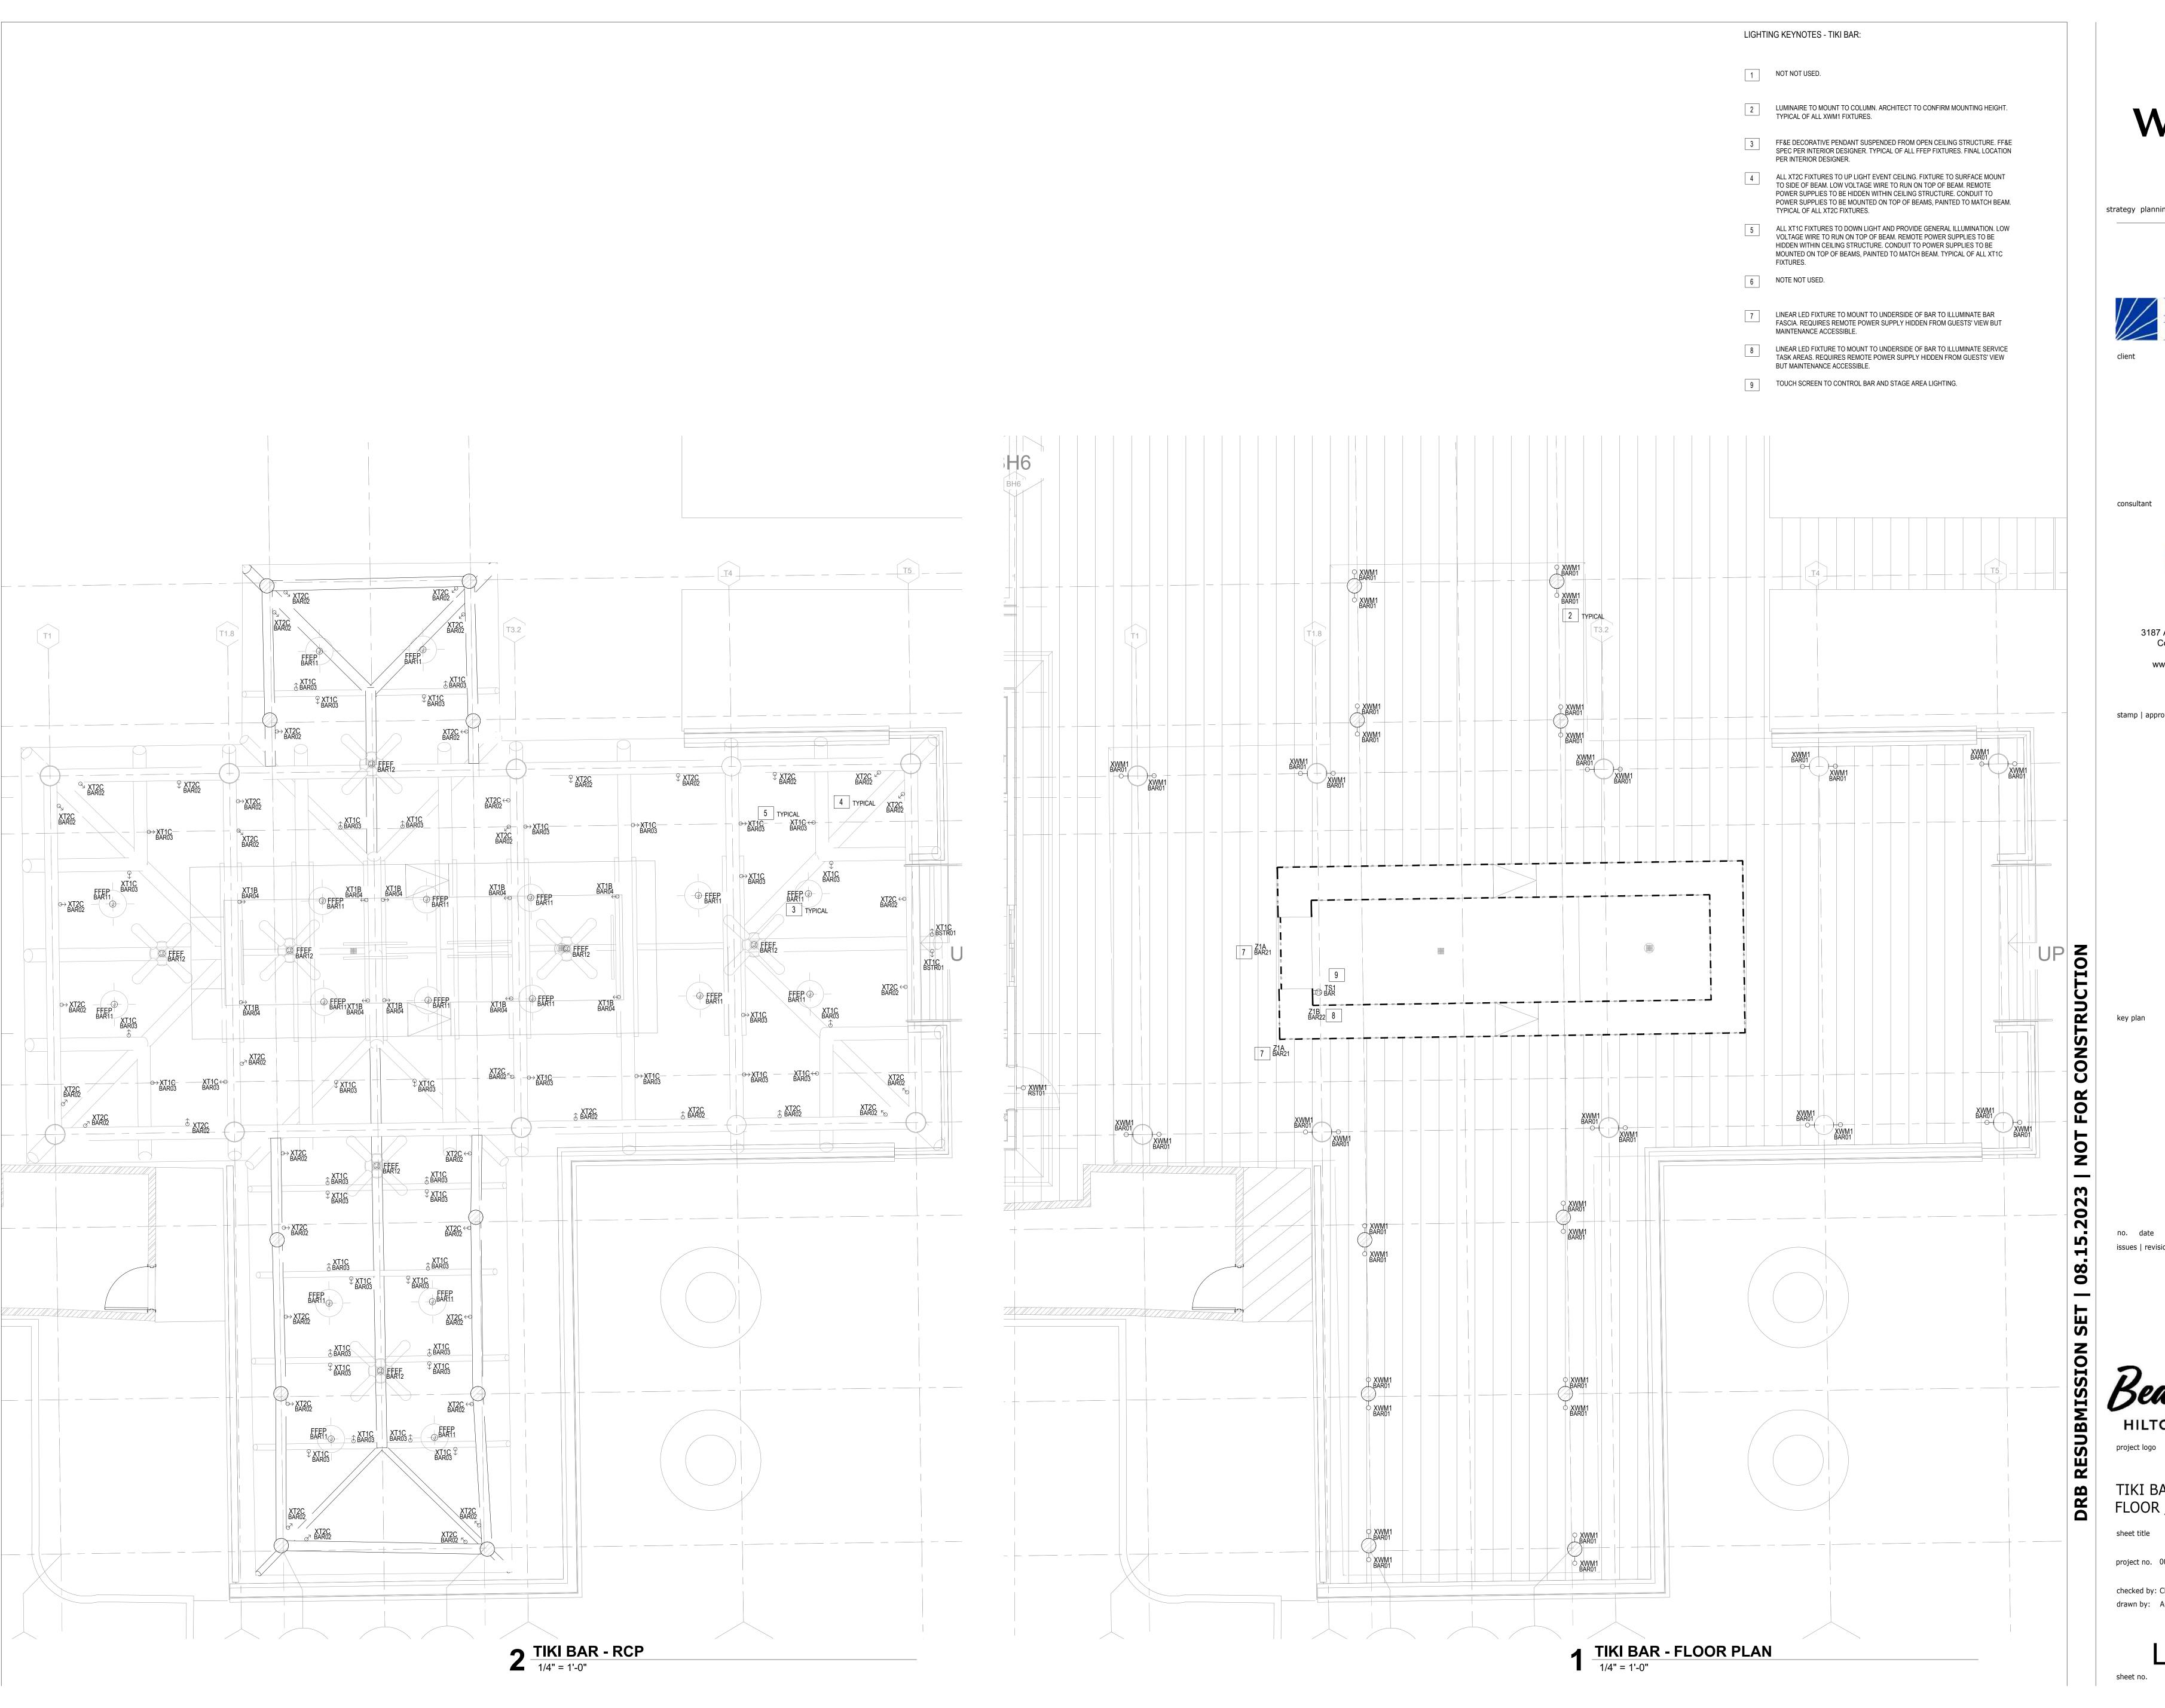
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STAGE - ENLARGED FLOOR / RCP PLANS

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DRB

sheet no.



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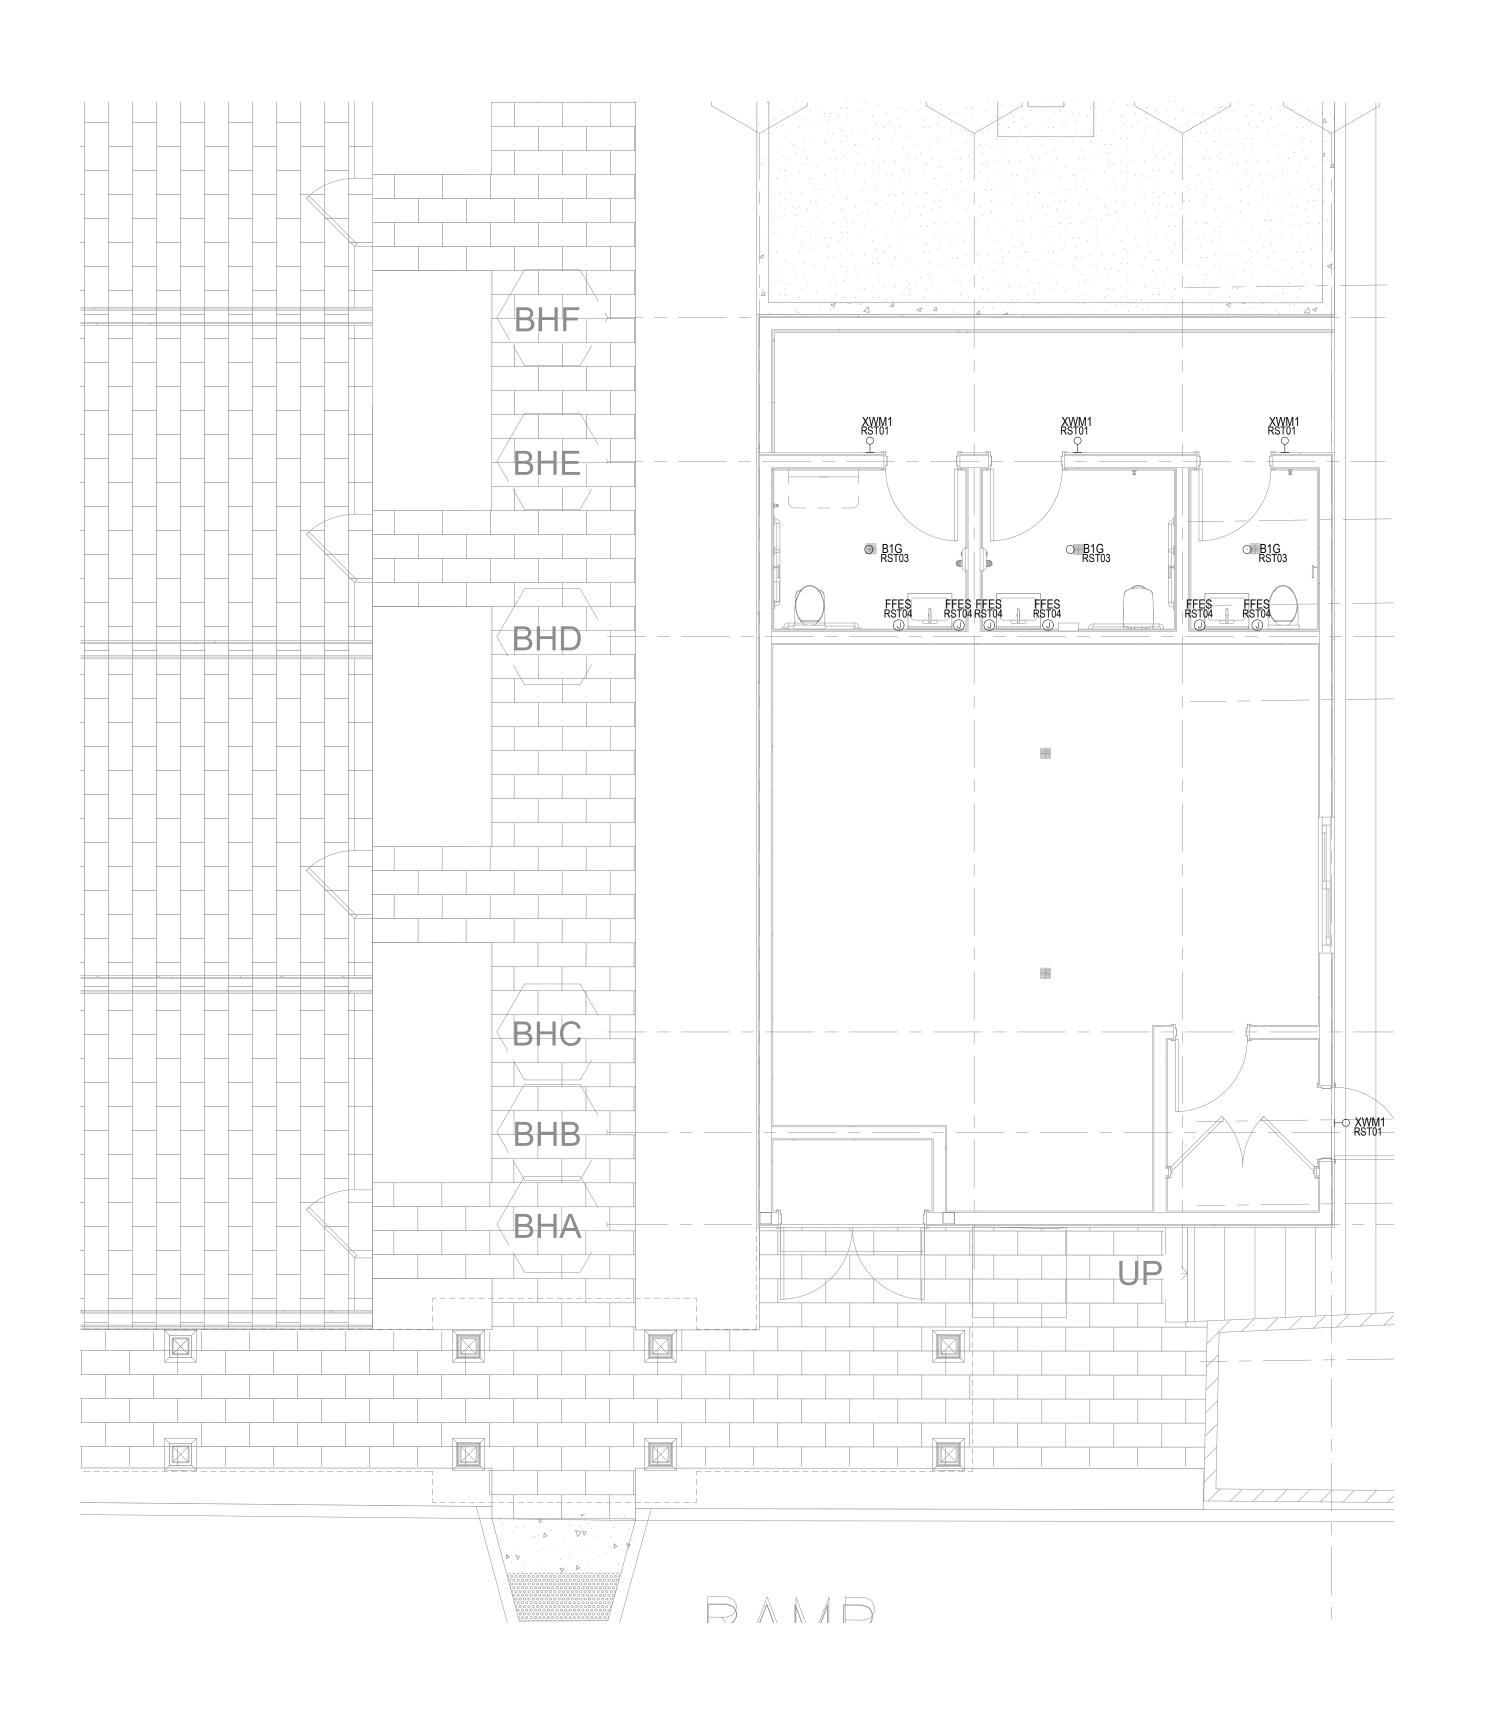




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TIKI BAR - ENLARGED FLOOR / RCP PLANS

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Beach House

HILTON HEAD ISLAND
project logo

KITCHEN / RESTROOM BLD

KITCHEN / RESTROOM BLDG - ENLARGED FLOOR / RCP PLANS

DRB

sheet title

project no. 000000 date 08/15/23

checked by: Checker
drawn by: Author


LT3.30


2 KITCHEN / RESTROOM BLDG - RCP

1/4" = 1'-0"

KITCHEN / RESTROOM BLDG - FLOOR PLAN

1/4" = 1'-0"

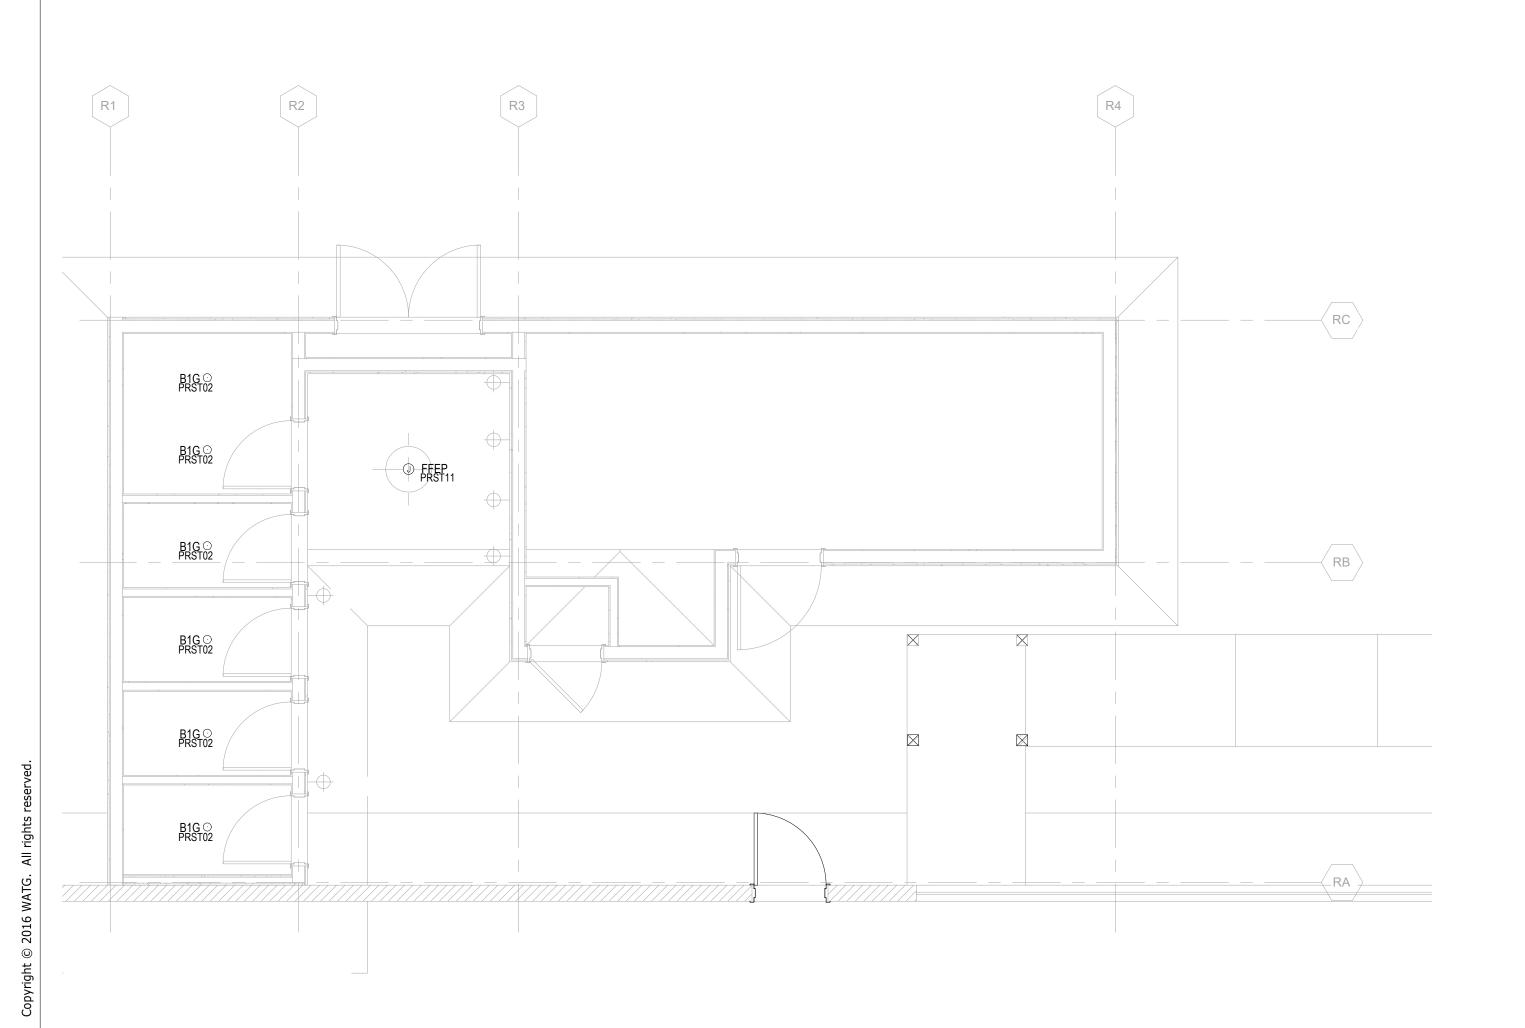

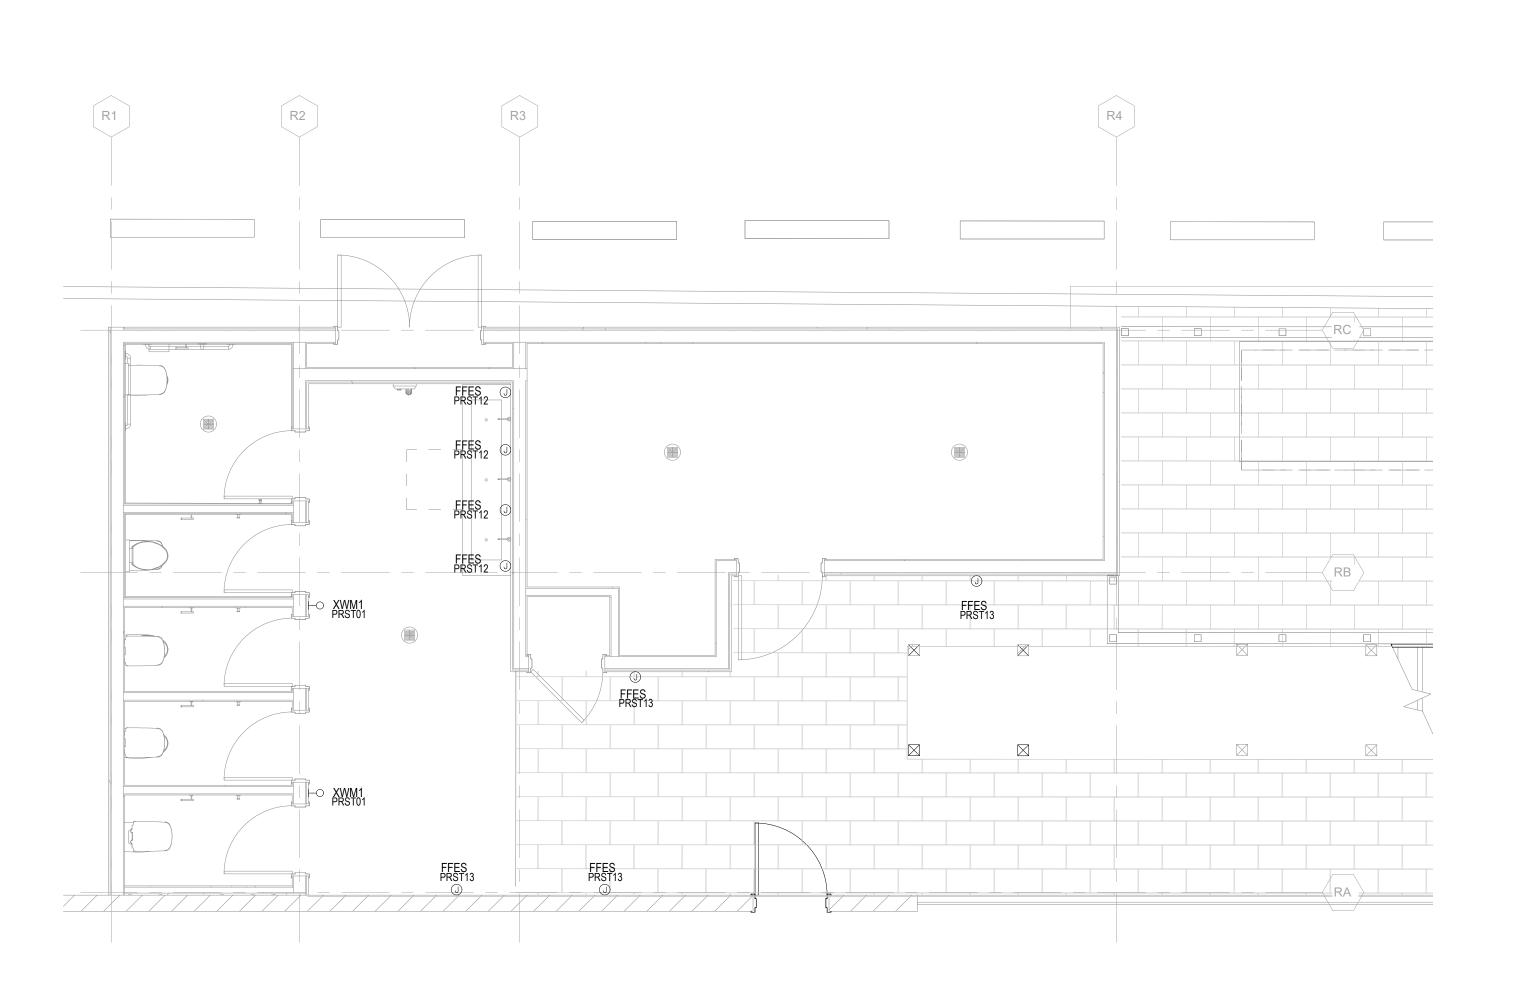

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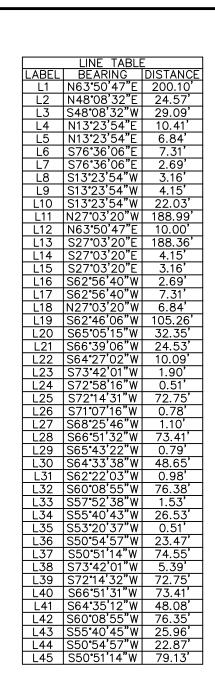
POOL RESTROOM BLDG -ENLARGED FLOOR / RCP

PLANS sheet title

checked by: Checker drawn by: Author

1 POOL RESTROOM BLDG - FLOOR PLAN

1/4" = 1'-0"



EXTERIOR DOOR FINISHED FLOOR ELEVATIONS FFE-EX: EXTERIOR FINISHED FLOOR ELEVATION

FFE-IN: INTERIOR FINISHED FLOOR ELEVATION FFE-EX: 11.37 FFE-IN: 11.38' DOOR-B: FFE-EX: 11.02 FFE-IN: 11.03' DOOR-C: FFE-EX: 10.79' FFE-IN: 10.83' FFE-EX: 11.24' FFE-IN: 11.29' DOOR-E: FFE-EX: 11.06 FFE-IN: 11.11' FFE-EX: 11.07' FFE-IN: 11.12' FFE-EX: 11.11 FFE-IN: 11.14' DOOR-H: FFE-EX: 11.12 FFE-IN: 11.15' FFE-EX: 11.21'

> FFE-IN: 11.24' FFE-EX: 11.13' FFE-IN: 11.14' DOOR-K: FFE-EX: 11.07' FFE-IN: 11.07' DOOR-L: FFE-EX: 11.00' FFE-IN: 11.00' DOOR-M: FFE-EX: 10.95' FFE-IN: 10.95' DOOR-N:

FFE-IN: 10.85' DOOR-O: FFE-EX: 11.13' FFE-IN: 11.18' FFE-EX: 11.11' FFE-IN: 11.15' DOOR-Q: FFE-EX: 11.32' FFE-IN: 11.33'

FFE-EX: 10.76'

DOOR-R: FFE-EX: 11.18' FFE-IN: 11.18' DOOR-S: FFE-EX: 11.49' FFE-IN: 11.54' DOOR-T:

FFE-EX: 11.40' FFE-IN: 11.41' DOOR-U: FFE-EX: 11.40' FFE-IN: 11.42' DOOR-V: FFE-EX: 11.38'

FFE-IN: 11.45' DOOR-W: FFE-EX: 11.37' FFE-IN: 11.37' DOOR-X: FFE-EX: 11.25'

FFE-IN: 11.26' DOOR-Y: FFE-EX: 11.25' FFE-IN: 11.36' FFE-EX: 11.42' FFE-IN: 11.44'

DOOR-Z: DOOR-MAIN: FFE-EX: 11.05' FFE-IN: 11.05'

LOT CORNERS STATE PLANE COORDINATES

1. N: 112,328.09 E: 2,076,510.25 2. N: 112,416.33 E: 2,076,689.63 3. N: 112,221.79

E: 2,076,785.33 4. N: 112,309.99 E: 2,076,964.94 5. N: 112,109.83 E: 2,077,063.41

E: 2,077,131.40 7. N: 111,762.76 E: 2,076,788.44 8. N: 111,933.24

E: 2,076,704.51

6. N: 111,971.65

MISC. DECKS & STRUCTURES (FFE'S & BUILDING ELEVATIONS)

> STRUCTURE: DECK-1: FFE: 14.18' DECK-2: FFE: 12.19' DECK-3: FFE: 23.74' DECK-4: FFE: 12.65' TIKI BAR: FFE: 11.85' ELEV: 27.72' POOL-BATH: FFE: 11.41' ELEV: 29.55' METAL SHED-1: FFE: 11.10'

BEACH MANAGEMENT ACT DISCLOSURE STATEMENT

THE SETBACK LINE IS 36.05 LANDWARD FEET TO 57.11 LANDWARD FEET, FROM THE SEAWARD PROPERTY LINE. THE BASE LINE IS 15.75 LANDWARD FEET TO 36.59 LANDWARD FEET FROM THE SEAWARD PROPERTY LINE. THE VELOCITY ZONE, AS ESTABLISHED BY THE FEDERAL EMERGENCY MANAGEMENT ACT, IS LOCATED APPROXIMATELY 53.54 LANDWARD FEET TO 110.58 LANDWARD FEET IN RELATION TO THE PROPERTY. THE SEAWARD CORNERS OF THE HABITABLE STRUCTURES UPON THIS PROPERTY, IF ANY ARE LOCATED 182.87 LANDWARD TO 176.61 LANDWARD FEET FROM THE LINE, WHICH CORNERS ARE LOCATED N111965.52, E2076771.17 AND N111996.73, E2076834.39 UNDER THE SOUTH CAROLINA PLANE COORDINATE SYSTEM. THE PROPERTY HAS AN ANNUAL EROSION RATE OF 3.62 FEET PER YEAR, ACCORDING TO THE MOST RECENTLY ADOPTED EROSION RATES OF THE SOUTH CAROLINA OFFICE OF OCEAN AND COASTAL RESOURCE MANAGEMENT.

TOWN OF HILTON HEAD ISLAND LMO SECTION 16.5-112.B DISCLOSURE STATEMENT SOME OR ALL AREAS ON THIS PLAT ARE FLOOD HAZARD AREAS AND HAVE BEEN IDENTIFIED AS HAVING AT LEAST A ONE PERCENT CHANCE OF BEING FLOODED IN ANY GIVEN YEAR BY RISING TIDAL WATERS ASSOCIATED WITH POSSIBLE HURRICANES. LOCAL REGULATIONS REQUIRE THAT CERTAIN FLOOD HAZARD PROTECTIVE MEASURES BE INCORPORATED IN THE DESIGN AND CONSTRUCTION OF STRUCTURES IN THESE DESIGNATED AREAS. REFERENCE SHALL BE MADE TO THE DEVELOPMENT COVENANTS AND RESTRICTIONS OF THIS DEVELOPMENT AND REQUIREMENTS OF THE TOWN BUILDING OFFICIAL. IN ADDITION, FEDERAL LAW REQUIRES MANDATORY PURCHASE OF FLOOD INSURANCE AS A PREREQUISITE TO FEDERALLY INSURED MORTGAGE FINANCING IN

THESE DESIGNATED FLOOD HAZARD AREAS.

SHEET 1 DRAINAGE EASEMENT (PER REF. #1, 2 & 4) INSET 'A' BEACH ASSOCIATION HORIZ PROP REG
TMS R553 018 000 003B 0000
PB: 153 PG: 108 LOCATION OF FEMA FLOOD LINE 6' WOOD FENCE \_\_\_\_\_ (HALF BURRIED) ZONE AE ELEV. 9' 6' WOOD FENCE -LOCATION OF FEMA FLOOD LINE LOCATION OF FEMA FLOOD LINE ZONE VE ELEV. 12' LOCATION OF FEMA FLOOD LINE ZONE VE ELEV. 13' GEODETIC CK5654 LOCATION OF FEMA FLOOD LINE ZONE VE ELEV. 12' SHEET 2 LOCATION OF FEMA FLOOD LINE

TOTAL AREA: 4.624 ACRES ERROR OF PLAT CLOSURE: 1 IN 207,348 ERROR OF FIELD CLOSURE: 1 IN 241,845 1.3" PER ANGLE POINT ANGULAR ERROR: NO ADJUSTMENT ADJUSTED BY: EQUPIMENT USED: TOPCON PS ROBOTIC TOTAL STATION

05-10-2023

LEGEND

FIELD WORK COMPLETED ON:

△ CALC POINT - CORNER NOT SET CMF ■ CONC. MONUMENT FOUND PKS O PK NAIL SET RBF • IRON REBAR FOUND RBS O 5/8" IRON REBAR SET W/CAP AIR CONDITIONING UNIT BACK FLOW PREVENTER

BOLLARD OCJB CABLE JUNCTION BOX COMMUNICATIONS MANHOLE CONTROL PANEL ELECTRIC OUTLET

ELECTRIC STUBOUT FIRE DEPARTMENT CONNECTION FIRE HYDRANT

FIBER OPTIC BOX FLAG POLE GRATE INLET GROUND LIGHT GAS TANK

GAS VALVE HANDICAP PARKING IRRIGATION CONTROL VALVE LIGHT POLE

STORM DRAIN MANHOLE

SIGN SPIGOT SANITARY SEWER CLEAN OUT SANITARY SEWER MANHOLE

×12.9 SPOT ELEVATION

TRAFFIC SIGNAL BOX TRAFFIC SIGNAL POLE TELEPHONE JUNCTION BOX

TELEPHONE BOX TRANSFORMER-ELECTRIC UNDERGROUND FIBER OPTICS MARKER  $\bigcirc w$ WATER METER

WATER MANHOLE WATER VALVE POST YARD INLET

TRASH CAN NUMBER OF PARKING SPACES HOLLY HOL

LAUREL OAK LIVE OAK MAGNOLA PINE

PALMETTO BACK OF CURB BUILDING SETBACK LINE

CORRUGATED METAL PIPE COULD NOT ACCESS/ACQUIRE FINISHED FLOOR ELEVATION

INVERT ELEVATION PIPE DIRECTION POLYVINYL CHLORIDE PIPE

REINFORCED CONCRETE PIPE OCEAN & COASTAL RESOURCE MANAGEMENT

DETECTABLE WARNING SURFACE WATER SURFACE ELEVATION DOUBLE YELLOW LINE (SOLID)

SBA STOP BAR SINGLE BLUE LINE (SOLID) SINGLE DASHED WHITE LINE SINGLE WHITE LINE (SOLID)


SINGLE YELLOW LINE (SOLID) —8— CONTOUR LINE ---- × ---- FENCE LINE

—— тв —— TOP OF BANK ----- CPY ------ TREE CANOPY ----- SD ----- UNDERGROUND DRAINAGE LINE

--- TV --- UNDERGROUND TV LINE ---- w ---- UNDERGROUND WATER LINE

BRICK ↑ · · ^ CONCRETE DETECTABLE WARNING SURFACE EDGE OF PAVEMENT EDGE OF PAVEMENT (PERVIOUS) GRAVEL

> JEREMY W. REEDER S.C.P.L.S. No. 28139 NOT VALID UNLESS CRIMPED WITH SEAL

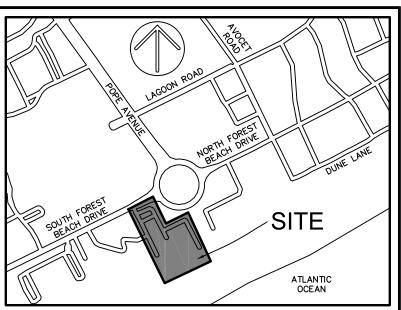

VICINITY MAP NOT TO SCALE

REFERENCES

I. PLAT BOOK: 136

S. PLAT BOOK: 145

PLAT BOOK: 129

1. FULL LEGEND, LINE & CURVE TABLES, AND SURVEY DATA ARE LOCATED ON COVER SHEET.

2. THIS PARCEL APPEARS TO LIE IN MULTIPLE FLOOD ZONES: X (0.2% CHANCE), AE (ELEVATION 9'), AO (DEPTH 1'), AND VE (ELEVATION 12'), DUAL COMMUNITIES 450025 (BEAUFORT COUNTY UNINCORPORATED AREAS) AND 450250 (TOWN OF HILTON HEAD ISLAND) MAP NUMBÉR 45013C0444G. HAVING AN EFFECTIVÉ DATE OF MARCH 23, 2021

3. CONTOURS ARE IN ONE FOOT INTERVALS. TREE SIZES SHOWN ARE IN INCHES OF DIAMETER. 4. VERTICAL DATUM IS NAVD 88.

5. BUILDING SETBACKS AND BUFFERS ARE PER THE TOWN OF HILTON HEAD, AND MUST BE VERIFIED PRIOR TO

6. HORIZONTAL DATUM IS SOUTH CAROLINA STATE PLANE GRID

THE EXISTENCE AND LOCATION OF THE SURFACE AND SUB-SURFACE UTILITIES SHOWN HEREON ARE BASED UPON AVAILABLE RECORDS AND SURFACE VISIBLE FEATURES ALONG WITH ELECTRONIC AND ACOUSTICAL EVIDENCE AS OF MAY 11 2023. THE EXTENT AND LIABILITY OF THIS INFORMATION IS LIMITED TO THE STANDARDS OF CARE FOR A SPECIFIC UTILITY INVESTIGATION AS DEFINED BY THE AMERICAN SOCIETY OF CIVIL ENGINEERS (ASCE) PUBLICATION 38-02. THE EXACT LOCATION AND DEPTH OF UNDERGROUND UTILITIES CANNOT BE ETERMINED WITHOUT EXPOSING THEM IN SOME WAY. PRIOR TO CONSTRUCTION OR EXCAVATION, IT IS REQUIRED BY LAW

TO CONTACT THE STATE 811 UTILITY PROTECTION CENTER.

HOUSE, Á HOLIDAY INN RESORT, AT #1 SOUTH FOREST BEACH, A SECTION OF FOREST BEACH, TOWN OF HILTON HEAD ISLAND. DATE: 10/25/2021 DATE: 02/28/2022 (REVISED) BY: TERRY G. HATCHELL, S.C.R.L.S. No. 11059

4. AN ALTA/NSPS LAND TITLE SURVEY OF THE BEACH



PREPARED FOR: ROBERTS CIVIL ENGINEERING, LLC. AN AS-BUILT / TREE AND TOPOGRAPHIC SURVEY OF

#1 SOUTH FOREST BEACH DRIVE

TAX PARCEL No. R553 018 000 003A 0000 HILTON HEAD ISLAND

BEAUFORT COUNTY, SOUTH CAROLINA

FIELD WORK: FIELD CHECK: DRAWN BY: JHJ
DATE: 06-05-2023
SCALE: 1"=60'
PROJECT No.: BFT-22206
FILE: BFT-22206 AT1.DWG

**COVER SHEET** 


SURVEYING, INC.


49 BROWN'S COVE ROAD, SUITE #5 RIDGELAND, SC 29936 PHONE: (843) 645-9277 WEBSITE: WWW.ATLASSURVEYING.COM





I HEREBY STATE THAT TO THE BEST OF MY PROFESSIONAL KNOWLEDGE, INFORMATION, AND BELIEF, THE SURVEY SHOWN HEREIN WAS MADE IN ACCORDANCE WITH THE REQUIREMENTS OF THE STANDARDS OF PRACTICE MANUAL FOR SURVEYING IN SOUTH CAROLINA, AND MEETS OR EXCEEDS THE REQUIREMENTS AS SPECIFIED THEREIN.

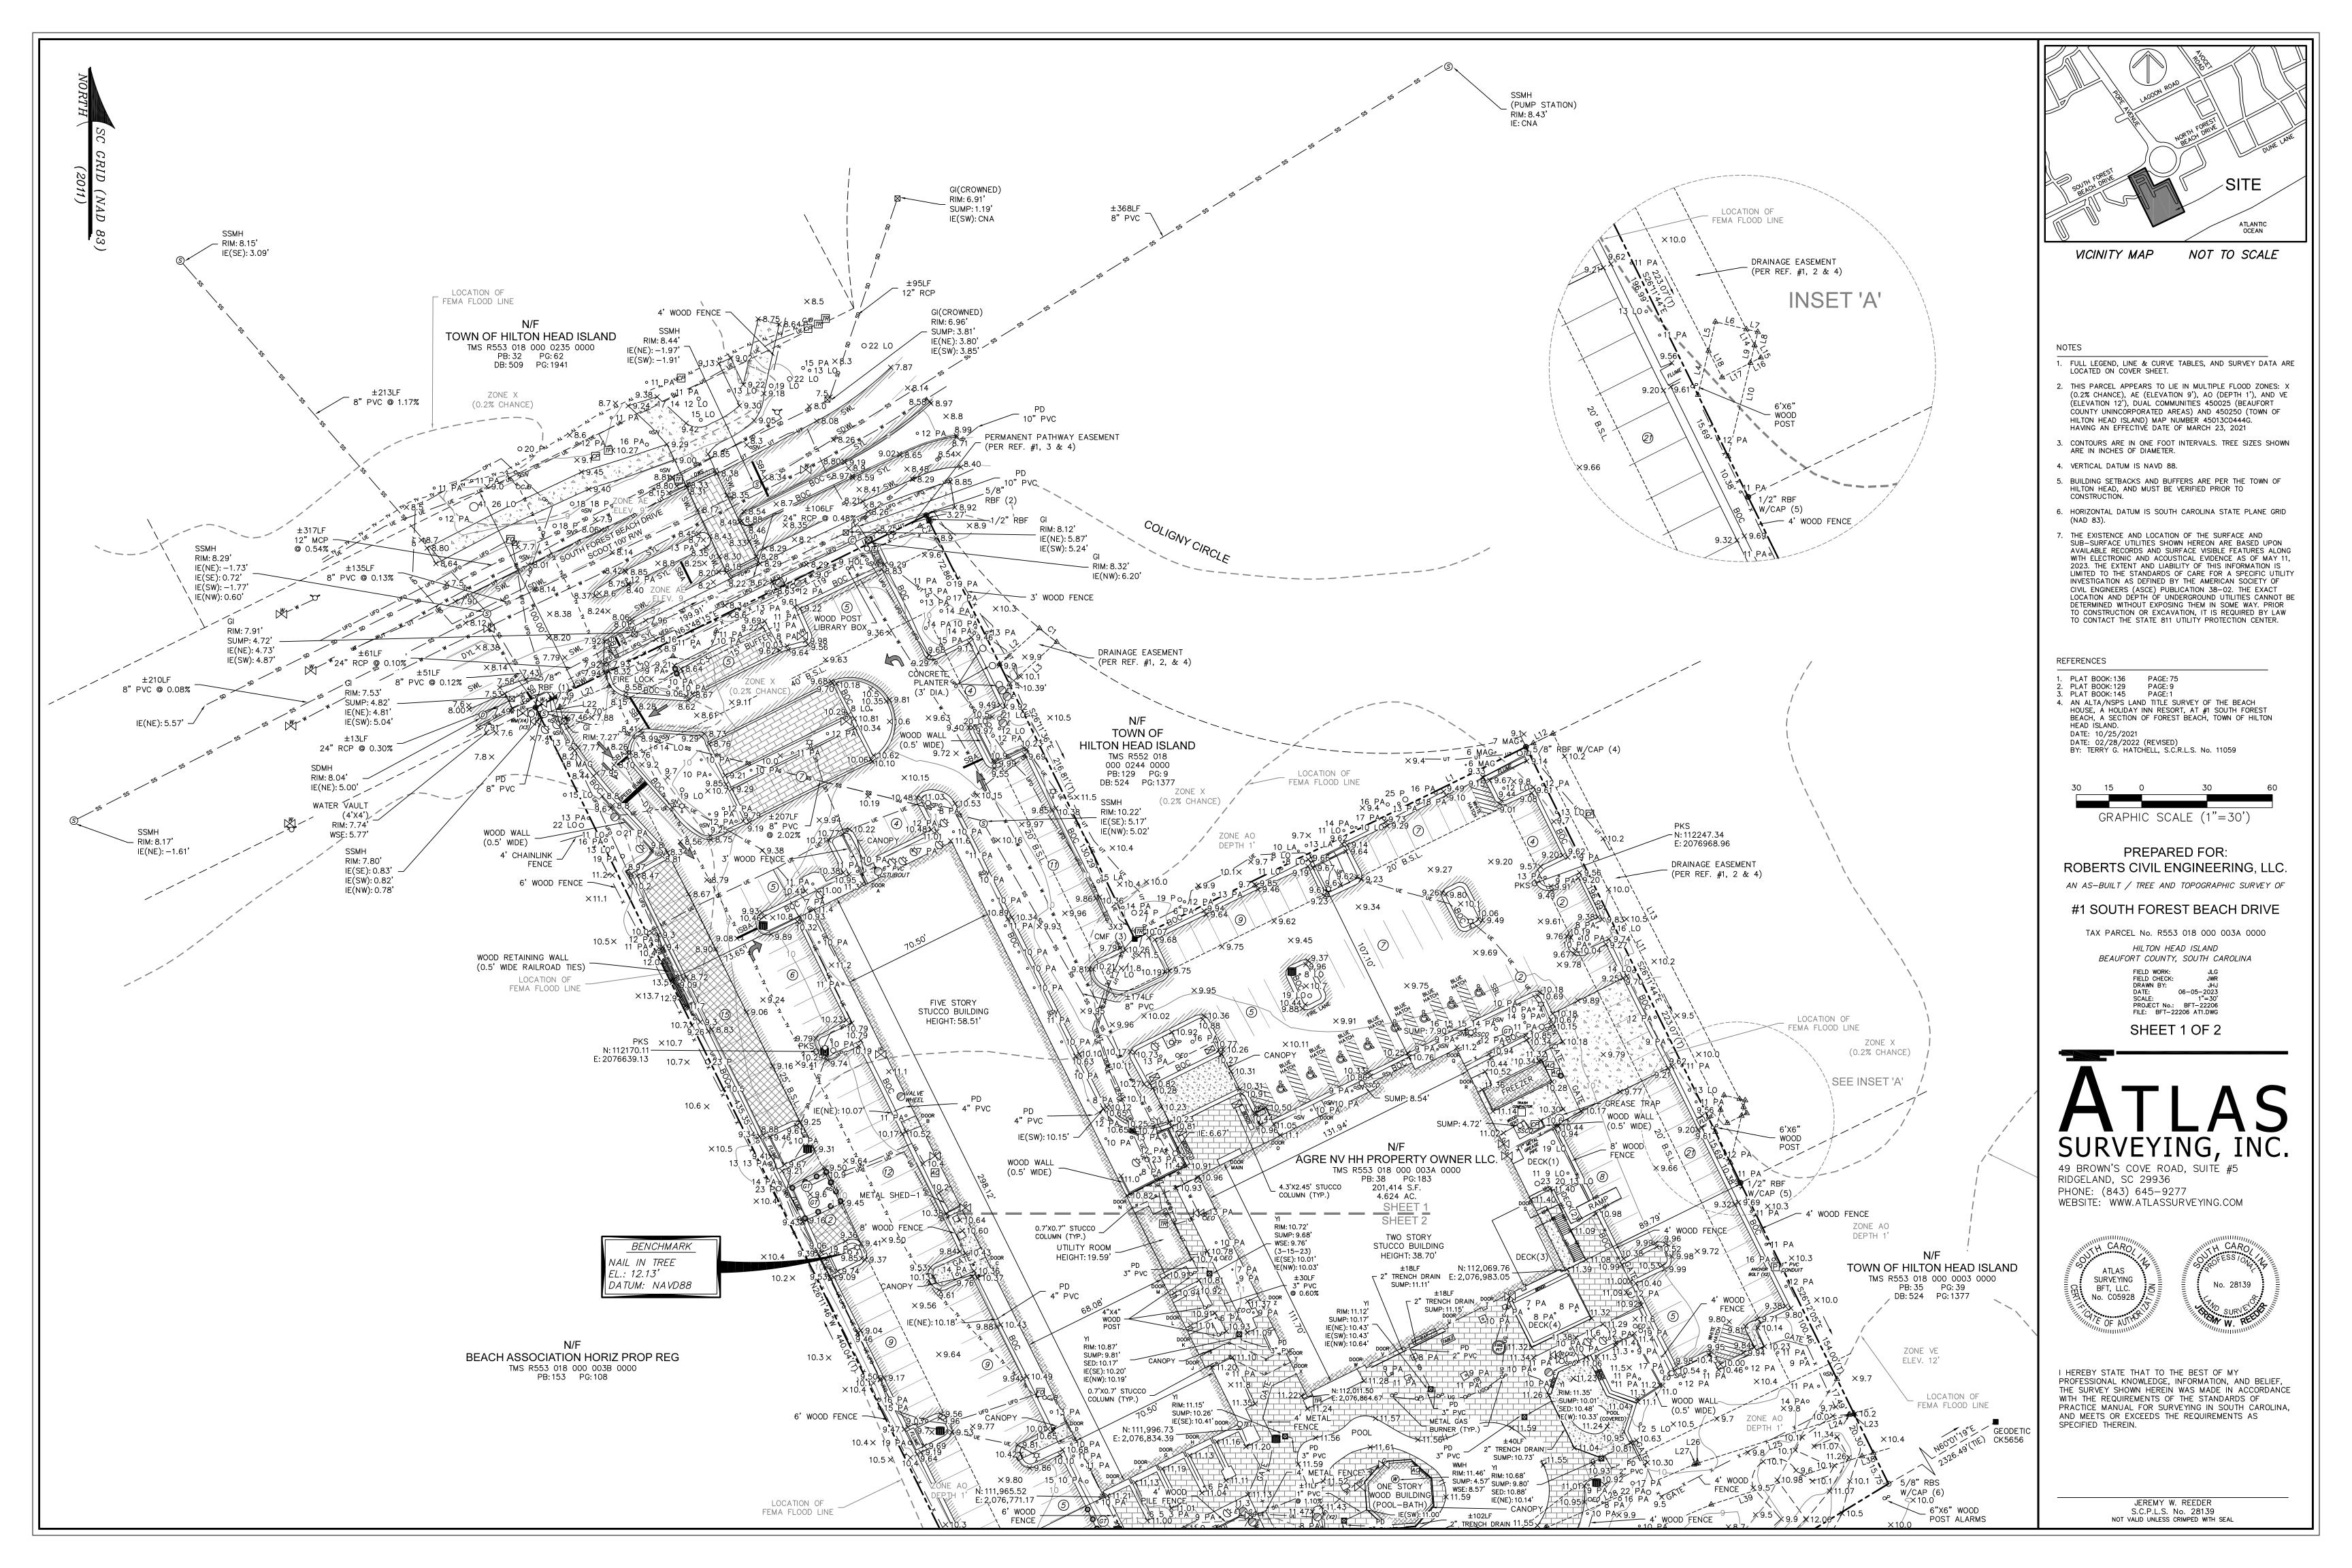

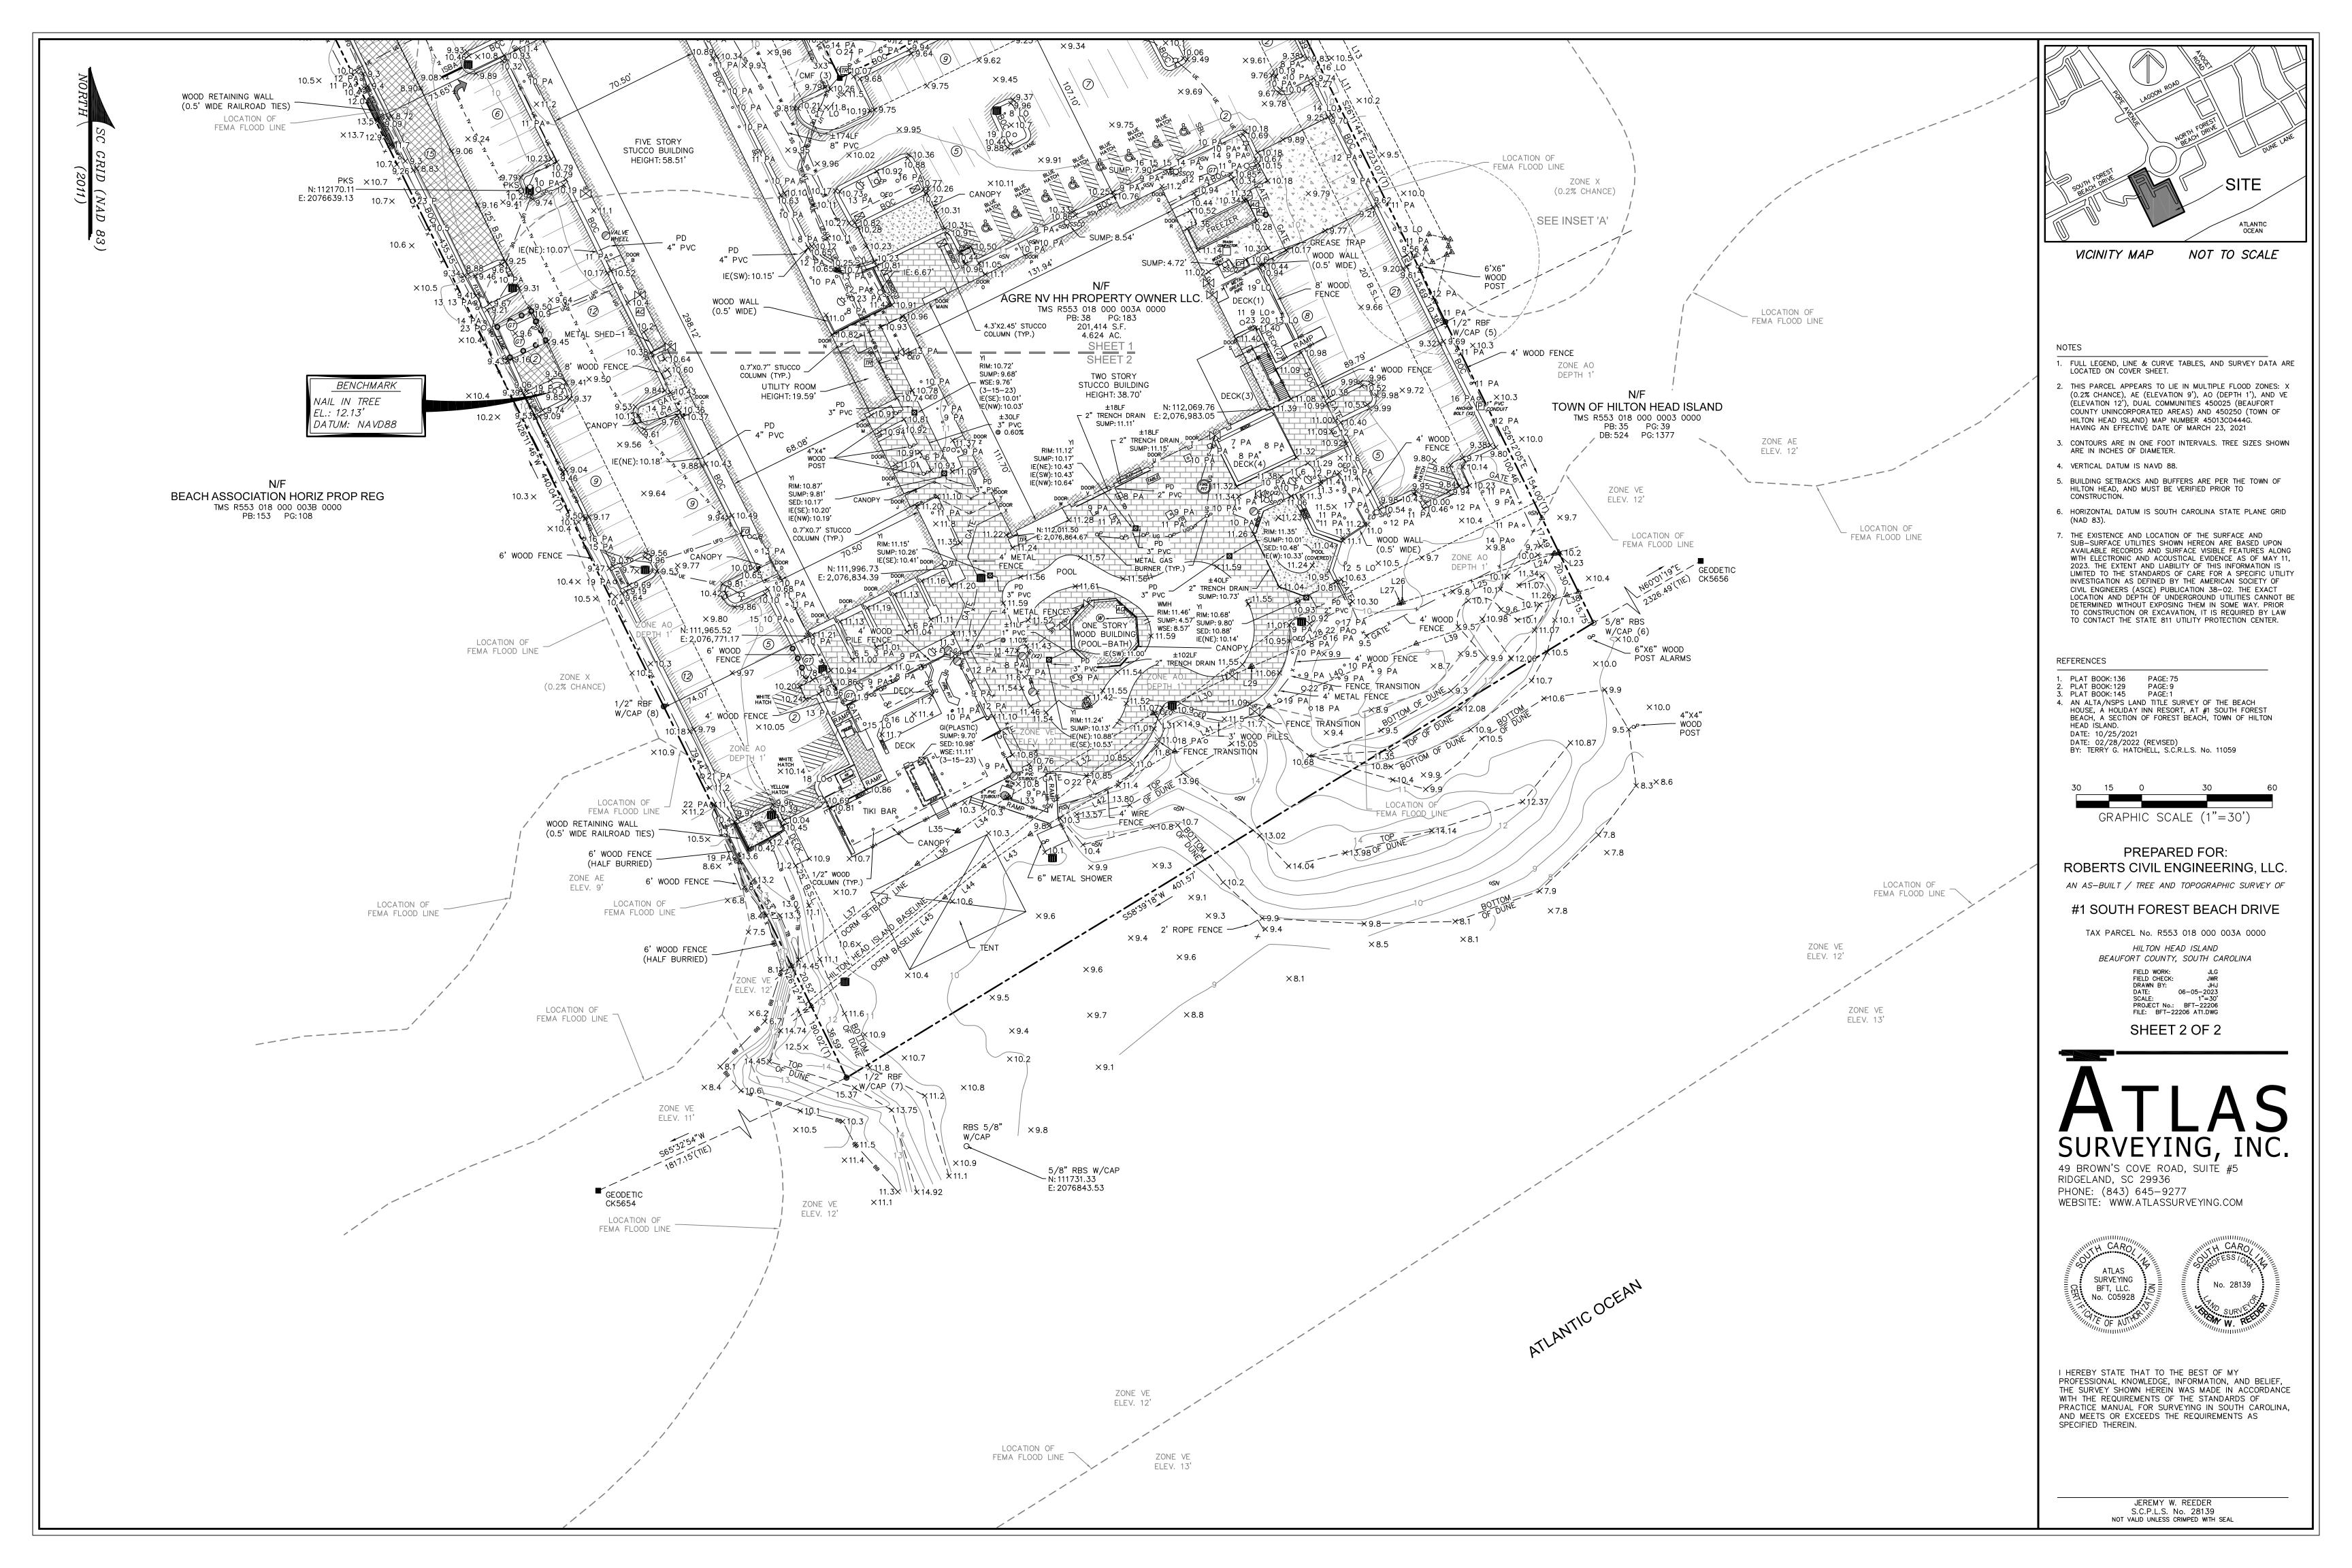

# SITE CONSTRUCTION PLANS

# HHI BEACH HOUSE HOTEL RENOVATION

PREPARED FOR: BEACH HOUSE RESPORT OWNER, LLC 444 MADISON AVENUE #14 NEW YORK, NY 10022 908-463-7474


WWW.ROBERTSCIVILENGINEERING.COM

301 SEA ISLAND ROAD, SUITE 10 ST. SIMONS ISLAND, GA 31522 912-638-9681

6001 CHATHAM CENTER DRIVE, SUITE 255 SAVANNAH, GA 31405 912-298-7006

14600 WHIRLWIND AVENUE, SUITE 119A JACKSONVILLE, FL 32218 904-741-0099

4000 FABER PLACE DRIVE, SUITE 300 NORTH CHARLESTON, SC 29405 843-323-4224

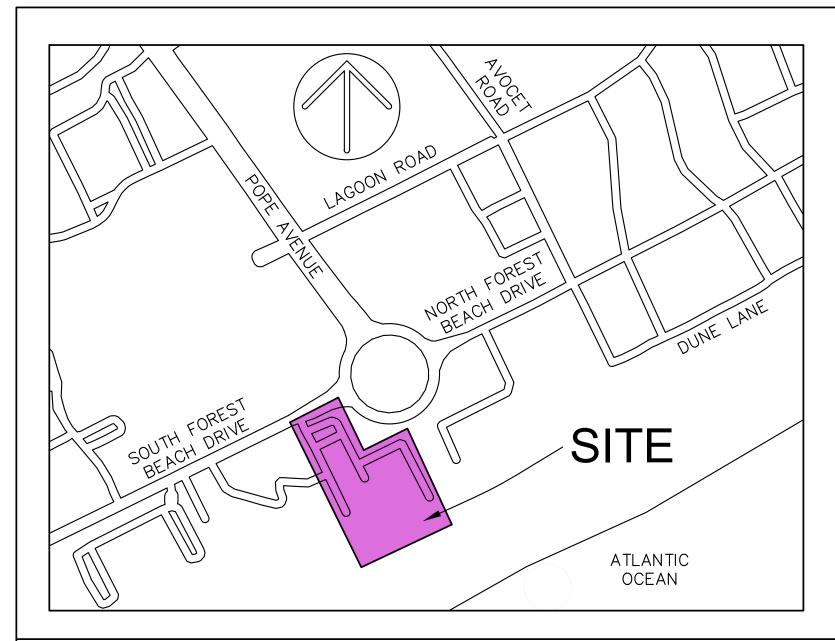

**VICINITY MAP** 

NTS

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EOS
INVESTORS

irvine | CA | 949 574 8500

TOWN OF HILTON HEAD ISLAND


HHI BEACH HOUSE HOTEL RENOVATION

BEACH HOUSE RESPORT OWNER, LLC JILL LEKSTUTIS jlekstutis@redhospitality.com

908-463-7474

**ENGINEER** ROBERTS CIVIL ENGINEERING Jonathan Roberts, P.E.

jroberts@robertscivilengineering.com

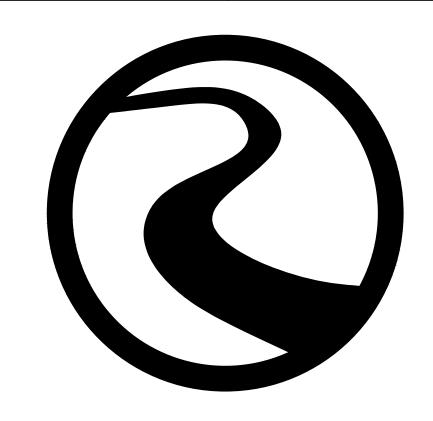

# ROBERTS CIVIL ENGINEERING

**REVISIONS** 

3						
4						
5						
03/15	/2023: ORIGINAL ISSUE DATE	RCE PROJECT NUMBER: 22905				
CONTENTS						
SHEE	:T	DATE				
1	GENERAL NOTES	07/11/23				
2A-2E	EXISTING CONDITIONS	07/11/23				
3	DEMOLITION PLAN	07/11/23				
4	STAKING PLAN	07/11/23				
5	GRADING AND DRAINAGE PI	_AN 07/11/23				
6	WATER AND SEWER PLAN	07/11/23				
D1-D3	CONSTRUCTION DETAILS	07/11/23				
	IMPERVIOUS AREA EXHIBITS	- PRE & POST 07/11/23				



Call before you dig

# **GENERAL NOTES:**

- 1. CONSTRUCTION METHODS AND MATERIALS SHALL CONFORM TO APPLICABLE FEDERAL, STATE, AND LOCAL
- 2. PERMITS NECESSARY FOR CONSTRUCTION SHALL BE OBTAINED BY CONTRACTOR.
- 3. DEVIATIONS FROM PLANS ARE PROHIBITED WITHOUT WRITTEN CONSENT OF THE ENGINEER.
- 4. CONTRACTOR IS TO IMMEDIATELY CONTACT ENGINEER IF ANY UNFORESEEN CONDITIONS OR DISCREPANCIES OCCUR.
- 5. CONTRACTOR SHALL COORDINATE CONSTRUCTION OF UTILITIES ON SITE WITH APPROPRIATE PROVIDER (I.E., POWER, PHONE, CABLE, ETC.).
- 6. ENGINEER IS NOT RESPONSIBLE FOR PHYSICAL CONSTRUCTION OF SITE.
- CONTRACTOR SHALL MAINTAIN A SAFE SITE AND MEET APPROPRIATE REGULATIONS CONCERNING SAFETY.
- 8. SURVEY DATA PROVIDED BY ATLAS SURVEYING, INC.
- A. DATE OF SURVEY 06-20-2022 B. SURVEYOR PROJECT OR FILE NO. BFT-22206
- 9. EXISTING SURVEY INFORMATION TO BE VERIFIED BY CONTRACTOR PRIOR TO CONSTRUCTION. CONTRACTOR TO NOTIFY ENGINEER OF DISCREPANCIES IN FIELD OBSERVATIONS VERSUS SURVEY DATA.
- 10. CONTRACTOR TO LOCATE UTILITIES PRIOR TO CONSTRUCTION BY CALLING "CALL BEFORE YOU DIG"
- 11. ACCORDING TO FEMA FLOOD INSURANCE RATEMAPS 45013C0444G DATED 3/23/2021. SITE IS LOCATED IN 100 YEAR FLOODPLAIN IN ZONE AO (DEPTH 1) AND ZONE X (0.2% ANNUAL CHANCE FLD HZRD).
- 12. HORIZONTAL DATUM BASED ON GEORGIA STATE PLANE COORDINATE SYSTEM, EAST ZONE NAD83. VERTICAL DATUM BASED ON GEORGIA STATE PLANE COORDINATE SYSTEM, EAST ZONE NAVD88.

- 1. CONTRACTOR IS RESPONSIBLE FOR ADHERING TO CURRENT ADA REQUIREMENTS.
- 2. EXTERIOR ACCESSIBLE ROUTE SHALL HAVE A MINIMUM WIDTH OF 3 FEET. IF ACCESSIBLE ROUTE CLEAR WIDTH IS LESS THAN 5 FEET, THEN 5'X5' PASSING SPACES SHALL BE PROVIDED EVERY 200' OR LESS. INTERSECTING SIDEWALKS MEET THIS REQUIREMENT.
- 3. FINISHED SURFACE HEIGHT DIFFERENCE REQUIREMENTS SHALL MEET FOLLOWING:
- A.  $0 \frac{1}{4}$ " NO REQUIREMENTS.
- B. 1/4"-1/2" BEVEL WITH 1:2 SLOPE. C. GREATER THAN ½" CONFORM TO RAMP REQUIREMENTS.
- 4. RAMPS SHALL MEET FOLLOWING CONSTRAINTS:
- A. MAX SLOPE 1:12. B. MAX RAMP RISE IS 30".
- . MAX RAMP LENGTH IS 30'.
- D. MAX CROSS SLOPE IS 2.00%.
- 5. RAMP LANDINGS SHALL MEET FOLLOWING CONSTRAINTS:
- A. A MINIMUM 5' LONG LEVEL LANDING AT LEAST AS WIDE AS RAMP SHALL BE PLACED AT TOP AND BOTTOM
- B. LANDING SHALL BE MINIMUM 5'X5' WHERE RAMP CHANGES DIRECTION. C. LANDINGS SHALL NOT EXCEED A 2.00% SLOPE.
- 6. HANDRAILS SHALL MEET FOLLOWING CONSTRAINTS:
- A. IF RAMP RISE IS GREATER THAN 6", THEN HANDRAILS ARE REQUIRED ON BOTH SIDES OF RAMP. B. MINIMUM OF 12" LONG HANDRAIL EXTENSIONS SHALL BE PROVIDED AT TOP AND BOTTOM OF LANDINGS.

# PROJECT NOTES:

- OWNER / DEVELOPER: A. NAME: BEACH HOUSE RESPORT OWNER, LLC
- B. CONTACT: JILL LEKSTUTIS, 908-463-7474, 908-463-7474
- C. ADDRESS: 444 MADISON AVENUE #14, NEW YORK, NY 10022 2. COUNTY NAME AND PARCEL / TAX MAP NUMBER(S): #### / ####
- 3. ZONING CLASSIFICATION: RD RESORT DEVELOPMENT

- a. ZONING DISTRICT RD b. OVERLAY DISTRICT - COR, TA-O, CPA-O, CRITICAL STORM PROTECTION AND DUNE
- ACCRETION AREA USE OF PROPERTY - RESORT ACCOMMODATIONS d. GROSS SITE ACRES - 4.624 ACRES (201,413.77 SF)
- NET SITE ACRES (GROSS ACRES-TIDAL WETLANDS) 4.624 ACRES ALLOWED TOTAL DENSITY (GFA/NET ACRES) - 8,000 GFA/ACRE (HILTON HEAD ISLAND, SOUTH CAROLINA - LAND MANAGEMENT ORDINANCE;
- CHAPTER 16-3: ZONING DISTRICTS; L. RESORT DEVELOPMENT (RD) DISTRICT; 3. DEVELOPMENT FORM AND PARAMETERS; MAX. DENSITY (PER NET ACRE);
- NONRESIDENTIAL: 8,000 GFA) PROPOSED DENSITY (GFA/NET ACRES) - 7,994 GFA/ACRE
- (36,967 GFA/4.624 ACRES) EXISTING BUILDING SQUARE FOOTAGE - 36,441 SF (14,844 SF + 20,820 SF + 777 SF)
- UNIT 1 + UNIT 2 + EXISTING BATHROOM/POOL PROPOSED BUILDING SQUARE FOOTAGE - 1,303 SF
- (526 SF+777 SF) KITCHEN + BATHROOM/POOL
- TOTAL SQUARE FOOTAGE (BUILDING) 36,967 SF (14,844 SF + 20,820 SF + 526 SF+777 SF)
- UNIT 1 + UNIT 2 + KITCHEN + BATHROOM/POOL MAXIMUM BUILDING HEIGHT ALLOWED - 75 FEET

AREA OF DISTURBANCE - 1.03 (AC.)

- PROPOSED BUILDING HEIGHT UNIT 2- 5 STORY STUCCO BUILDING 47.5' (+/-) HIGH, UNIT 1 2 STORY STUCCO BUILDING 20' (+/-)
- m. MAXIMUM ALLOWED IMPERVIOUS AREA AND PERCENTAGE (MAX ALLOWED IS 50%) -100,710 SF (50%)
- m.a. CURRENT IMPERVIOUS AREA AND PERCENTAGE 108,743 SF (54%) (108,743 SF /201,421 SF) m.b. PROPOSED IMPERVIOUS AREA AND PERCENTAGE - 108,733 (54%)
- (108,733 SF /201,421 SF) MINIMUM NUMBER OF PARKING SPACES REQUIRED (1 PER EVERY GUEST ROOM) - 202 EXISTING NUMBER OF PARKING SPACES ON SITE - 199 (INCL 9 HC SPACES)

# **EARTHWORK AND PAVING:**

- 1. UPPER 12 INCHES OF SUBGRADE BELOW PAVEMENT AND BUILDINGS SHALL BE SCARIFIED AND RECOMPACTED TO 100% STANDARD PROCTOR MAX DRY WEIGHT DENSITY WITH A MOISTURE CONTENT WITHIN 2% OF OPTIMUM MOISTURE CONTENT.
- 2. CONTRACTOR TO PROVIDE TEST RESULTS OF SUBGRADE AND BASE COURSE COMPACTION TO ENGINEER INCLUDING VOLUME ESTIMATES OF ANY UNSUITABLE SOILS TO BE REMOVED AND REPLACED THAT WERE IDENTIFIED DURING COMPACTION OPERATIONS PER ITEM NO. 1 ABOVE, IF ANY. CONTRACTOR SHALL NOT PROCEED WITH OVER-EXCAVATION AND REPLACEMENT OF UNSUITABLE SOILS WITHOUT WRITTEN AUTHORIZATION FROM ENGINEER OR OWNER.
- 3. FOR APPROVED AREAS OF OVER-EXCAVATION AND REPLACEMENT, CONTRACTOR TO REMOVE IDENTIFIED UNSUITABLE MATERIAL TO A DEPTH OF 3 FEET AND REPLACE WITH STRUCTURAL FILL.
- 4. IN AREAS WHERE STRUCTURAL FILL IS REQUIRED, FILL SHALL BE PLACED IN LIFTS OF 6 INCHES AND BE COMPACTED TO 100% STANDARD PROCTOR MAX DRY WEIGHT DENSITY. STRUCTURAL FILL SHALL CONSIST OF GRANULAR SOIL CONTAINING LESS THAN 10% MATERIAL PASSING THE NO 200 SIEVE.
- EXCAVATION AND FILL SHALL BE COMPLETED PRIOR TO INSTALLATION OF UTILITIES.

# **GRADING & DRAINAGE NOTES:**

- 1. STORM PIPES SHALL BE JOINED PER DOT SPECIFICATIONS.
- PIPING SHALL BE INSTALLED IN NEW CONDITION.
- 3. A RIGHT-OF-WAY WORK PERMIT MAY BE REQUIRED BEFORE ANY WORK CAN BE DONE IN RIGHT-OF-WAY.
- 4. STORM DRAINAGE PIPING SHALL BE CONSTRUCTED PER GA DOT SPECS.
- 5. STORM DRAINAGE PIPING JOINTS SHALL BE WRAPPED IN FILTER FABRIC.
- 6. CONTRACTOR TO REQUEST CONFIRMATION OF LATEST PLAN REVISION DATE FROM ENGINEER IN WRITING PRIOR TO ORDERING MATERIALS.
- 7. IT IS CONTRACTOR'S SOLE RESPONSIBILITY TO REVIEW AND APPROVE SHOP DRAWINGS PRIOR TO ORDERING MATERIALS.

# **GENERAL WATER NOTES:**

- 1. PVC PIPE SHALL BE BLUE IN COLOR. PIPE 4" TO 12" SHALL CONFORM TO REQUIREMENTS OF AWWA C-900, DR 18 PRESSURE CLASS 235 PSI AND SHALL HAVE FOLLOWING MINIMUM WALL THICKNESS:
- PIPE LESS THAN 4" IN DIAMETER SHALL CONFORM TO ASTM D-1784 AND D-2241 (SDR 21). PIPE SHALL HAVE A MINIMUM PRESSURE RATING OF 200 PSI. PVC PIPE SHALL BEAR NATIONAL SANITATION FOUNDATION SEAL OF APPROVAL.
- 2. FITTINGS FOR PVC SHALL BE DUCTILE IRON IN ACCORDANCE WITH ANSI A-21.53 (AWWA C-153). FITTINGS SHALL BE CEMENT LINED IN ACCORDANCE WITH ANSI A-21,4 (AWWA C-104). FITTINGS LESS THAN 4" SHALL BE
- 3. VALVES SHALL BE INSTALLED IN APPROVED UNDERGROUND VALVE BOXES OF DUCTILE IRON WITH A
- 4. MAINTAIN A 10' HORIZONTAL SEPARATION BETWEEN ANY EXISTING OR PROPOSED WATER MAIN AND
- 5. WHEN A 10' HORIZONTAL SEPARATION CANNOT BE MAINTAINED, WATER MAIN MAY BE LAID CLOSER TO SEWER PROVIDED THAT WATER MAIN IS LAID IN A SEPARATE TRENCH AT LEAST 18" ABOVE TOP OF SEWER.
- 6. WATER CROSSING A SEWER SHALL BE AT LEAST 18" ABOVE TOP OF SEWER. A FULL LENGTH (SECTION) OF WATER PIPE SHALL BE USED AT THESE CROSSINGS WITH ENDS OF WATER PIPE SECTION AS FAR AWAY FROM SEWER AS POSSIBLE.
- 7. VERIFY SIZE AND LOCATION OF WATER SERVICES PRIOR TO CONSTRUCTION. NOTIFY ENGINEER OF ANY DISCREPANCIES PRIOR TO ORDERING MATERIALS.

SDR 26. DEPTHS LESS THAN 3' SHALL BE DUCTILE IRON PIPE. ASTM D 2321 MUST BE FOLLOWED FOR DESIGNED TO PASS TESTS AT 73° F. PIPE STANDARD LENGTHS SHALL BE 12.5' (PLUS OR MINUS 1"). PIPE

NOM SIZE:	<b>OUTSIDE DIA:</b>	MIN WALL THIC
4"	4.215"	0.162"
6"	6.275"	0.241"
8"	8.400"	0.323"
10"	10.500"	0.404"
12"	12.500"	0.481"

- 2. JOINTS FOR PVC PIPE SHALL BE INTEGRAL WALL BELL AND SPIGOT WITH A RUBBER RING GASKET. THE
- ASTM C 478 AND DETAILS SHOWN ON PLANS. JOINTS SHALL BE TONGUE AND GROOVE SEALED WITH FLEXIBLE GASKETS OR MASTIC SEALANT. GASKETS SHALL BE O-RING OR EQUIVALENT TO TYPE A OR B "TYLOX" CONFORMING TO ASTM C 443. MASTIC SHALL BE EQUIVALENT TO "RAM-NEK" WITH PRIMER. CONTACT SURFACES OF MANHOLE JOINT SHALL HAVE PRIMER IN ACCORDANCE WITH MANUFACTURER'S
- 4. FRAMES AND COVERS SHALL BE EQUIVALENT OF NEENAH FOUNDRY CO. R-1668 TYPE "C" LID
- 5. MANHOLE STEPS SHALL BE EQUIVALENT TO M.A. INDUSTRIES, TYPE PS-1 OF PS-2 OR IMCO REINFORCED PLASTICS, INC. MODEL FRP. STEPS SHALL BE INSTALLED AT MANHOLE FACTORY AND IN ACCORDANCE WITH
- 7. #12 GAUGE SINGLE STRAND COPPER TRACING WIRE SHALL BE USED OVER ALL FORCE MAIN, SANITARY
- 8. SEWER EXCAVATIONS SHALL BE TO DESIRED DEPTHS SHOWN ON PLANS WITH ADHERENCE TO
- 9. SEWER PIPES SHALL BE LAID UPGRADE WITH SPIGOTS POINTING DOWNGRADE. ASSEMBLY OF JOINTS SHALL COMPLY WITH MANUFACTURER'S RECOMMENDATIONS. SEAL OPEN ENDS OF PIPES IF INSTALLATION IS INTERRUPTED. MANHOLE CONNECTIONS SHALL BE WATER TIGHT WITH USE OF FLEXIBLE WATER STOPS AND
- SHAPED TO FACILITATE GRAVITY SEWER FLOW TOWARDS OUTGOING PIPE. CHANNEL WIDTH SHALL MATCH PIPING SIZE. INVERT OF CHANNEL SHALL BE UNIFORMLY SLOPED BETWEEN INCOMING AND OUTGOING PIPES. TOP OF BENCH SHALL MATCH TOP OF LARGEST PIPE. SLOPE TOP OF BENCH 1" PER FOOT TOWARDS CHANNEL
- 11. MANHOLE TOP ELEVATIONS SHALL BE GREATER THAN OR EQUAL TO FIFTY (50) YEAR FLOOD ELEVATION. UNLESS WATERTIGHT COVERS ARE PROVIDED. OUTSIDE OF PAVED AREAS, MANHOLE TOP ELEVATION SHALL BE 1" ABOVE GROUND SURFACE IN DEVELOPED AREAS AND 6" ABOVE GROUND SURFACE IN UNDEVELOPED AREAS UNLESS SHOWN OTHERWISE ON PLANS. MANHOLES IN PAVED AREAS SHALL BE BUILT AS DESIGNATED BY ENGINEER. NO LEAKS IN MANHOLES ARE ACCEPTABLE.

4" DIA - 0.267"

6" DIA - 0.383" 8" DIA - 0.503"

10" DIA - 0.617" 12" DIA - 0.733"

- PVC WITH RING TITE RUBBER JOINTS CONFORMING TO ASTM D-3139.
- SUITABLE CRUSHING STRENGTH FOR LOCATION INSTALLED.
- SANITARY SEWER, STORM SEWER, OR SEWER MANHOLE.

- 8. IF UTILITY CONFLICT IS ENCOUNTERED IN FIELD, SEE UTILITY CONFLICT DETAIL.

## **GENERAL SEWER NOTES:**

1. PVC PIPE SHALL BE POLYVINYL CHLORIDE PLASTIC (PVC) AND SHALL MEET REQUIREMENTS OF ASTM D 3034 INSTALLATION OF PVC PIPE. RUBBER RINGS SHALL BE USED FOR CONTRACTION AND EXPANSION AT EACH JOINT. FITTINGS SHALL MEET SAME SPECIFICATION REQUIREMENTS AS PIPE. TESTS ON PVC PIPE SHALL BE SIZES AND DIMENSIONS SHALL BE AS SHOWN IN THE TABLE BELOW:

NOM SIZE:	OUTSIDE DIA:	MIN WALL THICKN
4"	4.215"	0.162"
6"	6.275"	0.241"
8"	8.400"	0.323"
10"	10.500"	0.404"
12"	12.500"	0.481"

- JOINTS SHALL CONFORM TO ASTM D 3212 AND GASKETS SHALL CONFORM TO ASTM F 477.
- 3. PRECAST CONCRETE MANHOLES SHALL BE REINFORCED CONCRETE CONSTRUCTED IN ACCORDANCE WITH INSTRUCTIONS.
- RECOMMENDATIONS OF STEP MANUFACTURER.
- 6. PIPE CONNECTIONS SHALL HAVE FLEXIBLE WATERTIGHT JOINTS AT POINT OF ENTRY OF ANY SEWER MAIN INTO MANHOLE. JOINT SHALL BE WEDGED RUBBER SHAPE EQUIVALENT TO "PRESS WEDGE II," OR A RUBBER SLEEVE EQUIVALENT TO "KOR-N-SEAL" OR 'LOCK JOINT."
- SEWER, AND SERVICE LATERAL LINES.
- OCCUPATIONAL AND SAFETY HEALTH ADMINISTRATION'S (OSHA) REGULATIONS. IN AREAS OF UNSUITABLE SOIL CONDITIONS, TRENCH MAY REQUIRE ADDITIONAL EXCAVATION AND BACKFILL WITH SAND, GRAVEL, OR
- RESILIENT CONNECTORS. 10. MANHOLES SHALL HAVE A NON-SHRINK GROUT CHANNEL IN BOTTOM THAT IS SMOOTH, ROUNDED, AND



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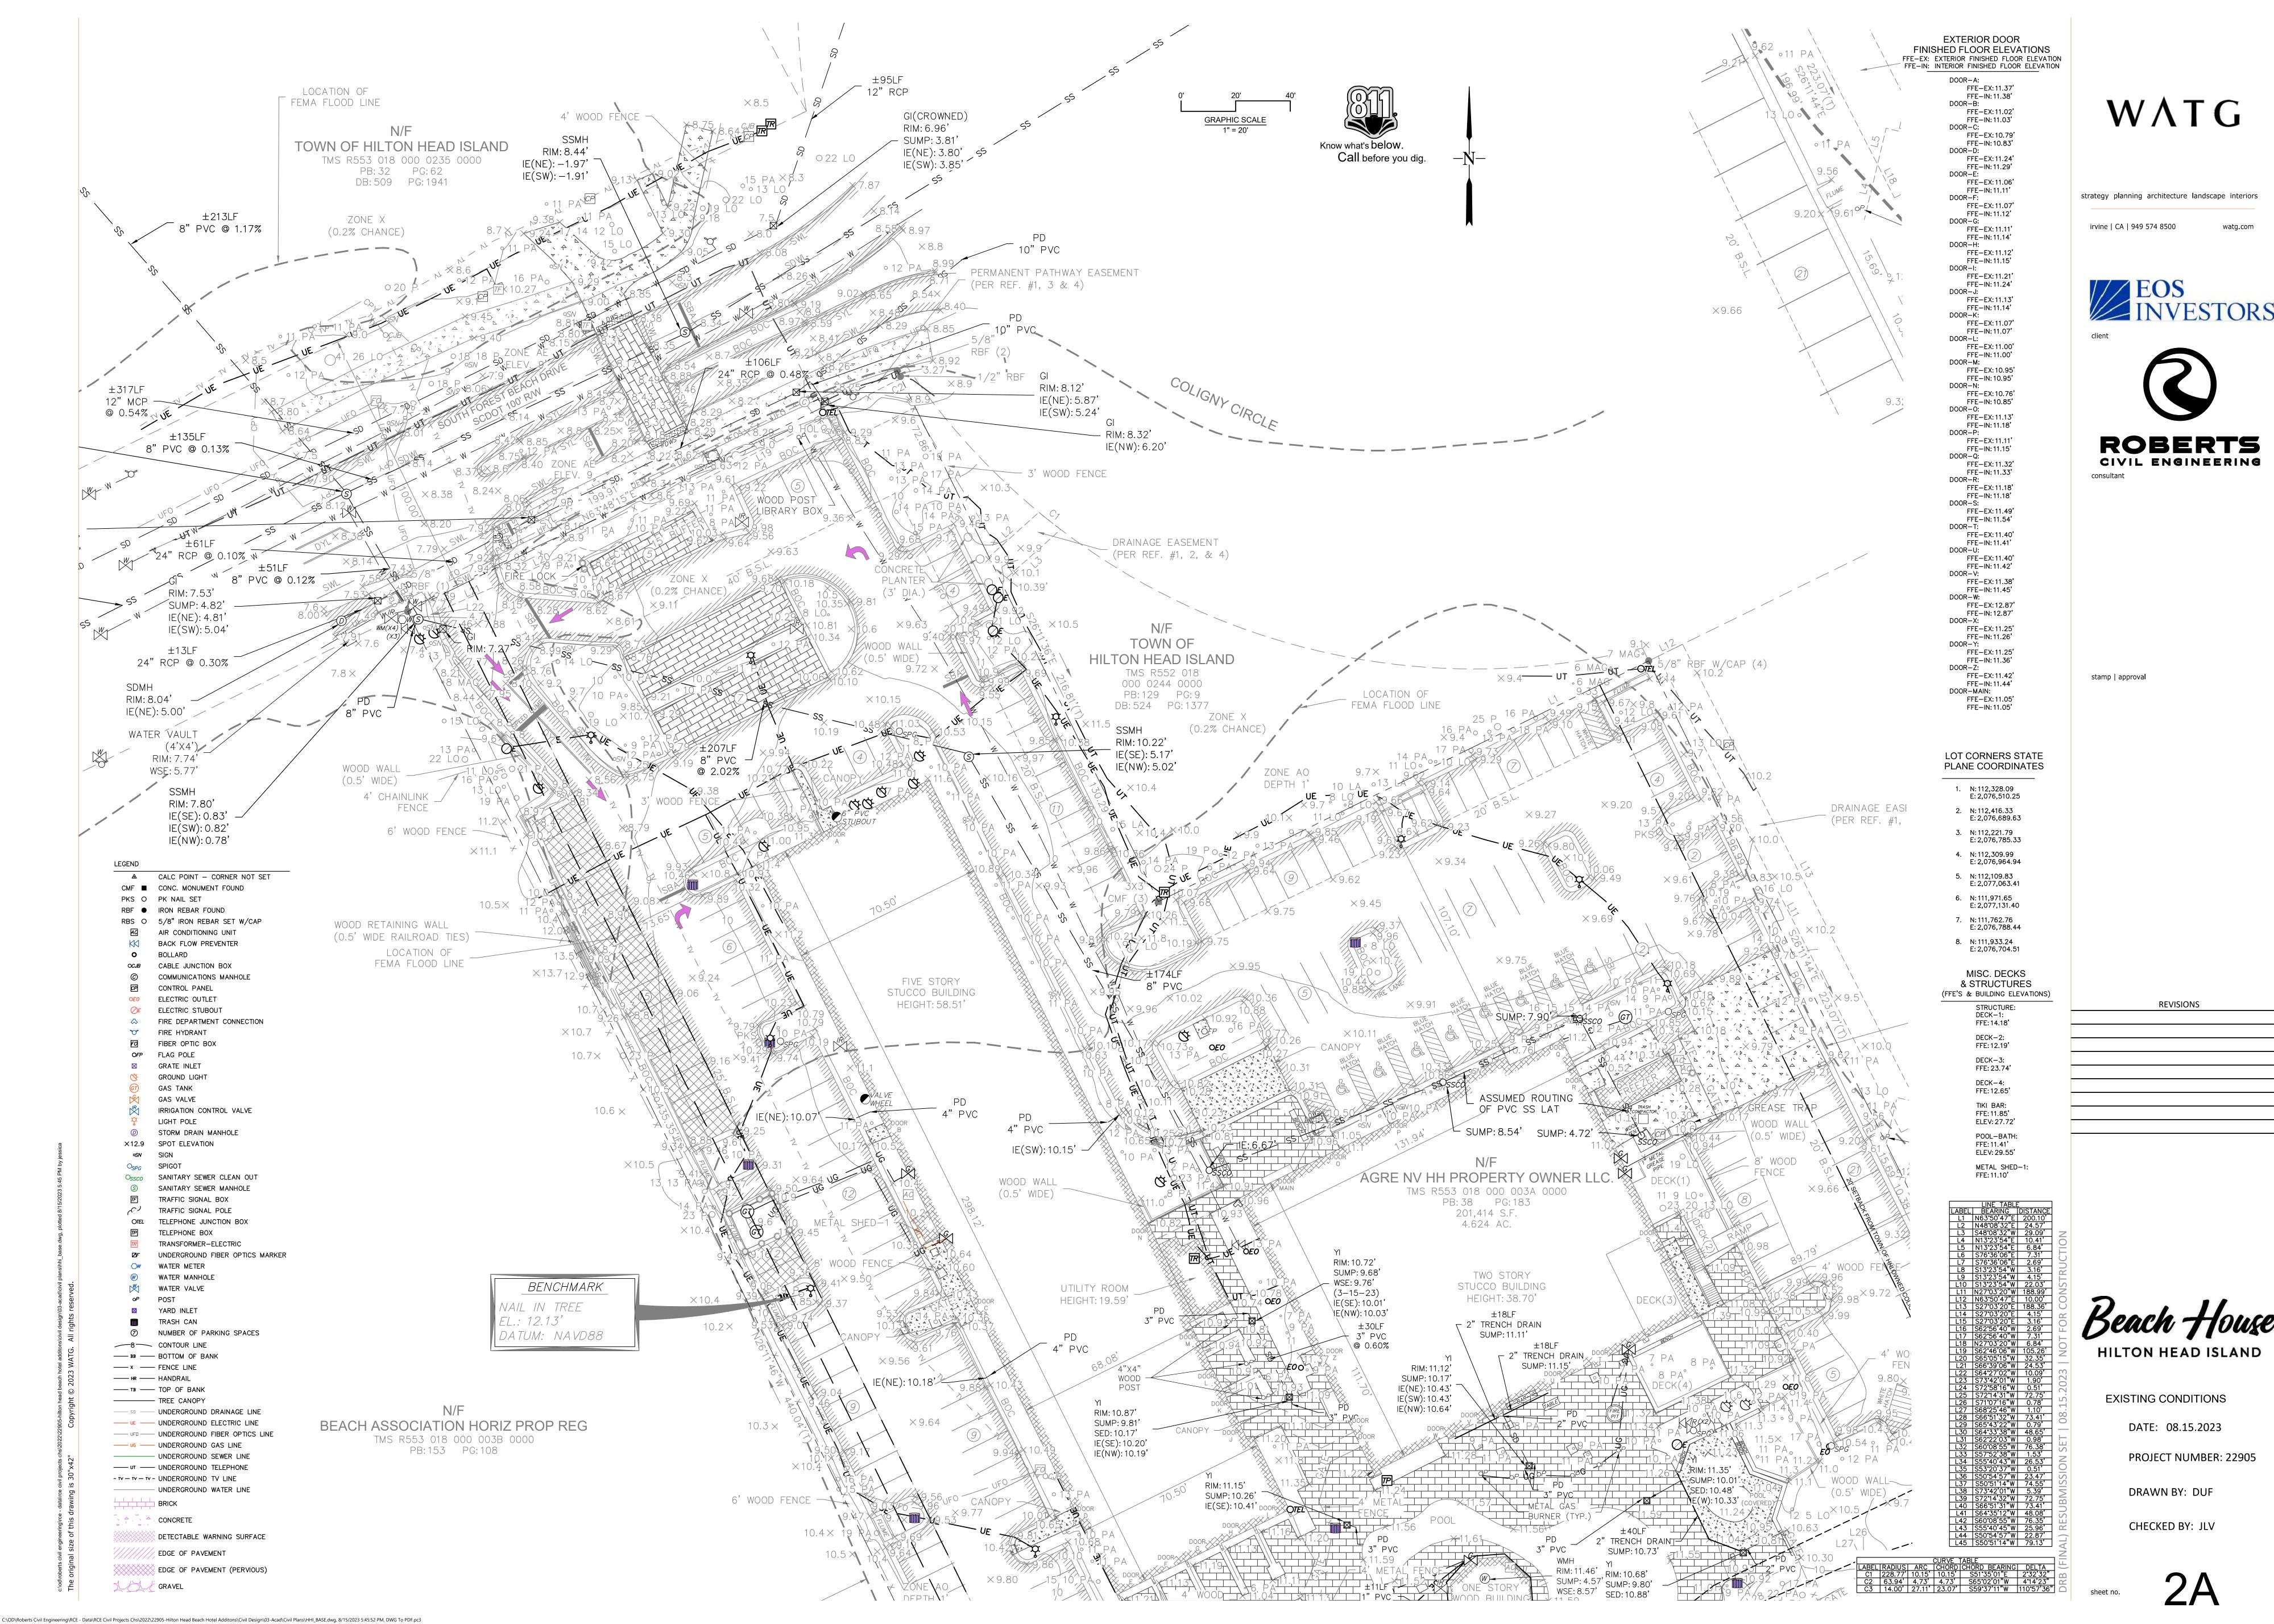
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DATE: 08.15.2023 PROJECT NUMBER: 22905

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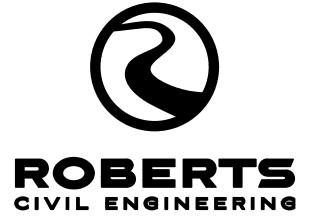
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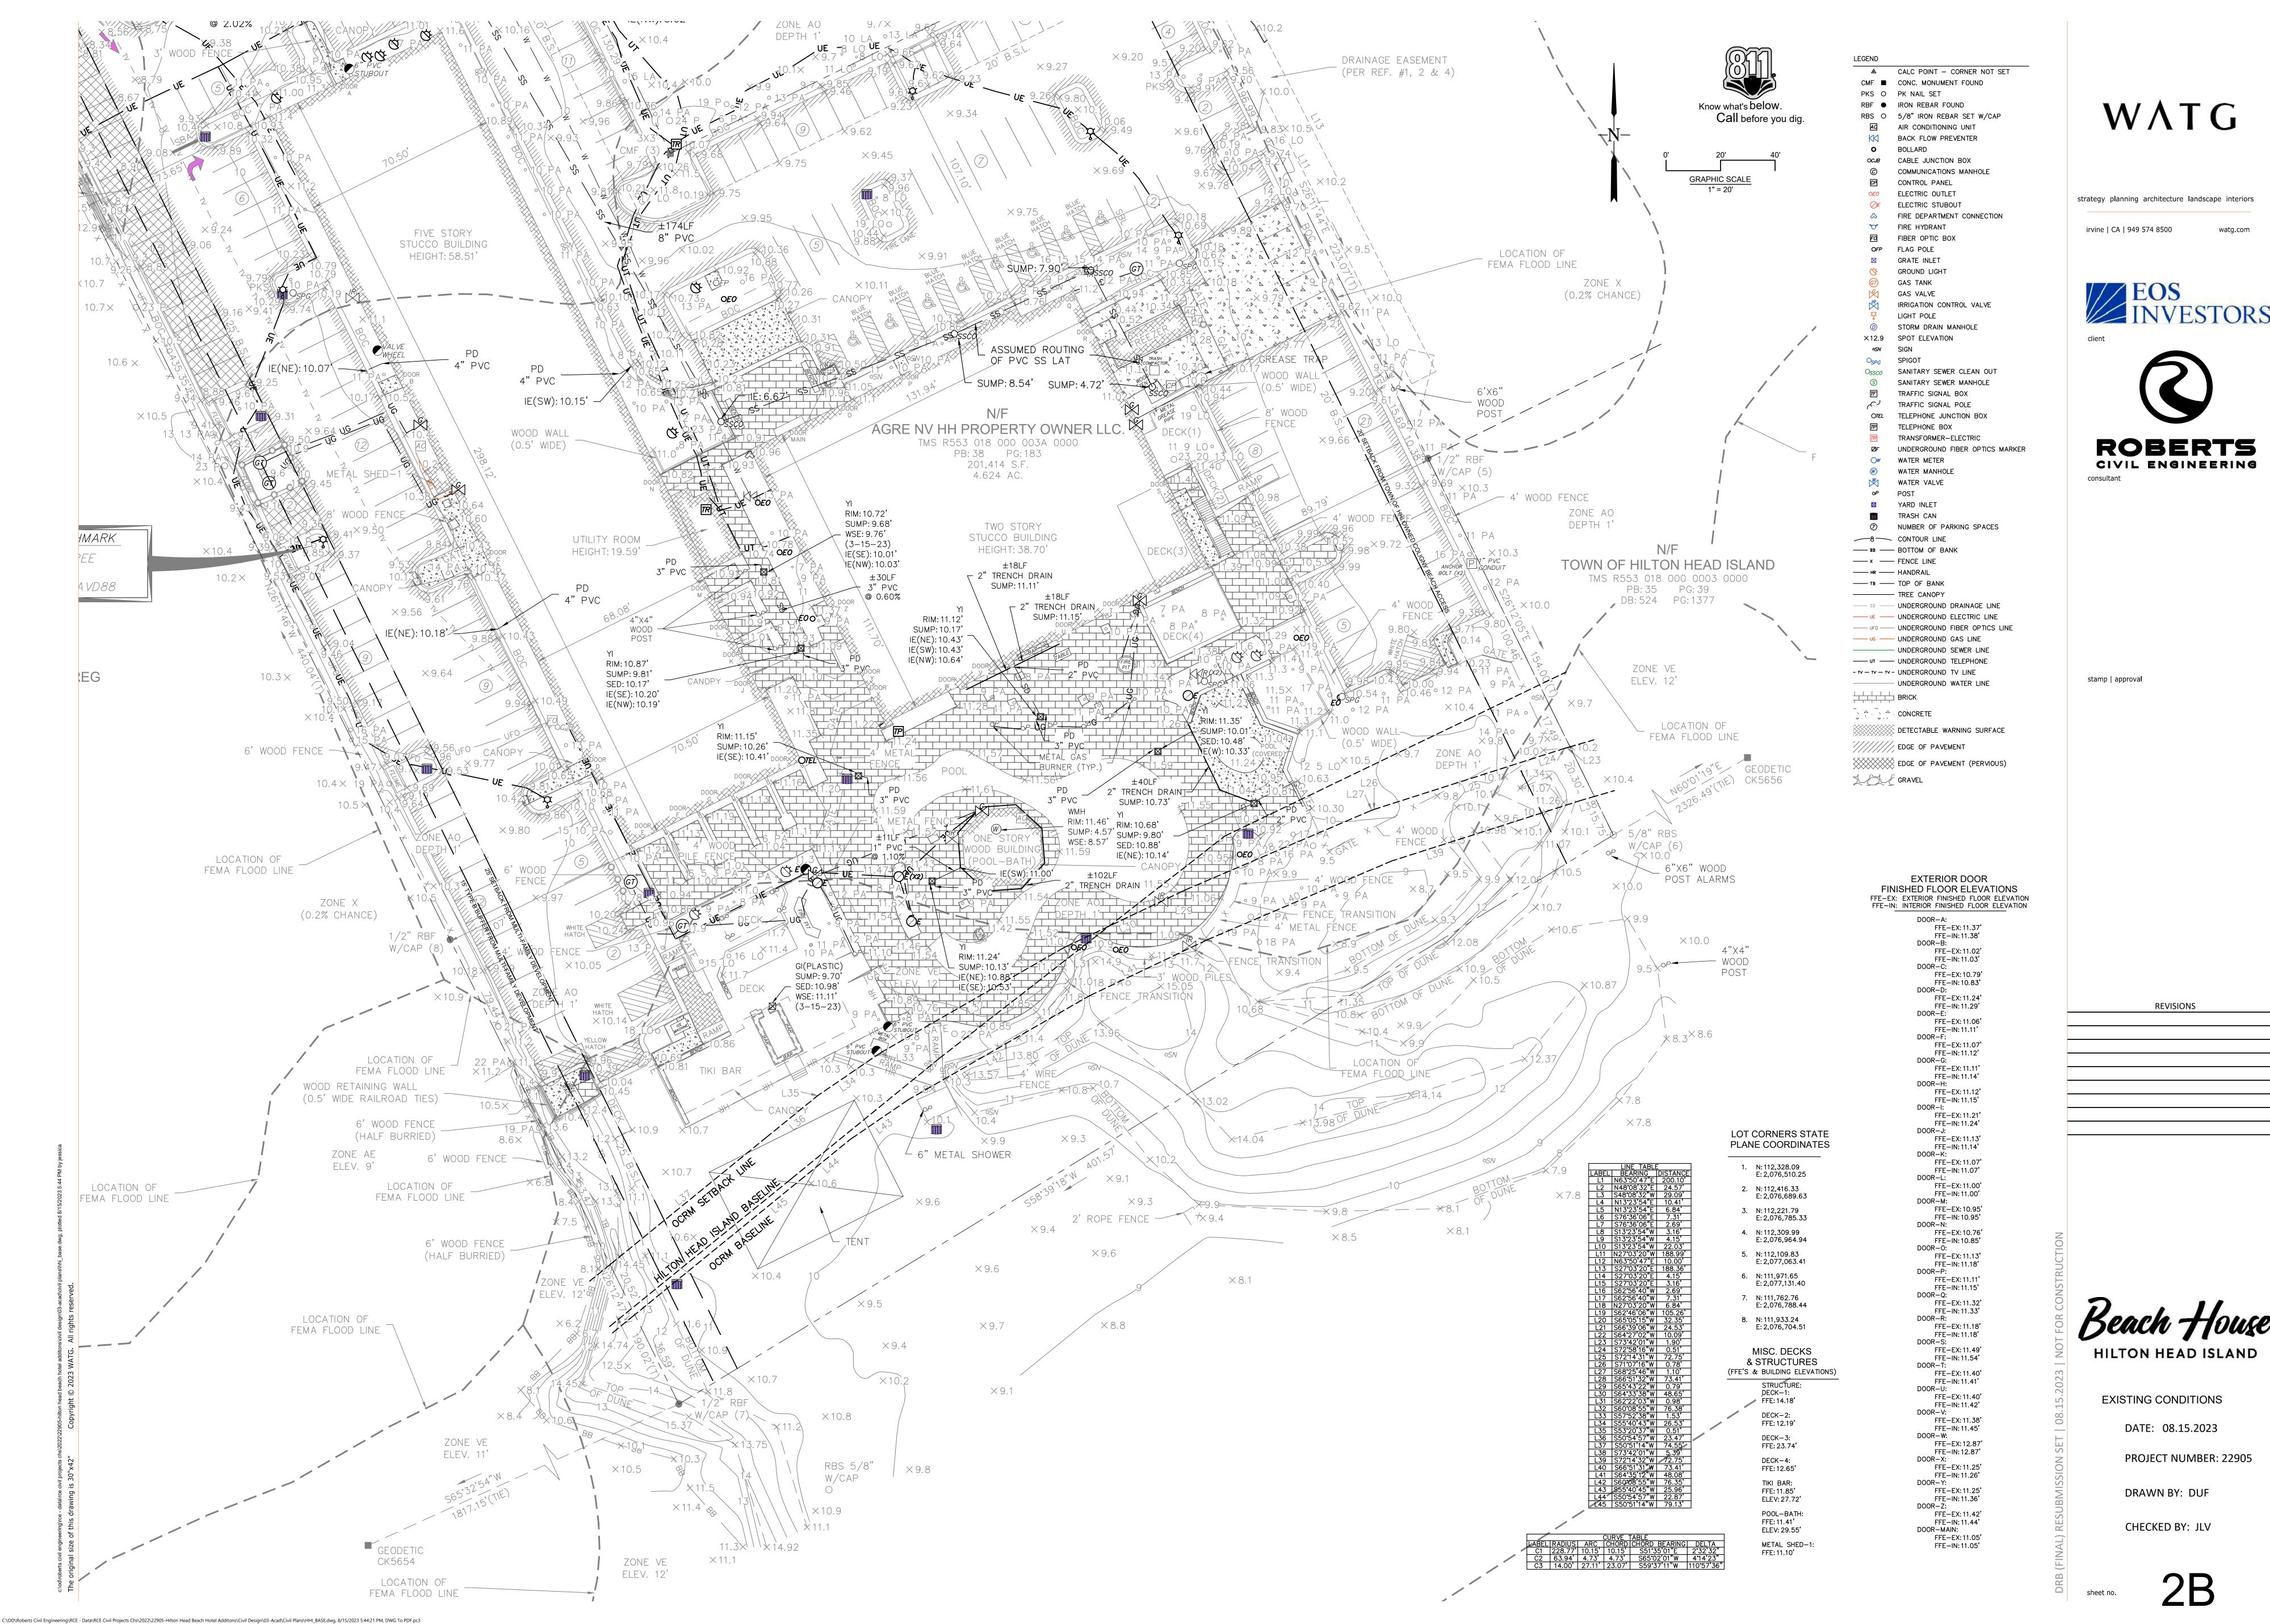
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Beach House

**EXISTING CONDITIONS** 



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**EOS**INVESTORS




**REVISIONS** 

**EXISTING CONDITIONS** 

DATE: 08.15.2023

PROJECT NUMBER: 22905

DRAWN BY: DUF

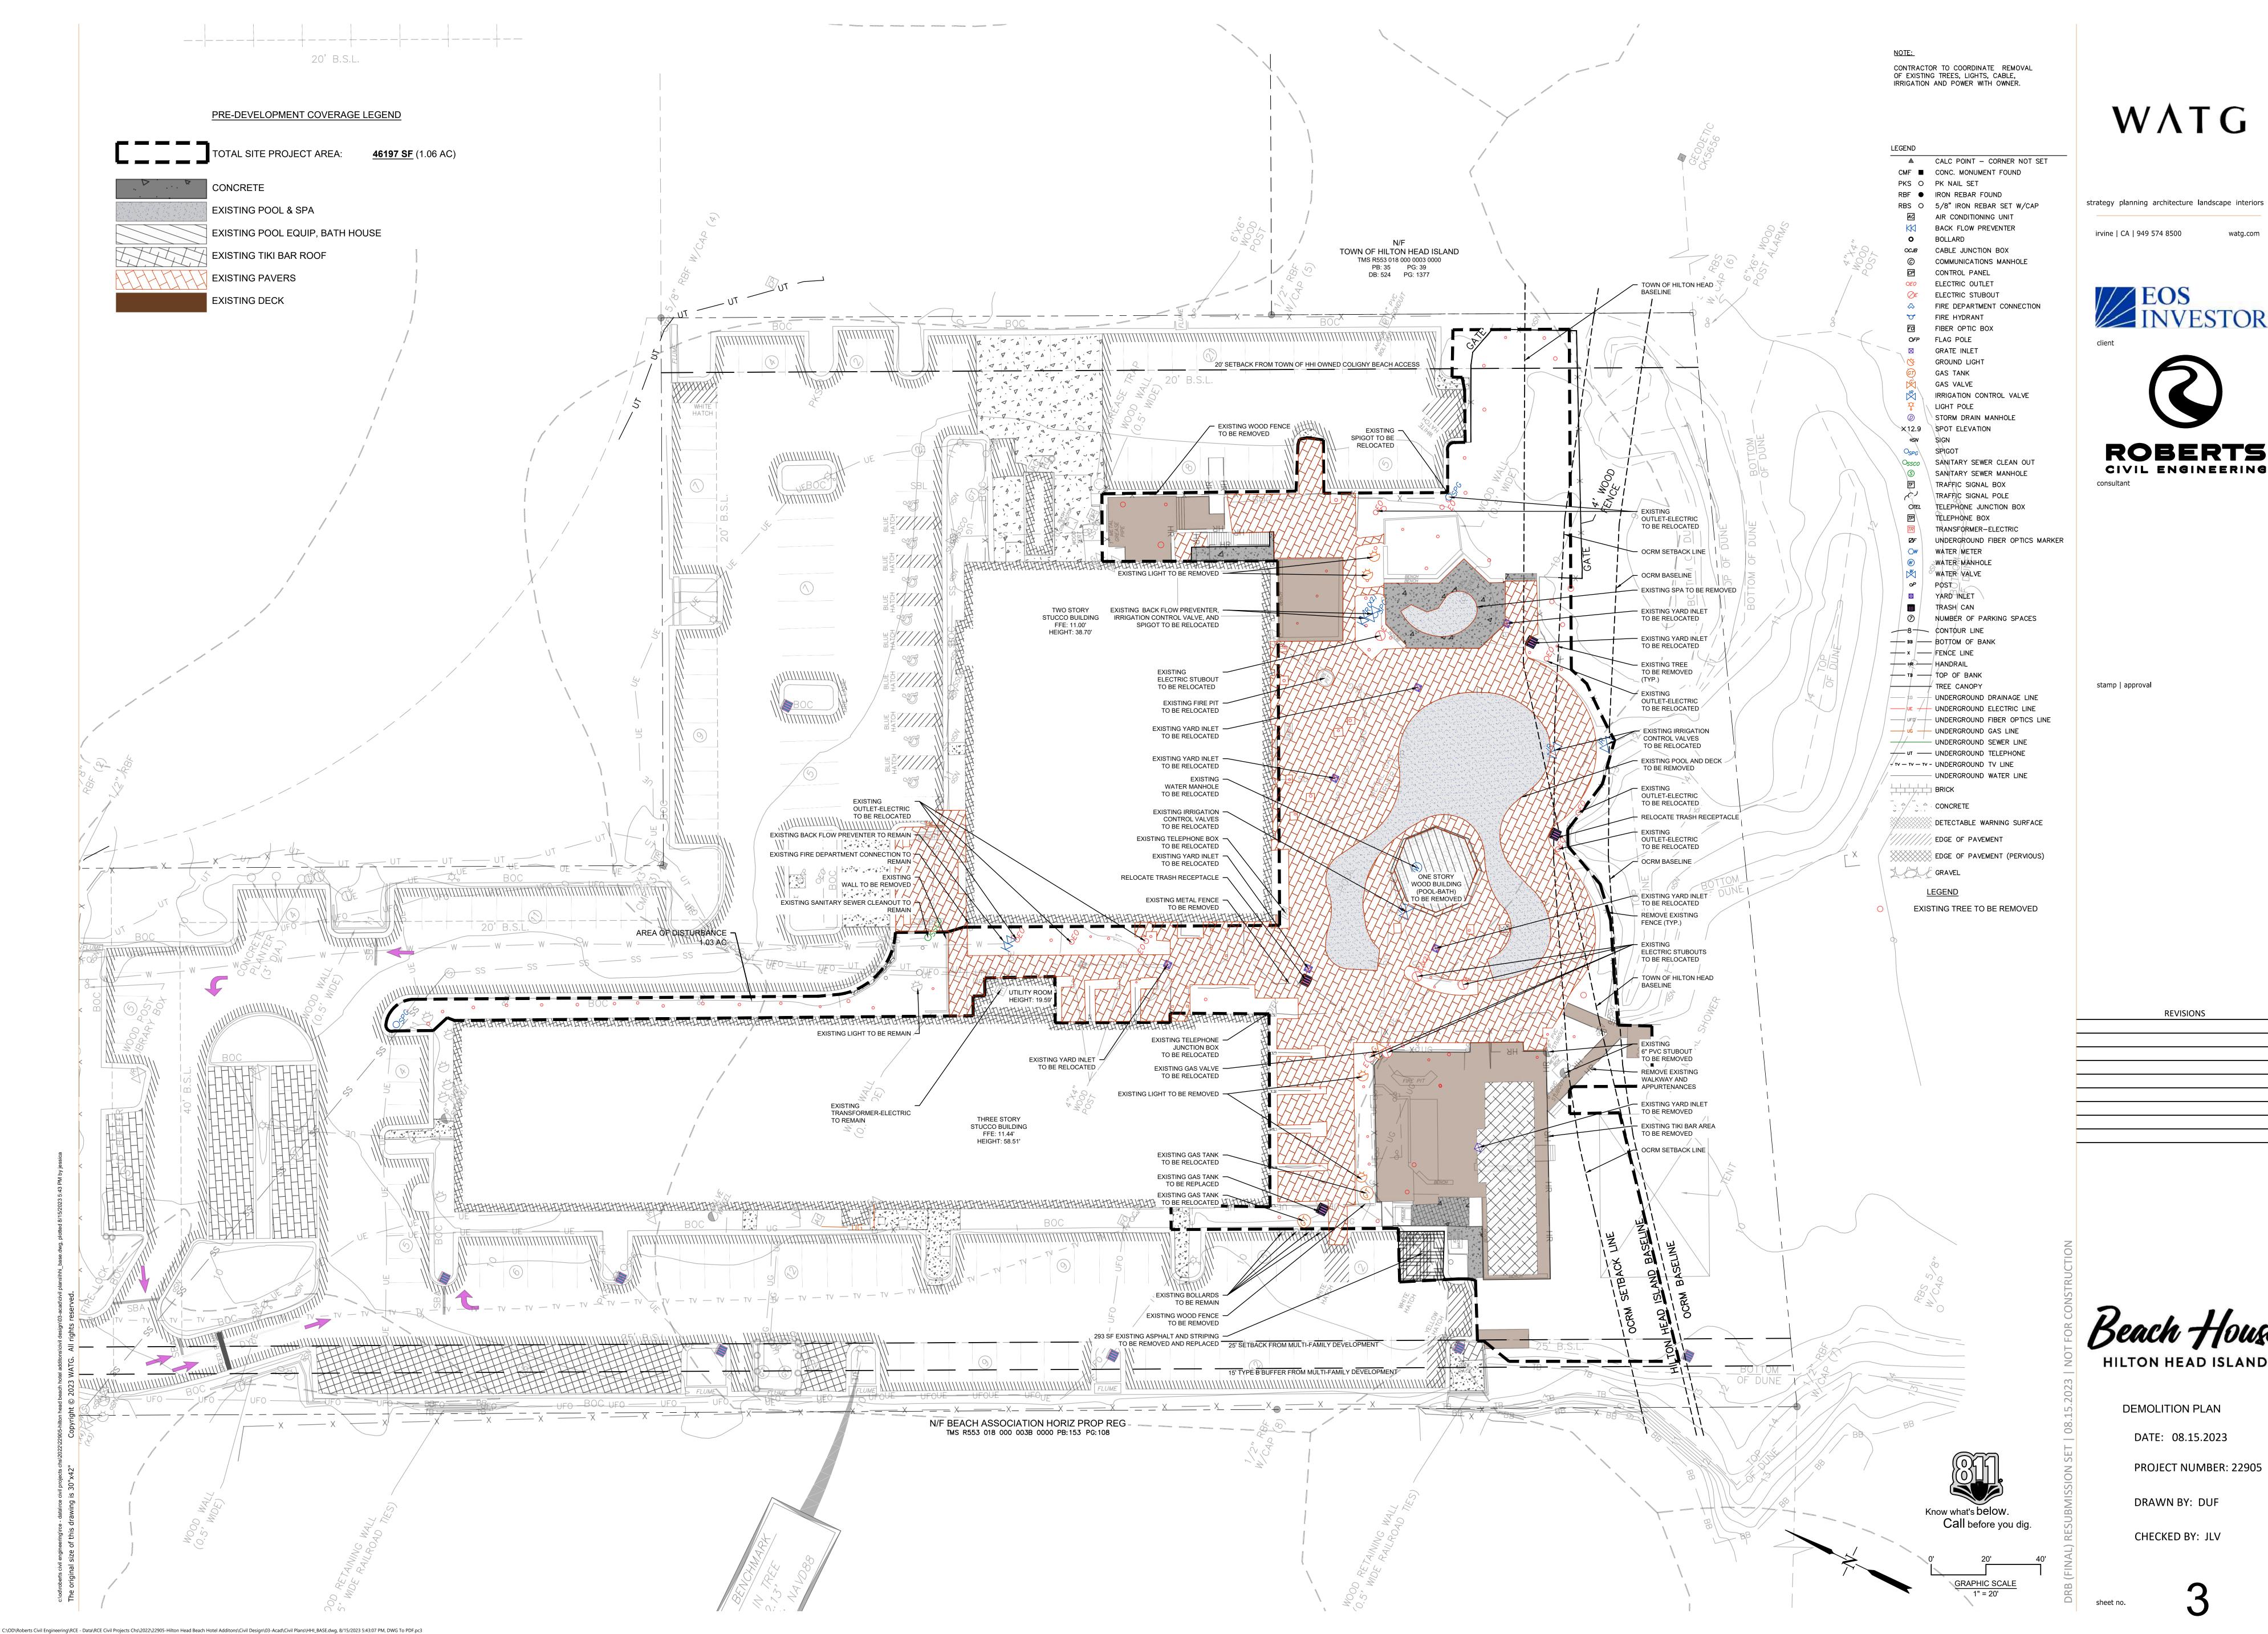





**REVISIONS** 


# HILTON HEAD ISLAND

**DEMOLITION PLAN** 

DATE: 08.15.2023

PROJECT NUMBER: 22905

DRAWN BY: DUF

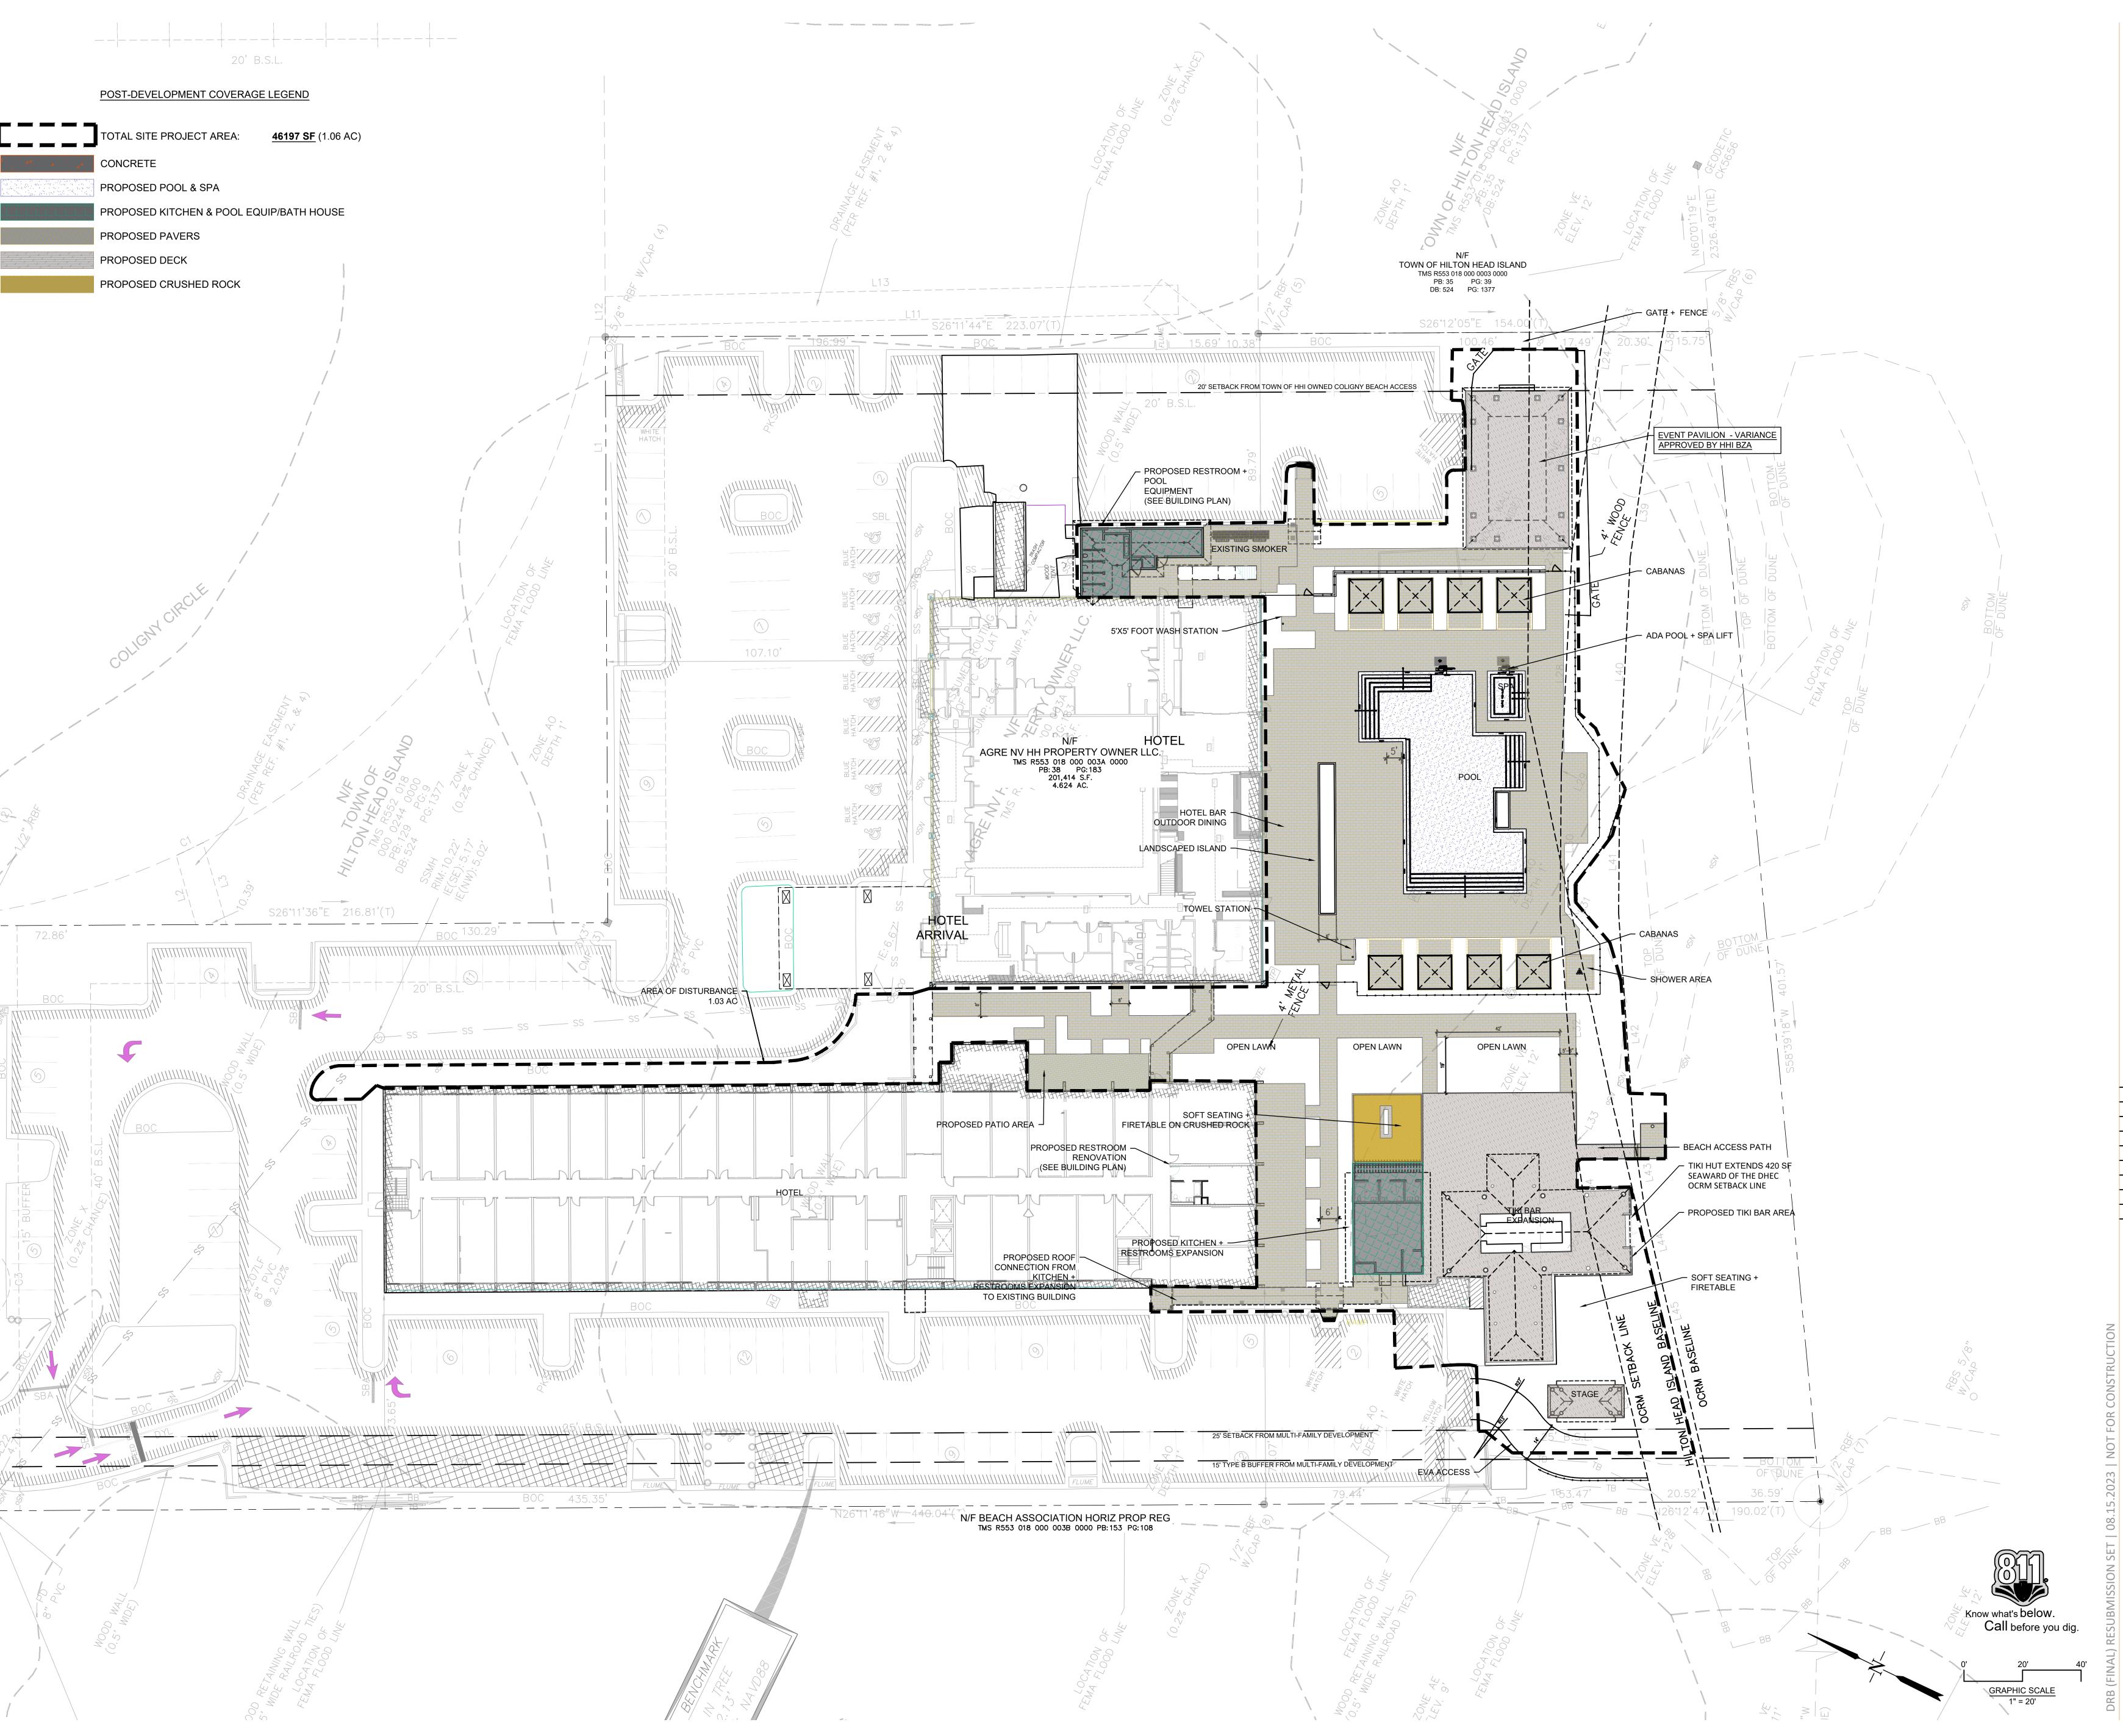

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Beach House
HILTON HEAD ISLAND

STAKING PLAN


DATE: 08.15.2023

PROJECT NUMBER: 22905

DRAWN BY: DUF

CHECKED BY: JLV

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EOS
INVESTORS

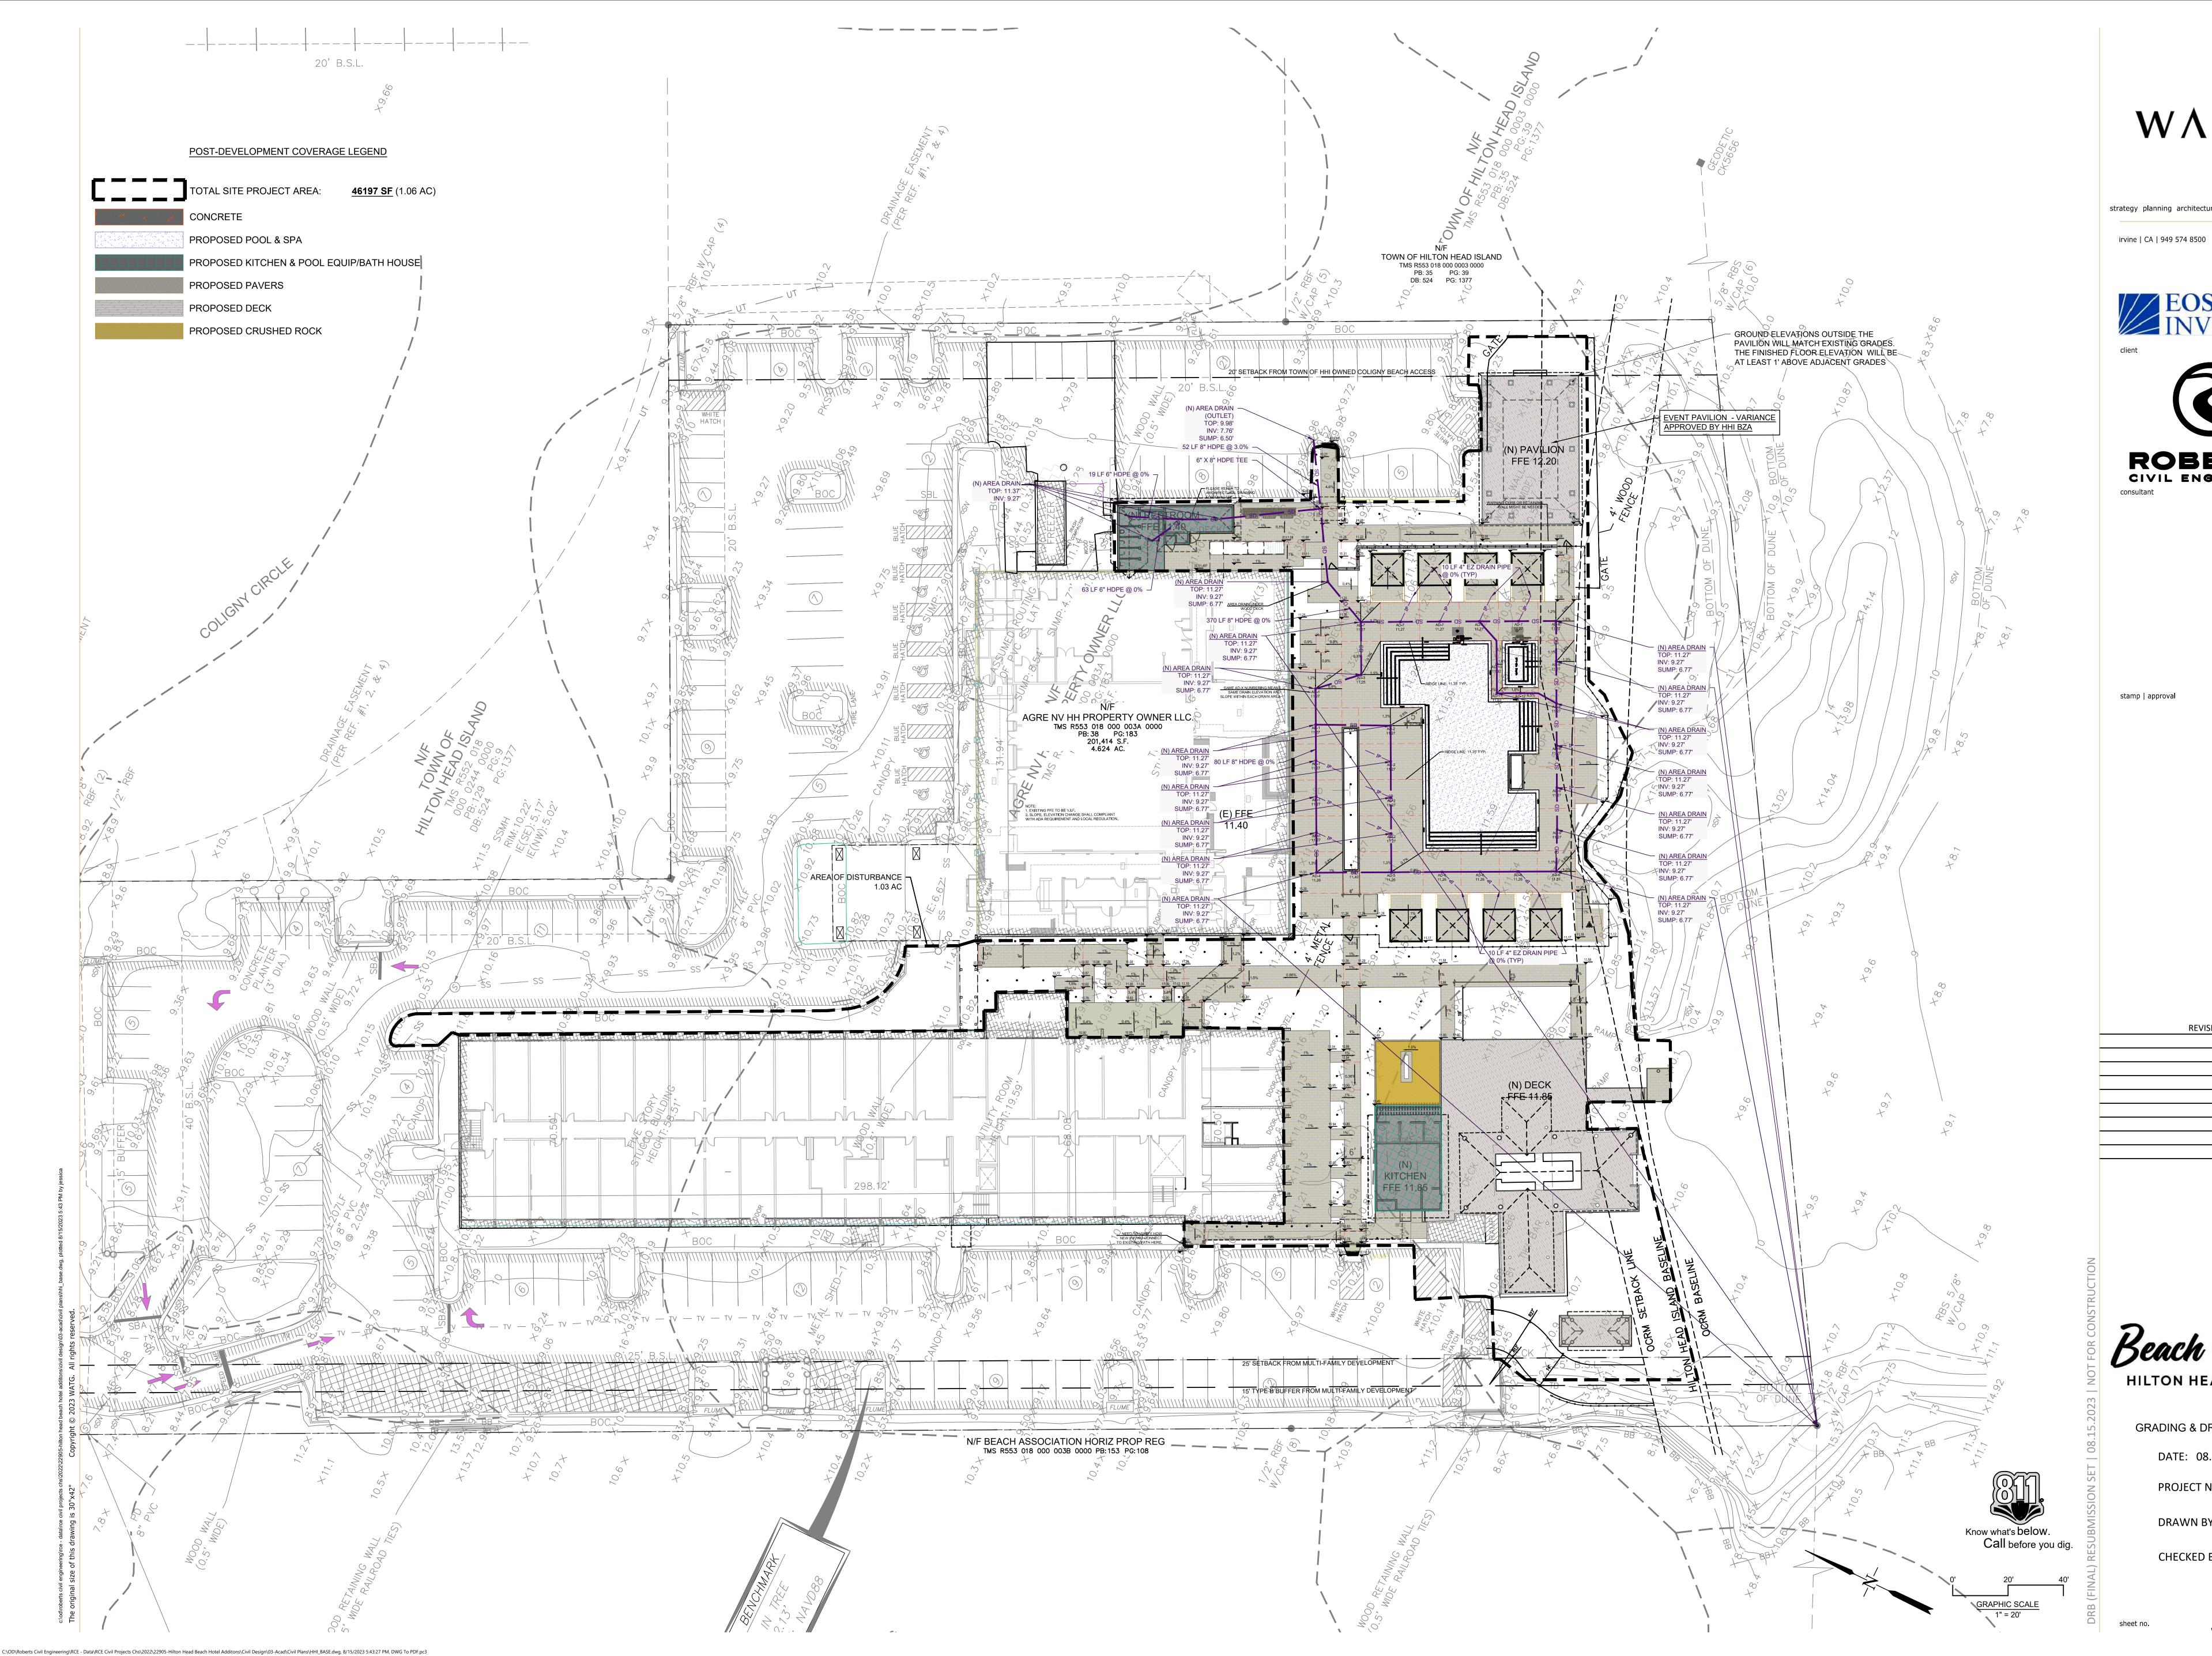

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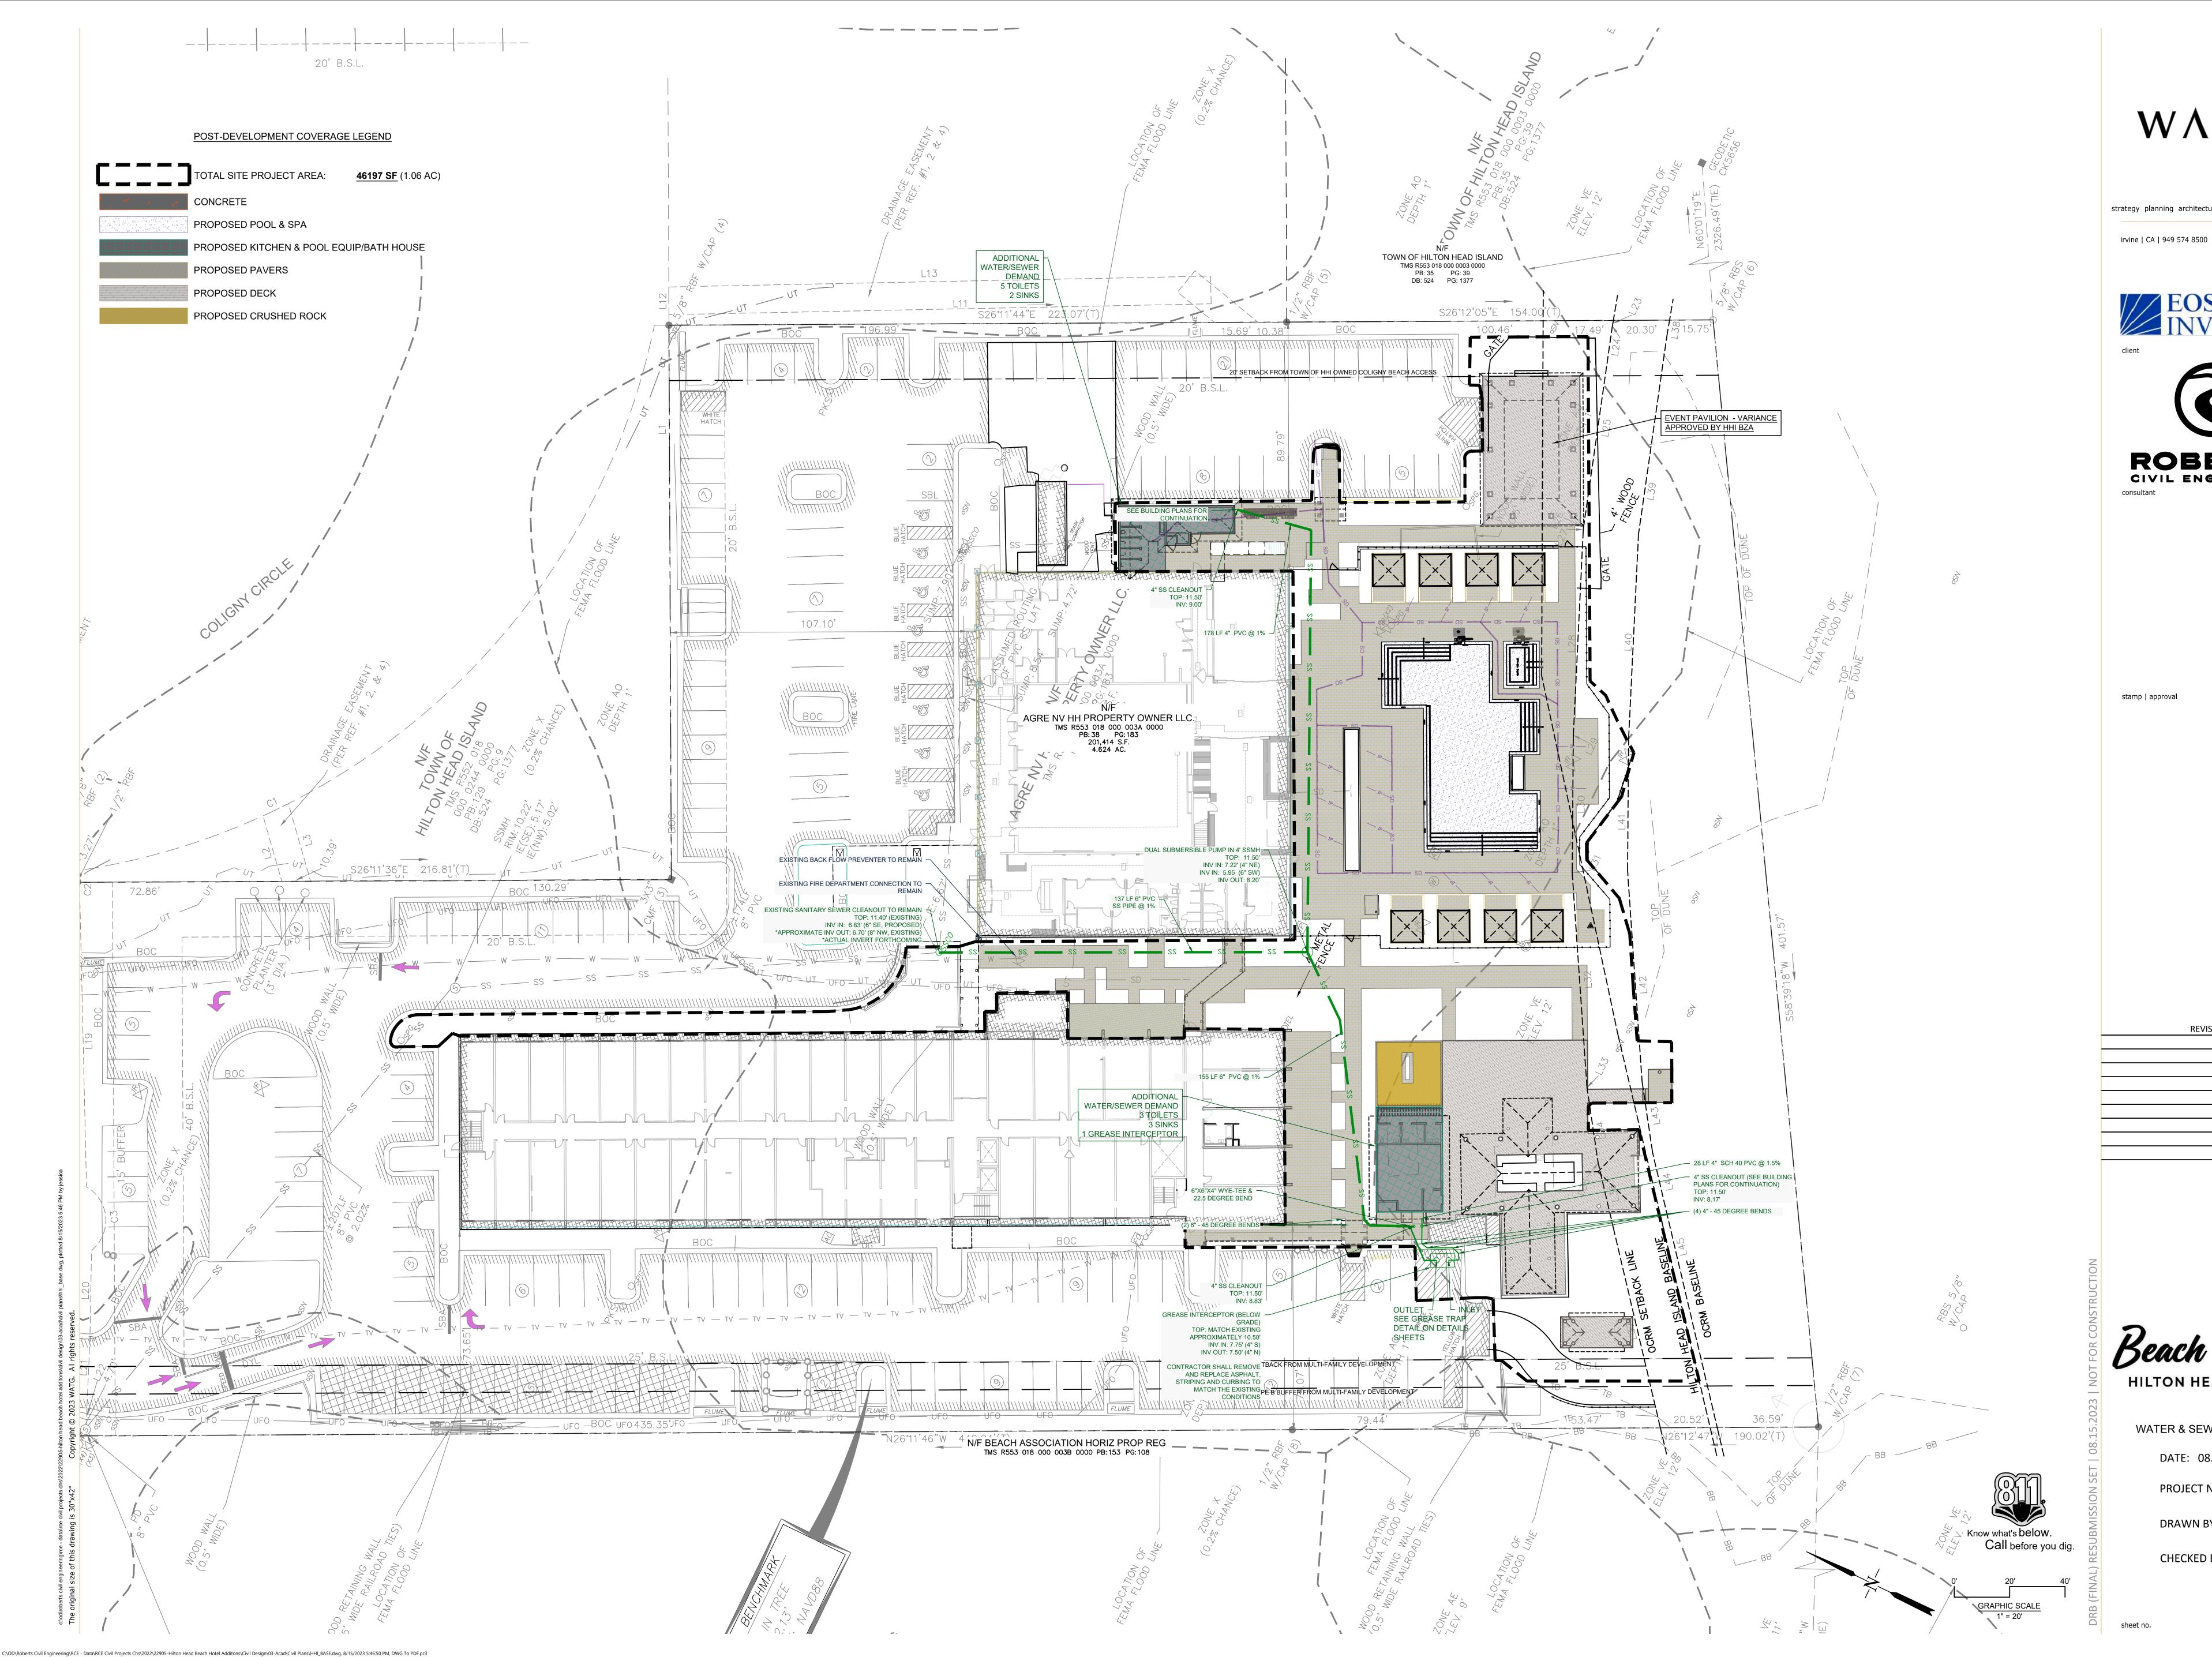
HILTON HEAD ISLAND

GRADING & DRAINAGE

DATE: 08.15.2023

PROJECT NUMBER: 22905

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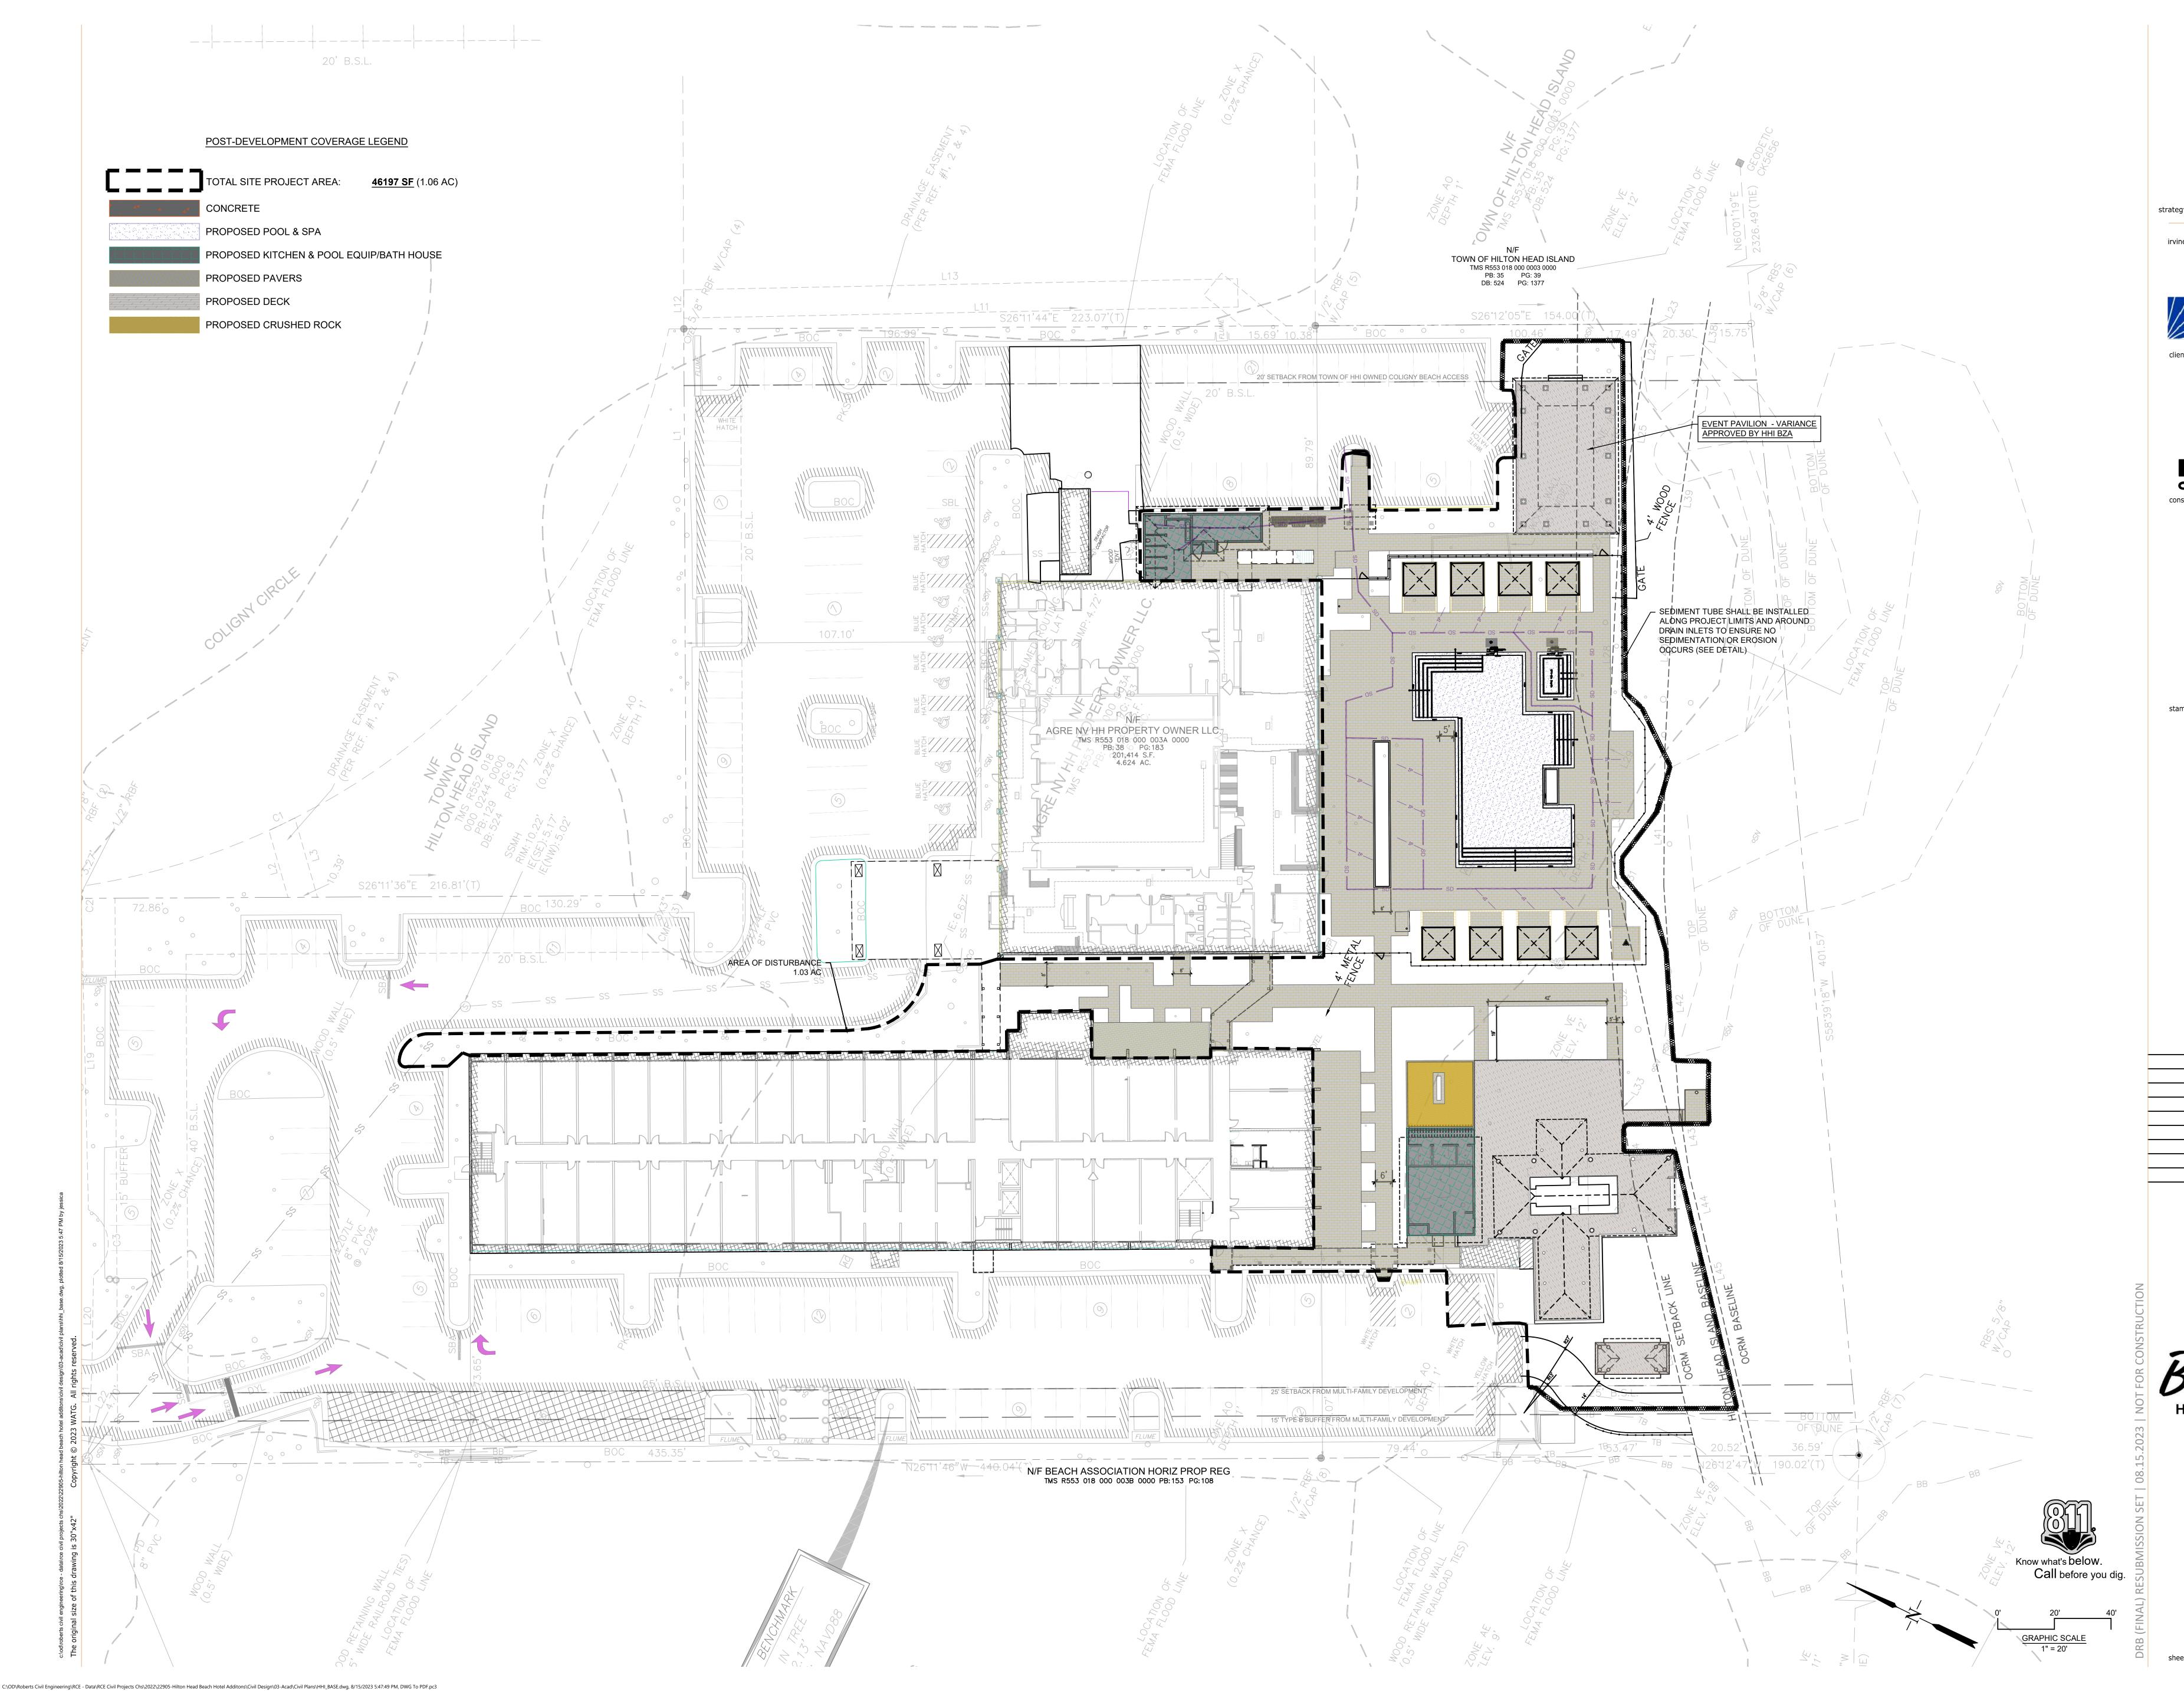
**REVISIONS** 

HILTON HEAD ISLAND

WATER & SEWER PLAN DATE: 08.15.2023

PROJECT NUMBER: 22905

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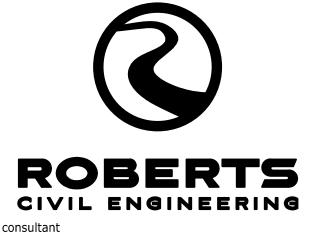


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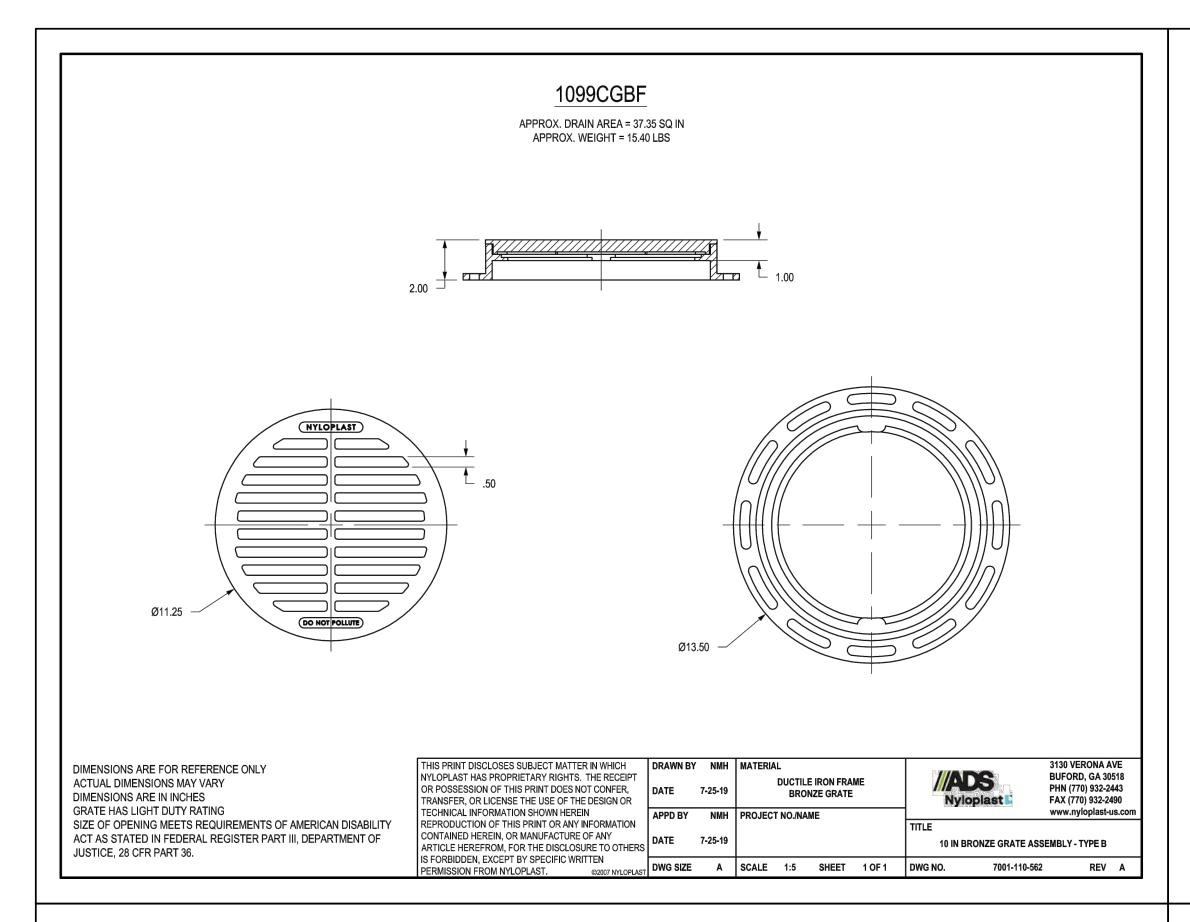
Beach House
HILTON HEAD ISLAND


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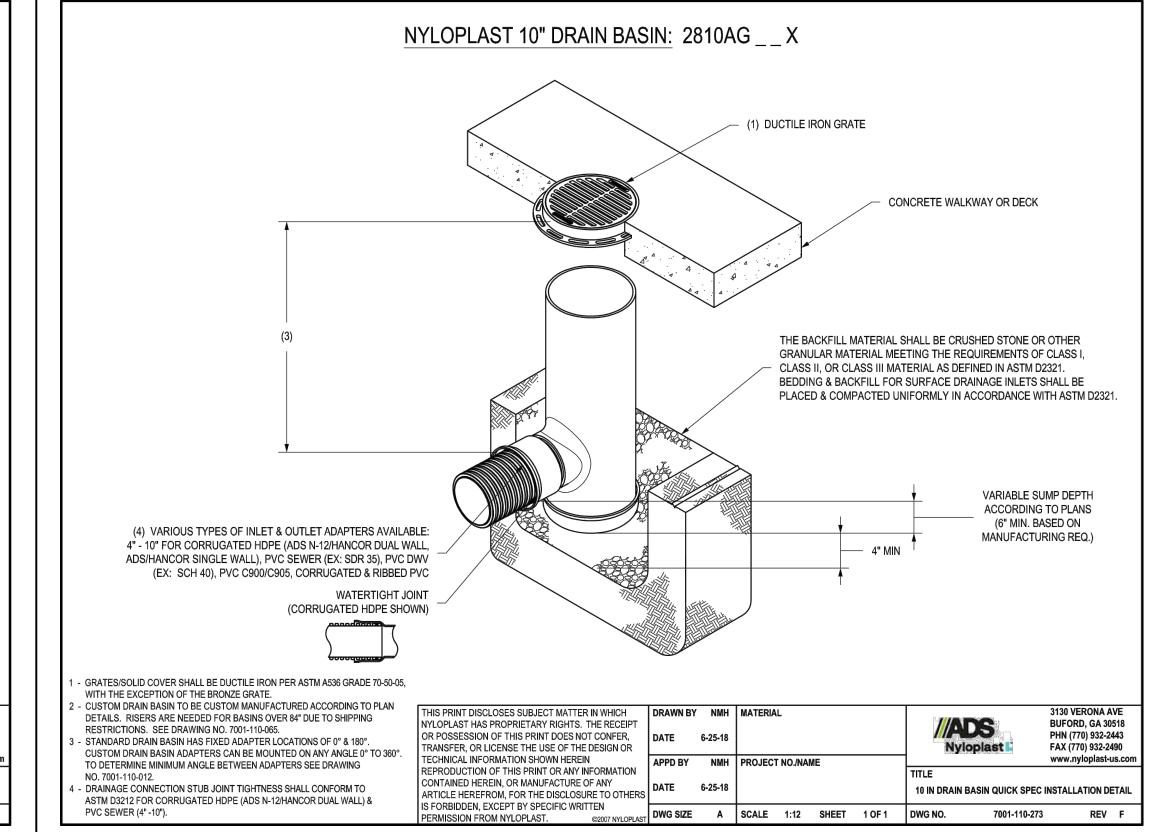
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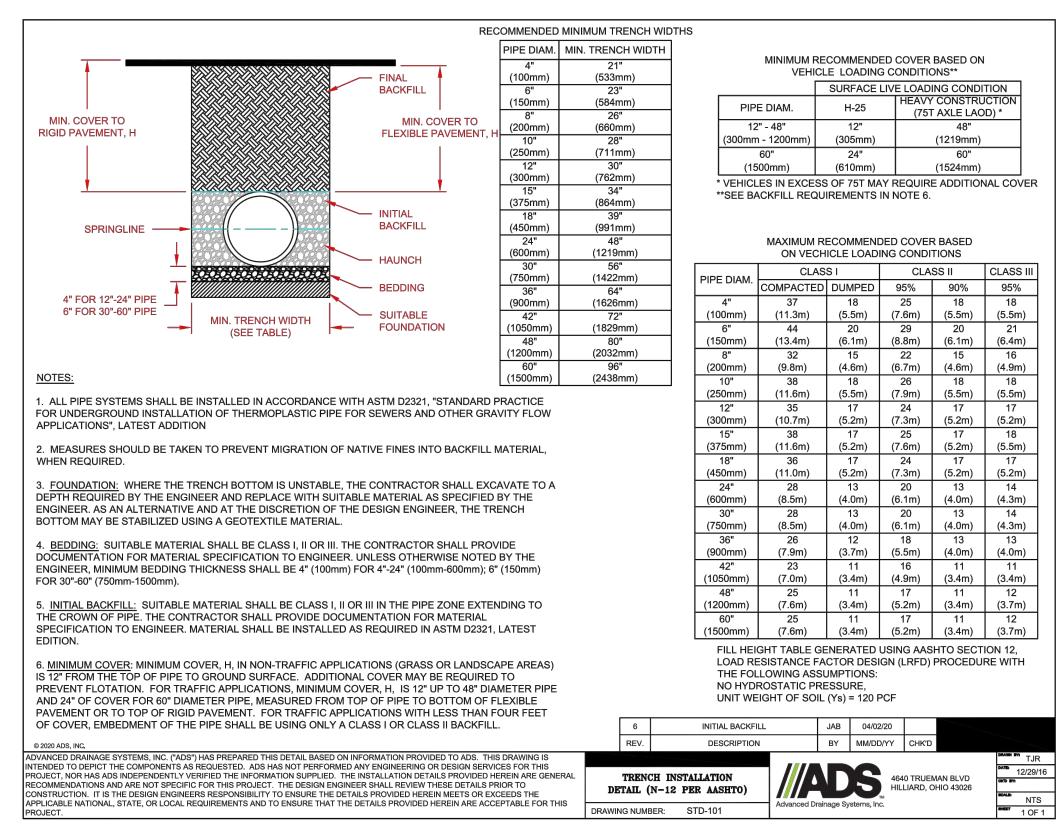
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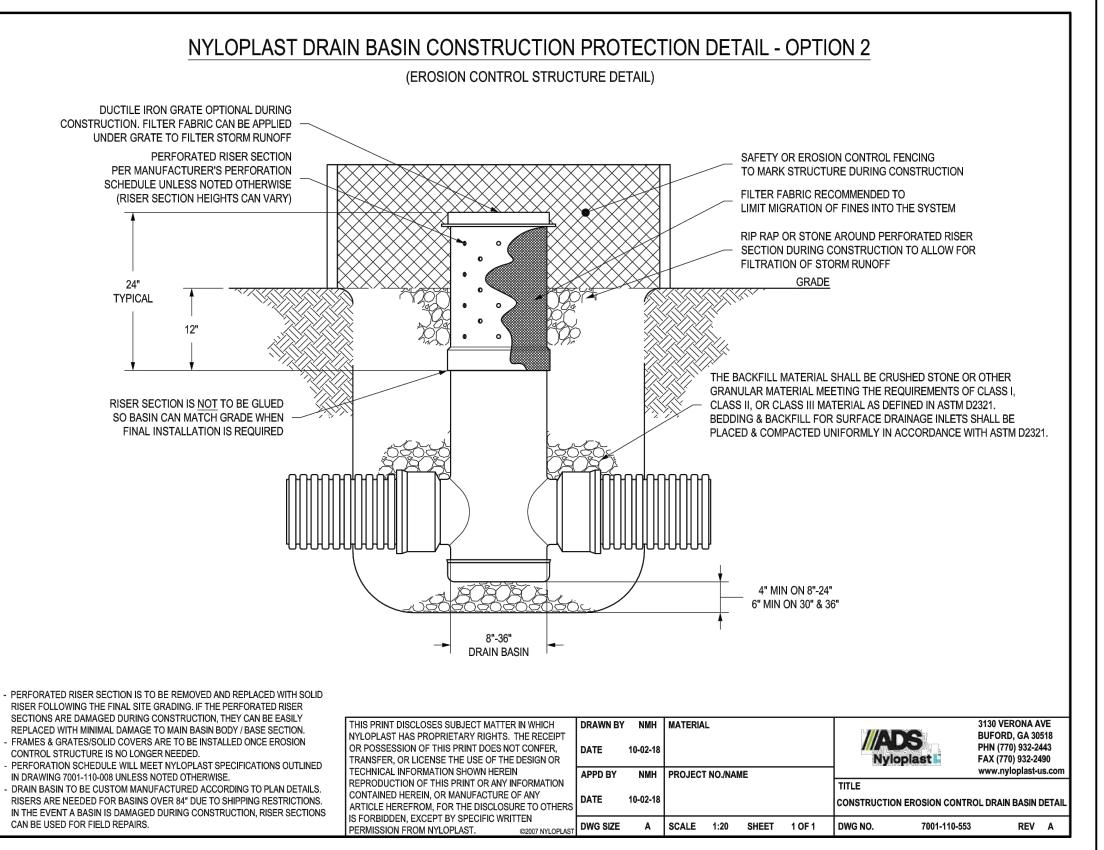
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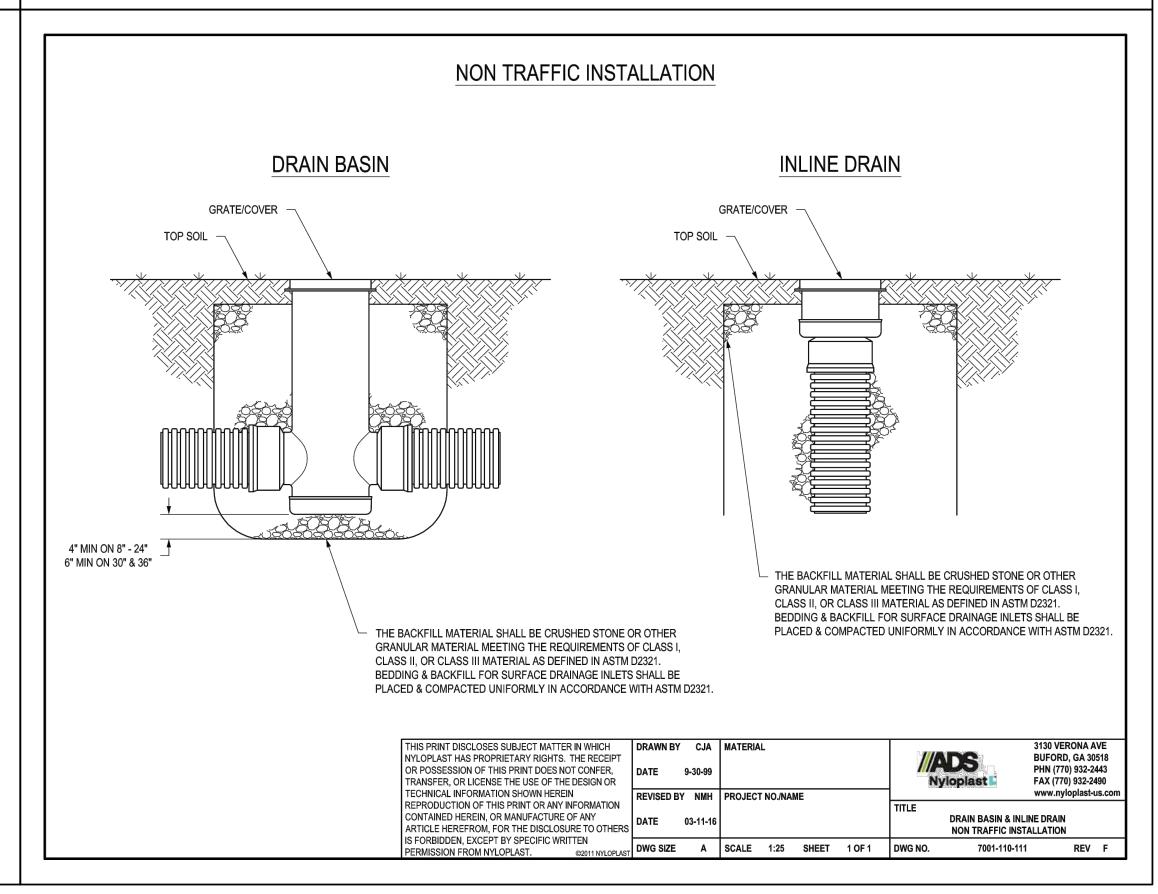










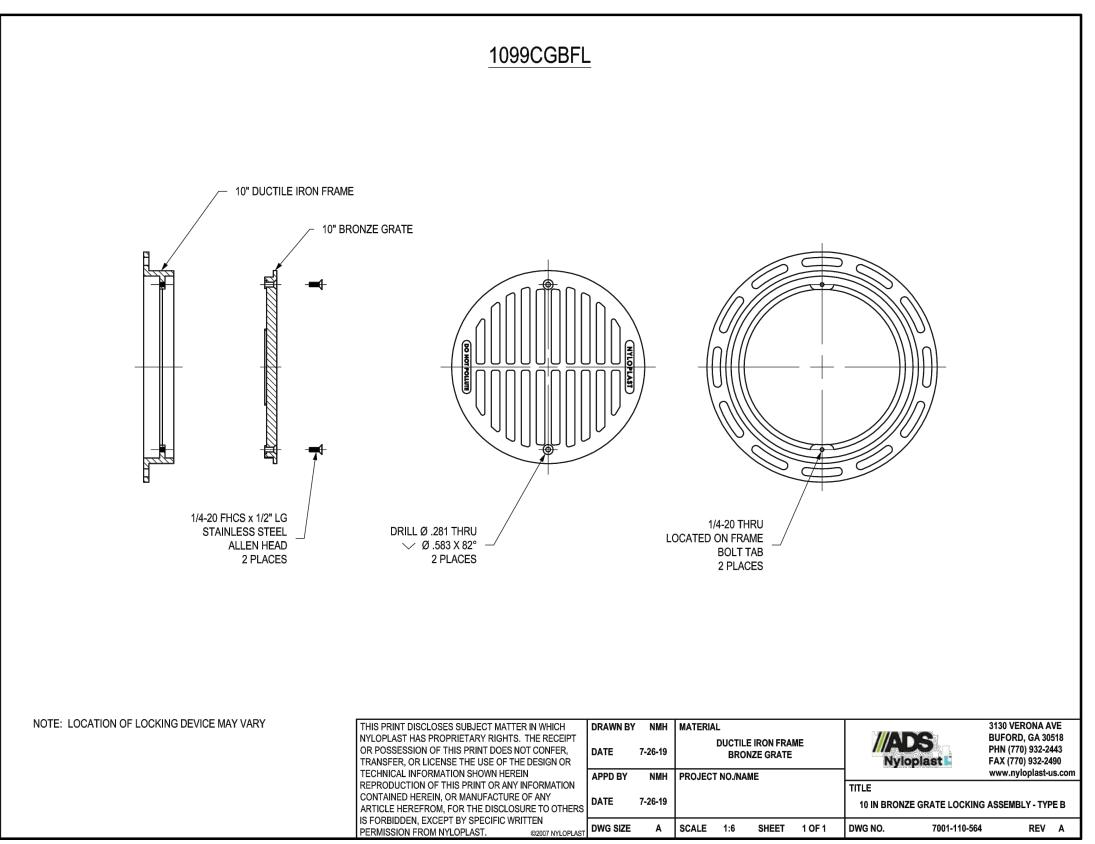

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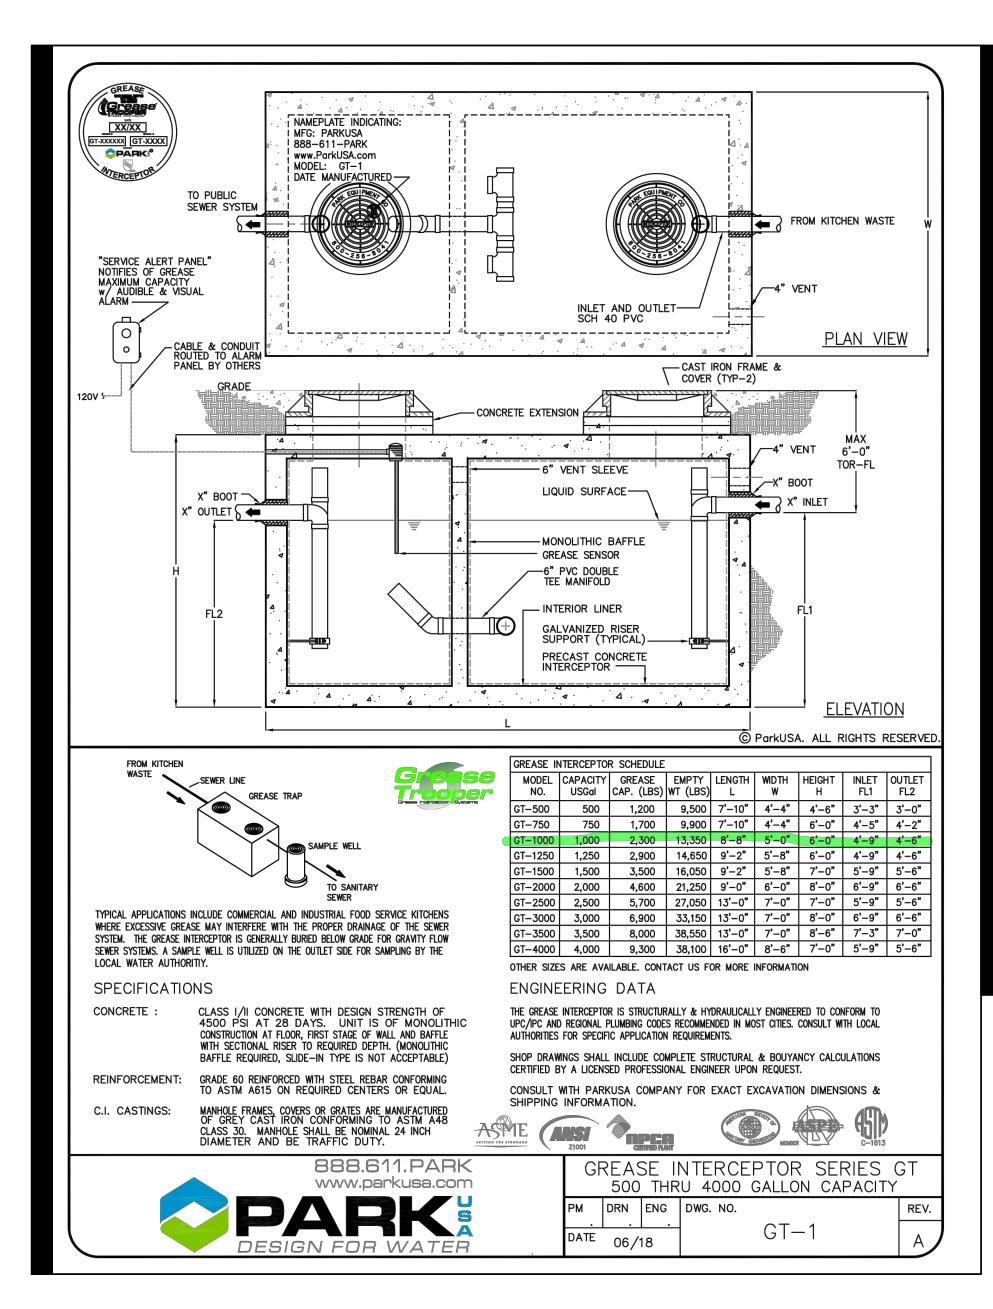
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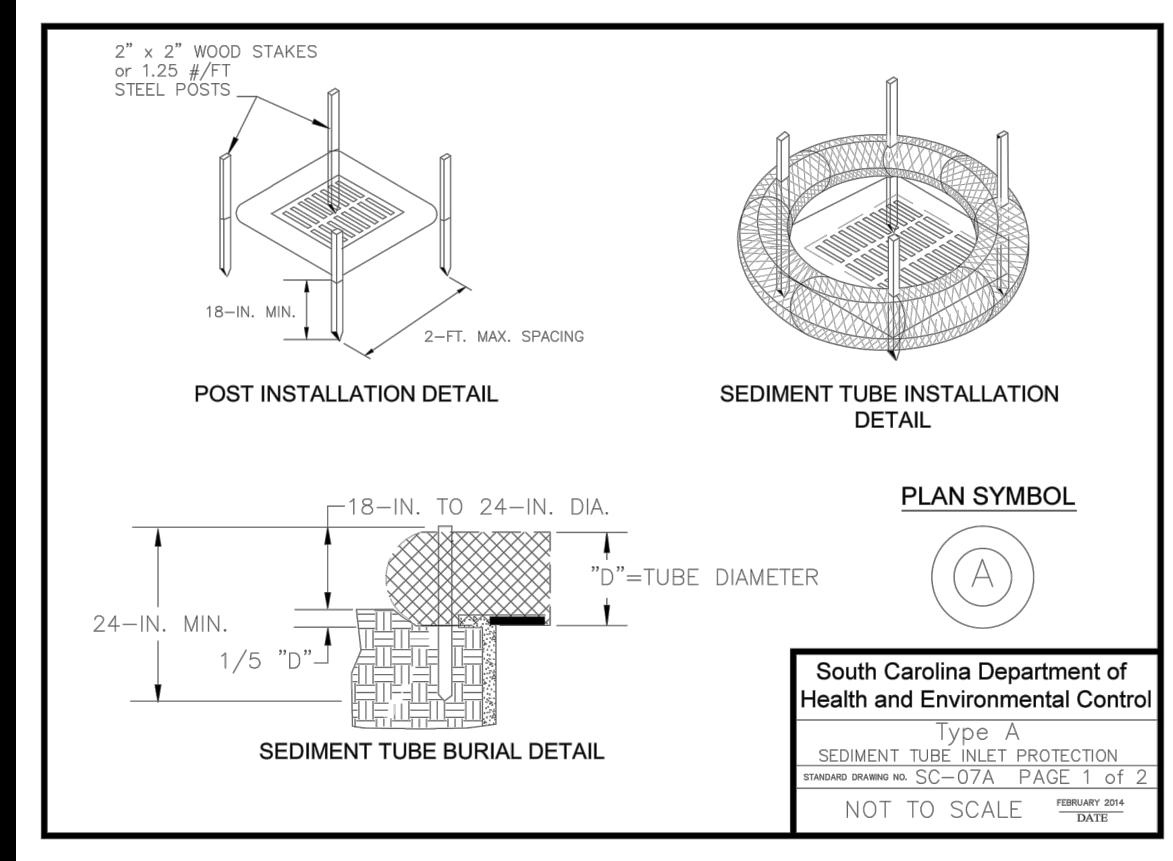
DRAWN BY: DUF

PROJECT NUMBER: 22905

CHECKED BY: JLV

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TYPE A - SEDIMENT TUBE INLET PROTECTION

GENERAL NOTES

Sediment tubes are elongated tubes of compacted curled excelsior wood, natural coconut fiber, or hardwood mulch. Straw, pine needle, and leaf mulch-filled sediment

tubes are not permitted. The outer netting of the sediment tube should consist of seamless, high—density polyethylene photodegradable materials treated with ultraviolet stabilizers or a seamless, high-density polyethylene non-degradable material.

- Sediment tube diameters shall range from 18-inches to 24-inches. Sediment tunes with smaller diameters are prohibited when used as inlet protection.
- Curled excelsior wood, or natural coconut products that are rolled up to create a sediment tube are not allowed.
- Sediment tubes should be staked using wooden oak stakes (2-inch X 2-inch) or steel posts (standard "U" or "T" sections with a minimum weight of 1.25 pounds per foot) at a minimum of 48—inches in length placed on 2—foot centers.
- Install all sediment tubes to ensure that no gaps exist between the soil and the bottom of the tube. Manufactuer's recommendations should always be consulted before
- The ends of adjacent sediment tubes should be overlapped 6-inches to prevent flow and sediment from passing through
- Sediment tubes should not be stacked on top of one another. ). Each sediment tube should be installed in a trench with a
- 10. Install stakes at a diagonal facing incoming runoff.

depth equal to 1/5 the diameter of the sediment tube.

INSPECTION & MAINTENANCE

- 1. The key to functional inlet protection is weekly inspections, routine maintenance, and regular sediment removal.
- 2. Regular inspections of sediment tube inlet protection shall be conducted once every calendar week and, as recommended, within 24-hours after each rainfall even that produces 1/2-inch or more of precipitation.
- 3. Attention to sediment accumulations in front of the sediment tube is extremely important. Accumulated sediment should be continually monitored and removed when necessary.
- 4. Remove accumulated sediment when it reaches 1/3 the of the sediment tube. When a sump is installed in front of inlet protection, sediment shall be removed when if fills approximately 1/3 the depth of the sump.
- 5. Removed sediment shall be placed in stockpile storage areas or spread thinly across disturbed area. Stabilize the removed sediment after it is relocated.
- 6. Large debris, trash, and leaves should be removed from in front of tubes when found.
- 7. Inlet protection structures should be removed after the disturbed areas are permanently stabilized. Remove all construction material and sediment, and dispose of them properly. Grade the disturbed area to the elevation of the inlet structure crest. Stabilize all bare areas immediately.

South Carolina Department of Health and Environmental Control

Type A SEDIMENT TUBE INLET PROTECTION randard drawing no. SC-07A PAGE 2 of

NOT TO SCALE

FEMA (FIRM) FLOOD ZONE DESCRIPTIONS:

FLOOD ZONE AO (1) River or stream flood hazard areas, and areas with a 1% or greater chance of shallow flooding each year, usually in the form of sheet flow, with an average depth ranging from 1 to 3 feet. These areas have a 26% chance of flooding over the life of a 30-year mortgage.

 Have the lowest floor elevated to at least as high as the depth number specified on the Flood Insurance Rate Map, in feet, above the highest adjacent grade or eleven (11) feet above mean sea level, whichever is higher, or

· Be completely floodproofed together with attendant utility and sanitary facilities to or above the depth number so that any space below that level is watertight with walls substantially impermeable to the passage of water and with structural components having the capability of resisting hydrostatic and hydrodynamic loads and effects of buoyancy.

FLOOD ZONE VE (12)

- Coastal areas with a 1% or greater chance of flooding and an additional hazard associated with storm waves.
- These areas have a 26% chance of flooding over the life of a 30-year mortgage. · All structures shall be elevated so that the bottom of the lowest horizontal supporting member is located no lower

than three (3) feet above the base flood elevation level or thirteen (13) feet above mean sea level, whichever is higher.


ZONE AE

ELEV. 9'

FLOOD ZONE X AND X-SHADED Area of moderate flood hazard, usually the area between the limits of the 100-year and 500-year floods. Nonresidential structures must be constructed so that the lowest floor is elevated no lower than two (2) feet above the

base flood elevation or eleven (11) feet above mean sea level, whichever is higher.

- FLOOD ZONE AE (9) The base floodplain where base flood elevations are provided. AE Zones are now used on new format FIRMs
- instead of A1-A30 Zones. Nonresidential structures must be constructed so that the lowest floor is elevated no lower than two (2) feet above the base flood elevation or eleven (11) feet above mean sea level, whichever is higher.

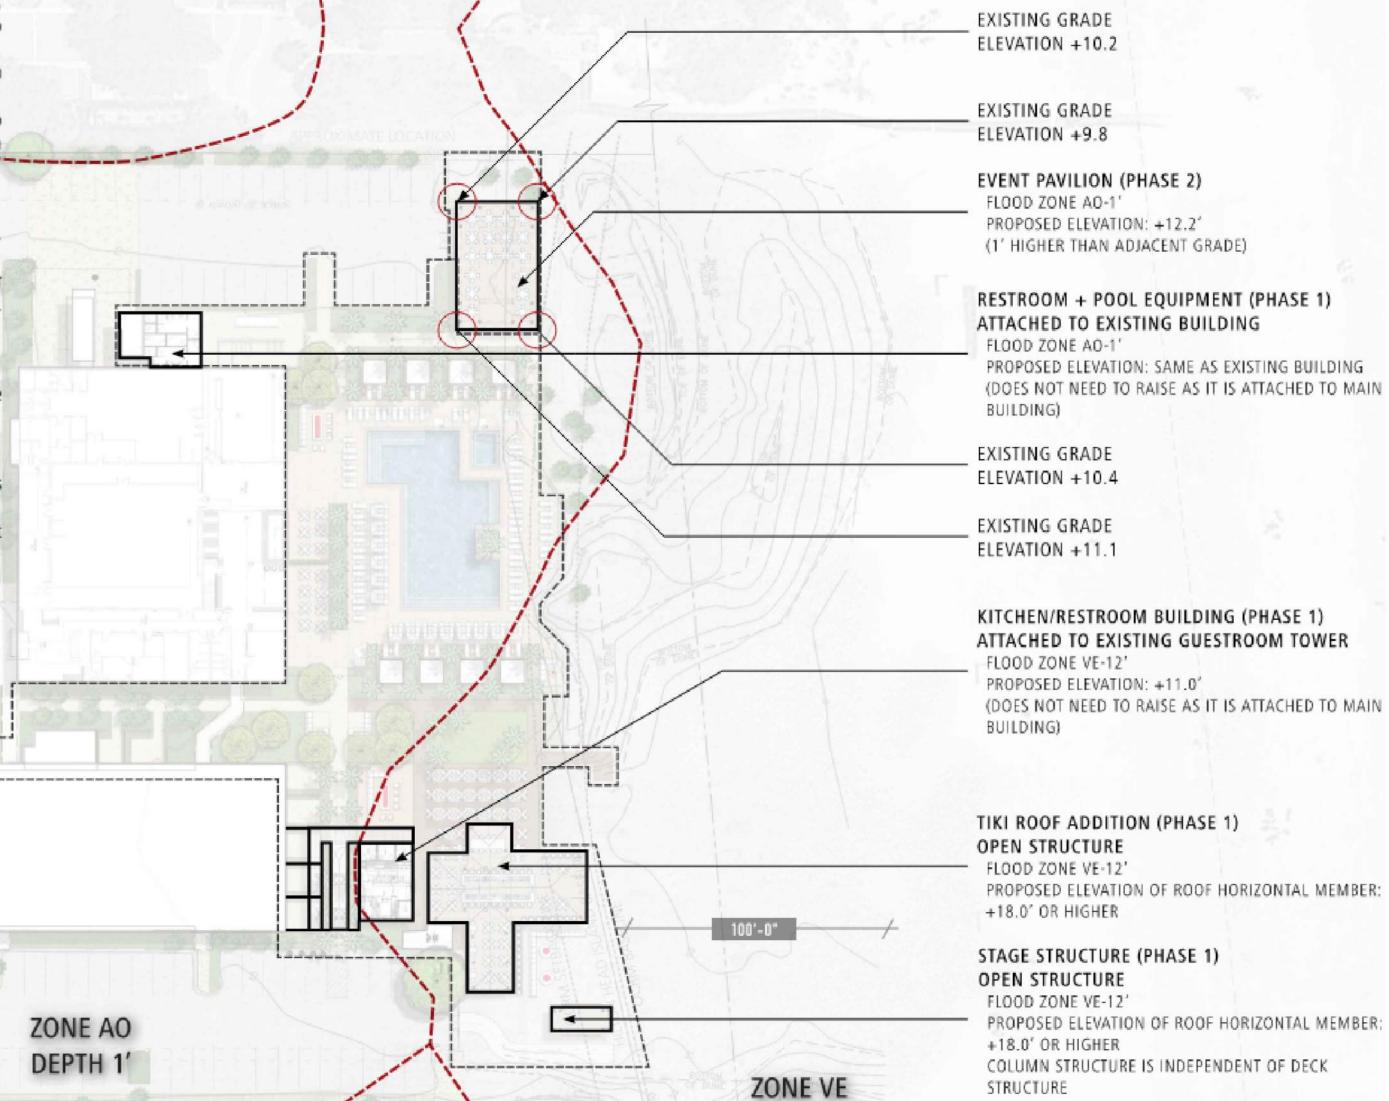

**ZONE AE** 

ELEV. 9'

ELEV. 12'

WATG HILTON HEAD BEACH HOUSE RENOVATION HILTON HEAD ISLAND, SOUTH CAROLINA

ZONE X

(0.2% CHANCE)

SITE FLOODPLAIN DIAGRAM | DRB-111 DRB CONCEPT SUBMITTAL - PROPOSED DEVELOPMENT | 29 NOVEMBER 2022 WATG

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ROBERTS CIVIL ENGINEERING

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REVISIONS

CONSTRUCTION DETAILS

DATE: 07.11.2023

PROJECT NUMBER: 22905

DRAWN BY: DUF

CHECKED BY: JLV

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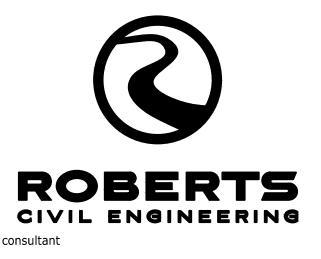
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# Beach House HILTON HEAD ISLAND

SITE COVERAGE - CURRENT

DATE: 05.22.2023

PROJECT NUMBER: 22905

DRAWN BY: DUF

CHECKED BY: JLV


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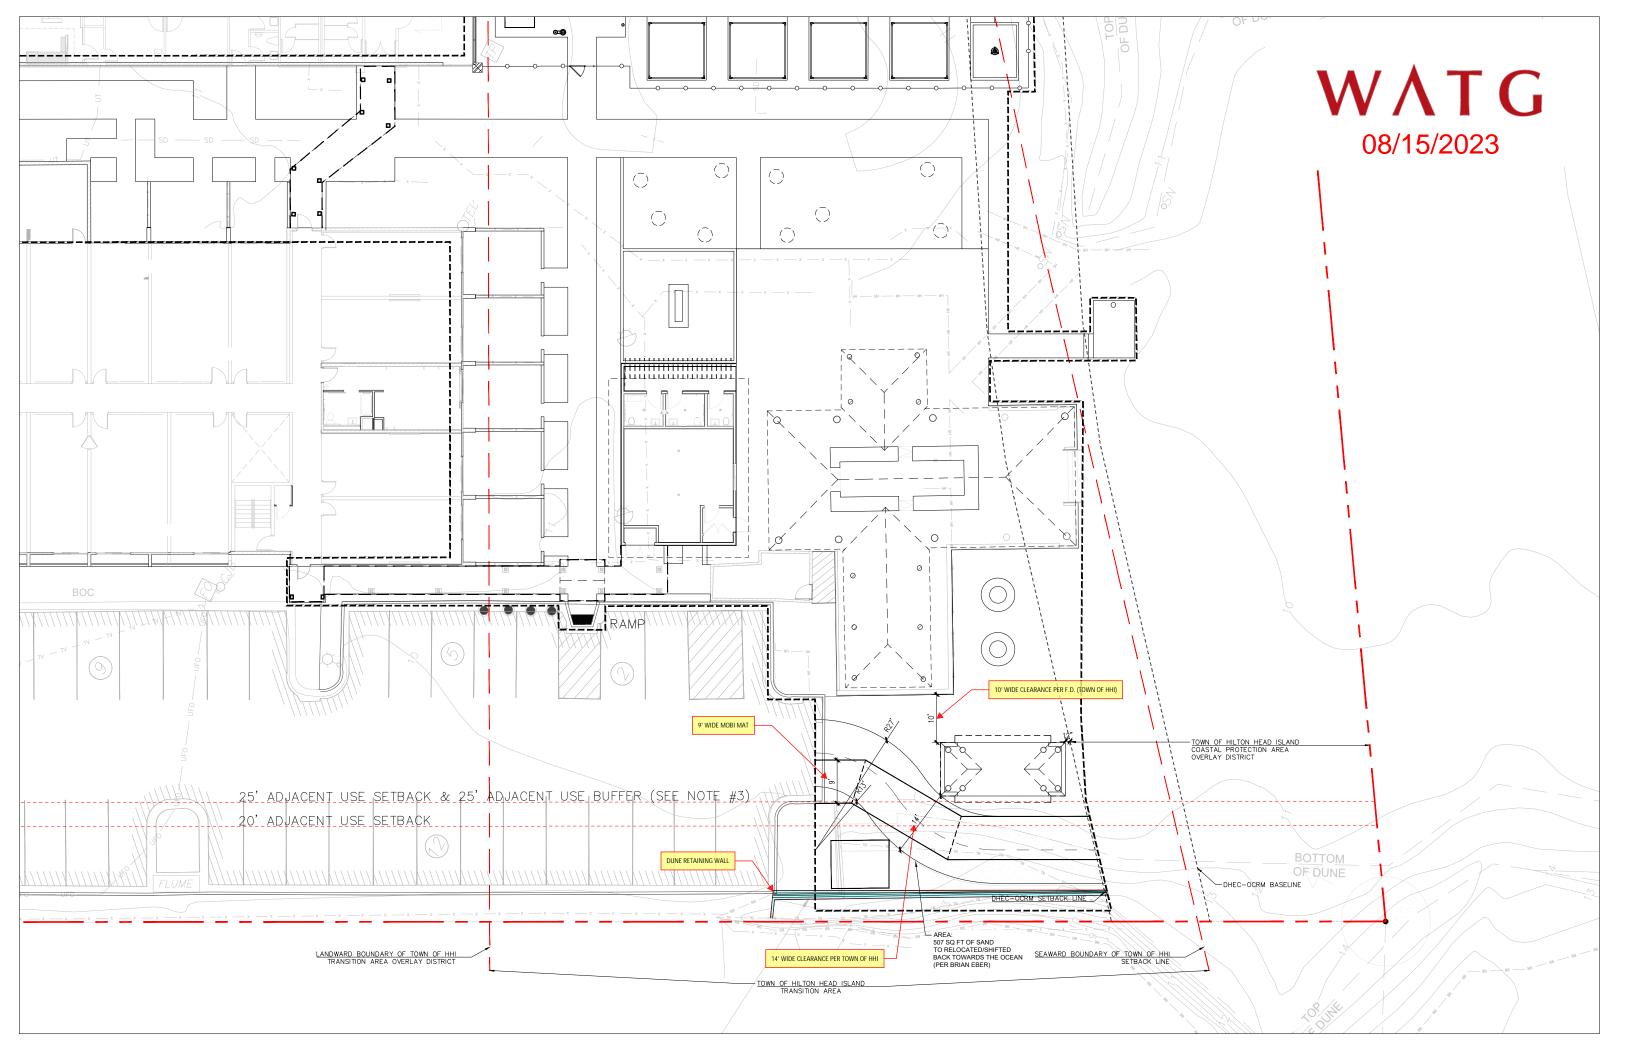
Know what's below.

Call before you digg.

20' 40'

GRAPHIC SCALE
1" = 20'



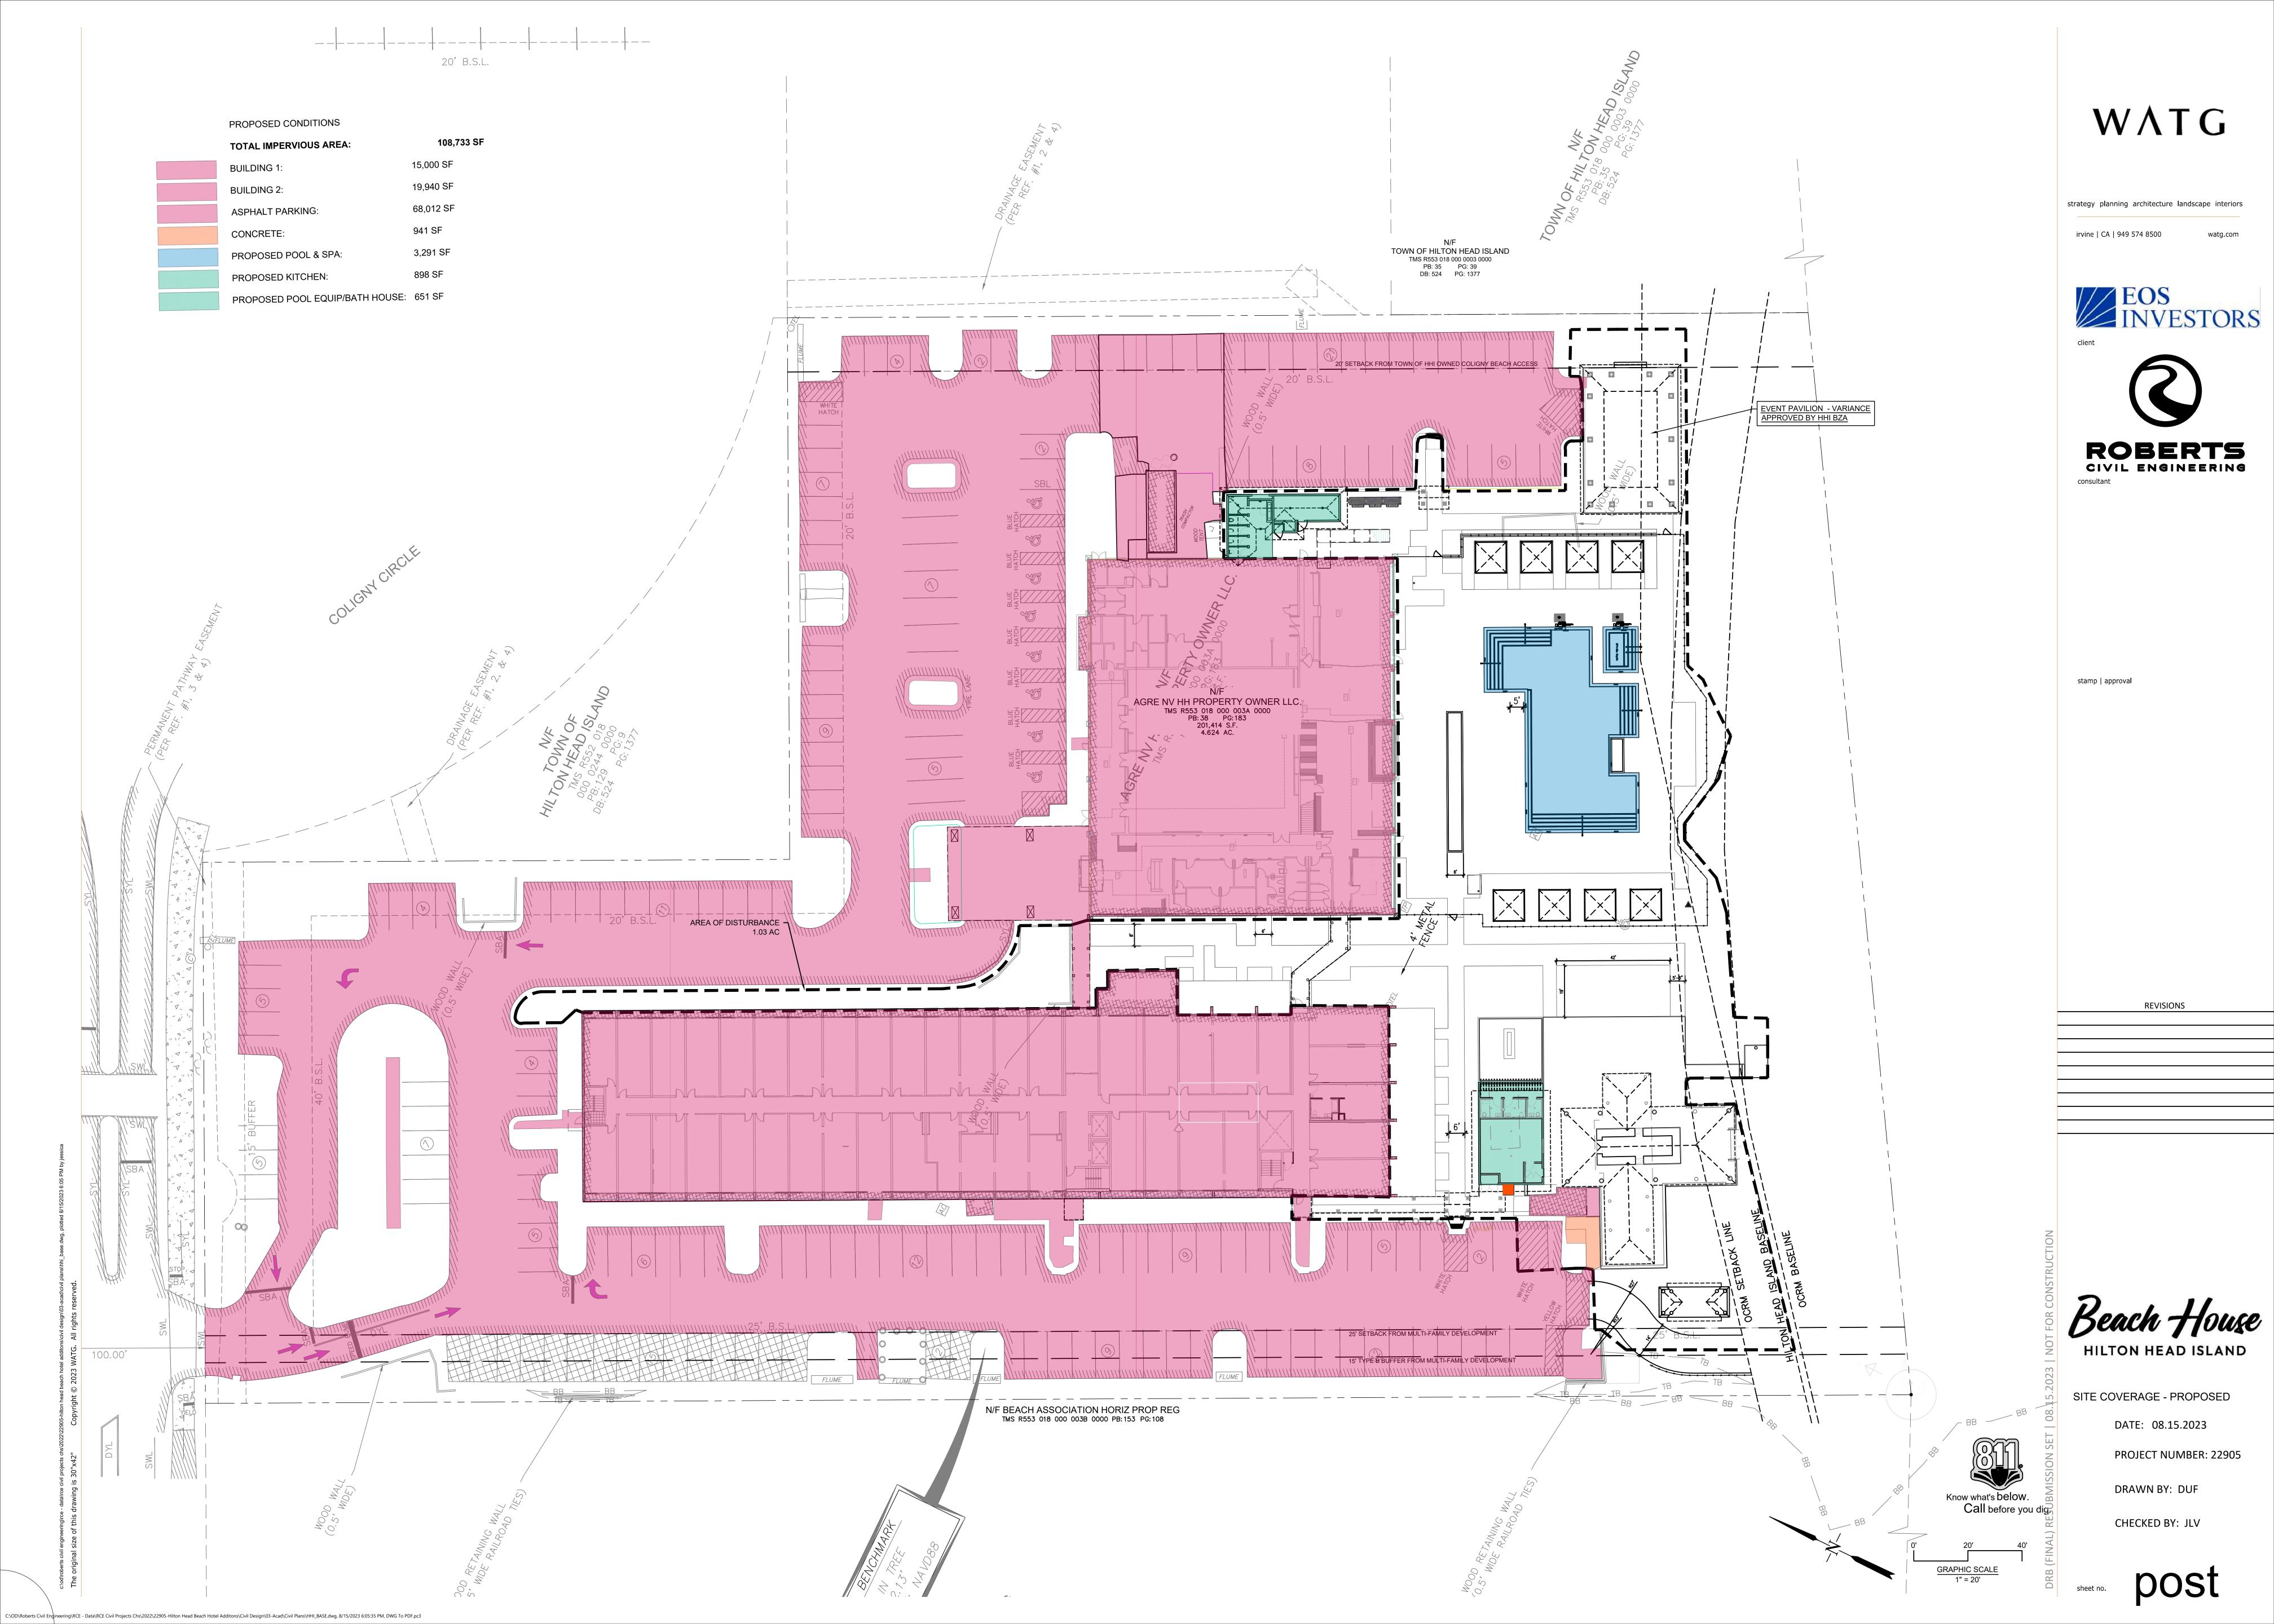

## **DESIGN TEAM/DRB COMMENT SHEET**

The comments below are staff recommendations to the Design Review Board (DRB) and do NOT constitute DRB approval or denial.

PROJECT NAME: Beach House – 1 South Forest Beach Final – Phase 1 & 2	DRB#: DRB-001563-2023			
DATE: 8/22/2023				
RECOMMENDATION: Approval	Denial			
MISC COMMENTS & CONDITIONS				
1. Staff recommends approval with the following conditions:				
a. Final approval under DPR-00742-2023 does not cause any conflict with the conditionally approved Final Design. If it				
does, the applicant shall return to DRB for one final approval. This especially relates to the lighting plan, and the pool				
lighting that currently shows greater than 3500k.				
b. Final approval from Forest Beach ARB that does not conflict with the conditionally approved Final Design. If it does, the				
applicant shall return to DRB for one final approval. This is especially as it relates to the parking considerations near the pavilion.				
2. Please clarify R-3, under fence/gate/rail schedule on sheet L3-201 and L3-001, one says "Wood Piles with Wood Panels" and				
the other says Dune Wall cladding. Match to Sheet L3-405, detail 4 – Dune Wall Cladding				